McC | Architecture pllc

25 n. dutcher st., irvington, ny 10533 | mcc-architecture.com t: 917.887.0975 | e: dmcclure@mcc-architecture.com

NOTE

PROJECT INFORMATION:

Additions alterations
MOY RESIDENCE
66 EDGARDS LN
66 EDGAR

REV. #/DATE

MOY RESIDENCE

66 EDGARDS LN. • HASTINGS ON HUDSON, NY

DRAWING LIST:

ARCHITECTURAL:
SP1.0 SITE
D1.0 DEMOLITION PLANS
A1.1 CONSTRUCTION PLANS
A1.2 ROOF PLANS
A2.0 EXTERIOR ELEVATIONS,
SECTION & DETAILS
A3.0 INTERIOR ELEVATIONS

E1.0 LIGHTING/POWER PLANS

DRAWING TITLE:

DRAWING INFO.



CLIMATIC & GEOGRAPHIC DESIGN CRITERIA

| SERVICE & SESSION THIS BESIGN SKITERY | | | | | | | | | | | | |
|---------------------------------------|--------------------------|----------------------|--------------------|-----------------------|----------------------|-----------------------|---------------------------|------------|----------------------|--|----------|--------|
| GROUND | WIND SPD | SEISMIC DSGN | SUB | SUBJECT DAMAGE FROM | | WINTER | ICE BARRIER | FL | OOD | AIR | MEAN | |
| SNOW LOAD TEMP.REQ'D | | CATEGORY INDEX | WTHRING TEMP. | FRST LINE DPTH | TERMITE | DECAY | DESIGN | UNDERLYMNT | НА | ZARDS | FREEZING | ANNUAL |
| 30 LBS./S.F. | 110-120 MPH | С | SEVERE | 42" DEEP | MODERATE TO HEAVY | SLIGHT TO MODERATE | 7D | YES | floodplain | x outside nual chance ATE: 9/28/2007 | YES | |
| CLIMATE ZONE | FENESTRATION U-FACTOR | SKYLIGHT U-FACTOR | CEILING R-VALUE | WOOD FRAME R-VALUE | MASS WALL R-VALUE | FLOOR R-VALUE | Basement R-Value & Def | PTH R-V/ | SLAB ALUE & DEPTH | CRAWL SPACE WALL R-VALUE | | |

EXIST.

N/A (EXIST)

4 ZONE - 5750 HEATING DEGREE DAYS

ACTUAL: 0.33

ALT LEVEL NO 2 SCOPE: RENOVATE 1ST FLOOR KITCHEN AREA RENOVATE 2ND FLOOR BEDROOM CLOSETS CONSTRUCT SECOND FLOOR BATHROOM ADDITION OVER EXIST ONE STORY CONSTRUCTION TYPE 5B UNPROTECTED OCCUPANCY= R3 1 FAMILY RESIDENTIAL FAR = SEE ZONING ANALYSIS

ENERGY CODE COMPLIANCE

EXIST. - 4" MIN.

EXIST. - 108" MIN.

FROM TABLE 402.1(1) FROM ENERGY CONSERVATION CONSTRUCTION CODE OF NEW YORK STATE PUBLISHED JANUARY 2015 - BASED ON 2010

| ASED ON 5,750 HEATING DEGREE DAYS IN CLIMATE ZONE 4 (NOT MARINE) | | | | | |
|--|---------------------|--------------------|--|--|--|
| SUB-SYSTEM | MAXIMUM U-FACTOR | MINIMUM R-VALUE | | | |
| FENESTRATION | Ug = .35 | R - 4 | | | |
| SKYLITE | Ug = .55 | | | | |
| GLAZED FENESTRATION | Ug = .40 | | | | |
| CEILING | Ug = .026 | R - 49 | | | |
| FRAME WALL | Ug = .060 | 20 OR 13+5 | | | |
| MASS WALL | Ug = .098 | 8/13 | | | |
| | | | | | |
| FLOOR | Uf = .047 | R - 19 | | | |
| BASEMENT WALL | Uf = .059 | R - 10/13 | | | |
| SLAB PERIMETER | | R10 FOR 2' | | | |
| CRAWL SPACE WALL | Uf = .065 | R - 10/13 | | | |
| | | | | | |

A. R-VALUES ARE MINIMUMS. U-FACTORS AND SHGC ARE MAXIMUMS. R-19 BATTS COMPRESSED INTO A NOMINAL 2X6 FRAMING CAVITY SUCH THAT THE R-VALUE IS REDUCED BY R-1 OR MORE SHALL BE MARKED WITH THE COMPRESSED BATT R-VALUE IN ADDITION TO THE FULL THICKNESS R-VALUE.

N/A (EXIST)

N/A (EXIST)

N/A (EXIST)

- B. THE FENESTRATION U-FACTOR COLUMN EXCLUDES SKYLIGHTS. THE SHGC COLUMN APPLIES TO ALL GLAZED FENESTRATION.
- C. "15/19" MEANS R-15 CONTINUOUS INSULATED SHEATHING ON HE INTERIOR OR EXTERIOR OF THE HOME OR R-19 CAVITY INSULATION AT THE INTERIOR OF THE BASEMENT WALL. "10/13" MEANS R-10 CONTINUOUS INSULATED SHEATHING ON THE INTERIOR OR EXTERIOR OF THE HOME OR R-13 CAVITY INSULATION AT THE INTERIOR OF THE BASEMENT WALL.
- D. R-5 SHALL BE ADDED TO THE REQUIRED SLAB EDGE R-VALUES FOR HEATED SLABS. INSULATION DEPTH SHALL BE THE DEPTH OF THE FOOTING OR 2 FEET, WHICHEVER IS LESS IN ZONES 1 THROUGH 3 FOR HEATED SLABS.
- E. THERE ARE NO SHGC REQUIREMENTS IN THE MARINE ZONE.
- F. BASEMENT WALL INSULATION IS NOT REQUIRED IN WARM-HUMID LOCATIONS.
- G. OR INSULATION SUFFICIENT TO FILL THE FRAMING CAVITY. R-19 IS MINIMUM
- H. "13+5" MEANS R-13 CAVITY INSULATION PLUS R-5 INSULATED SHEATHING. IF STRUCTURAL SHEATHING COVERS 25 PERCNT OR LESS OF THE EXTERIOR, INSULATING SHEATHING IS NOT REQUIRED WHERE STRUCTURAL SHEATHING IS USED. IF STRUCTURAL SHEATHING COVERS MORE THAN 25 PERCENT OF EXTERIROR, STRUCTURAL SHEATHING SHALL BE SUPPLEMENTED WITH INSULATED SHEATHING OF ATLEAST R-2.
- I. THE SECOND R-VALUE APPLIES WHEN MORE THAN HALF THE INSULATION IS ON THE INTERIOR OF THE WALL.
- J. FOR IMPACT RATED FENESTRATION COMPLYING WITH SECTIONR301.2.1.2 OF THE INTERNATIONAL RESIDENTIAL CODE OR SECTION 1608, 1,2 OF THE INTERNATIONAL BUILDING CODE, THE MAXIMUM U-FACTOR SHALL BE 0.75 IN ZONE 2 AND 0.65 IN ZONE

GENERAL NOTE:

THESE HAVE BEEN PREPARED WITH NO KNOWLEDGE OF PRESENCE OF LEAD OR ASBESTOS. CONTRACTOR AND OWNER MUST TAKE APPROPRIATE STEPS TO IDENTIFY AND ABATE AS PER ALL APPLICABLE CODES.

ENERGY NOTES:

- 1. I, DOUGLAS MCCLURE, CERTIFY THAT THESE PLANS AND SPECIFICATIONS COMPLY WITH THE LATEST EDITION OF THE ENERGY CONSERVATION CONSTRUCTION CODE OF NEW YORK STATE, CURRENTLY THE 2016 ENERGY CONSERVATION CODE OF NYS.
- 2. ALL INSULATION SHALL BE AT MINIMUM PAPER FACED FIBERGLASS BATTS, WITH THE PAPER FACING THE WARM SIDE OF THE ASSEMBLY.
- 3. THE G.C. SHALL PROVIDE A PERMANENT CERTIFICATE POSTED ON OR IN THE ELECTRICAL DISTRIBUTION PANEL LISTING THE PREDOMINANT R-VALUES OF THE INSULATION INSTALLED PER SYSTEM THROUGH OUT THE RESIDENCE PER SECTION 401.3 OF THE ENERGY CONSERVATION CONSTRUCTION CODE OF NEW YORK STATE.
- 4. CEILING INSULATION MAY BE REDUCED TO R-30 IN THE FOLLOWING SITUATIONS:
- A. PER SECTION 402.2.1- CEILINGS WITH ATTIC SPACES: IF THE FULL HEIGHT OF THE UNCOMPRESSED R-30 INSULATION EXTENDS OVER THE WALL TOP PLATE AT THE EAVES
- B. PER SECTION 402.2.2-CEILINGS WITHOUT ATTIC SPACES:WHERE THE DESIGN OF THE ROOF/CEILING ASSEMBLY DOESN'T ALLOW SUFFICIENT SPACE FOR THE REQUIRED INSULATION, THIS REDUCTION SHALL BE LIMITED TO 500 SF OF CEILING AREA.
- 5. INSULATION VALUES SHOWN IN CHART ABOVE MAY BE REDUCED TO R-30 FOR CEILING AND R-13 FOR WALL IF THE MECHANICAL SYSTEM COMPLIES WITH TABLE 403.7 OF THE ENERGY CONSERVATION CONSTRUCTION CODE OF NEW YORK STATE. (I.E., GAS FURNACE: 90% AFUE OR GAS BOILER 82% AFUE.
- 6. FOR BLOWN IN INSULATION, THE SETTLED R-VALUE SHALL BE USED.
- 7. INSULATION VALUES SHOWN IN THE CHART ABOVE ARE MINIMUM VALUES REQUIRED BY CODE AND MAY NOT REFLECT THE INSULATION VALUES CALLED OUT IN THE CONSTRUCTION DOCUMENTS. WHEN TWO DIFFERENT INSULATION VALUES ARE CALLED OUT, CONTRACTORS ARE HEREBY DIRECTED TO INSTALL THE INSULATION WITH GREATER R-VALUE PER ASSEMBLY.
- 8. R-19 BATT INSULATION SHALL BE INSTALLED IN ALL 2X6 EXTERIOR WALLS.

DEPARTMENT.

ALL WORK SHALL COMPLY WITH THE N.Y. STATE BUILDING CODE, THE CITY OF HASTINGS-ON-HUDSON ZONING CODE AND ALL OTHER AGENCIES HAVING JURISDICTION.2015 IRC. 2015 IPC, 2015IMC, 2015IEBC AS AMENDED BY 2017 NYS UNIFORM CODE SUPPLEMENT, 2014NEC,2016IECC AND CNR MUNICIPAL CODE.

- II. THE G.C. IS TO SECURE A BUILDING PERMIT FROM THE CITY OF NEW ROCHELLE BUILDING
- III. G.C. SHALL GIVE THE OWNER A WRITTEN GUARANTEE COVERING ALL EQUIPMENT, MATERIALS AND WORKMANSHIP FOR A PERIOD OF (1) ONE YEAR FROM DATE OF FINAL ACCEPTANCE BY THE OWNER (CONFIRMED IN WRITING), AND HE SHALL, UPON NOTICE, PROMPTLY MAKE GOOD AT HIS OWN EXPENSE ALL DEFECTS IN MATERIAL AND WORKMANSHIP DURING THIS PERIOD AT NO COST TO THE OWNER.
- THE CHARACTER AND SCOPE OF THE WORK ARE ILLUSTRATED BY THE DRAWINGS AND NOTES. FULL SIZE OR LARGE SCALE DETAILS OR DRAWINGS SHALL GOVERN OVER SMALL SCALE DRAWINGS WHICH THEY ARE INTENDED TO AMPLIFY. DETAILS OR CONDITIONS INDICATED FOR A PORTION OF THE WORK SHALL APPLY THROUGHOUT TO ALL SIMILAR PORTIONS EXCEPT AS OTHERWISE SPECIFICALLY NOTED. DIMENSIONS SHALL BE FIGURED RATHER THAN DETERMINED BY RULE OR SCALE.
- V. UNLESS OTHERWISE NOTED, ALL DIMENSIONS ARE FINISHED DIMENSIONS.
- VI. THE GENERAL CONTRACTOR SHALL PROVIDE ALL NECESSARY PROTECTION AGAINST DIRT AND
- VII. THE G.C SHALL PROVIDE, ERECT & MAINTAIN TEMP. DUST BARRIERS/PARTITIONS & OTHER ITEMS REQU'D. FOR PROPER PROTECTION OF AREAS ADJACENT TO THE WORK & PROVIDE SAFE ACCESS TO THE PORTIONS THAT ARE NOT AFFECTED BY THE WORK.
- VIII. ALL PERTINENT PRECAUTIONS FOR ACCIDENT PREVENTION RECOMMENDED BY THE ASSOCIATED GENERAL CONTRACTORS OF AMERICA, INC., OSHA, OR BY STATE AND LOCAL LAWS AND REGULATIONS, SHALL BE CONSIDERED TO FORM A PART OF THE CONTRACT WORK.
- CONTRACTOR SHALL KEEP A FULL SET OF COMPLETE UP-TO-DATE PLANS AVAILABLE AT THE JOB.
- THE CONTRACTOR SHALL PURCHASE & MAINTAIN INSURANCE OF A FORM & WITH COMPANIES SATISFACTORY TO THE OWNER, & THE VILLAGE OF HASTINGS-ON-HUDSON
- XI. DEMOLITION CUTTING PROTECTION:

INSURANCE REQUIREMENTS:

- A. PROBE TO LOCATE UTILITIES OR STRUCTURE PRIOR TO REMOVING MATERIALS. DO ALL WORK SO AS NOT TO ENDANGER BUILDING STRUCTURE AND UTILITIES: PROVIDE TEMPORARY BRACES AND OTHER SUPPORTS AS MAY BE REQUIRED TO ASSURE THE SAFETY OF THE EXISTING CONSTRUCTION, WORKMEN, OCCUPANTS AND FINISHES.
- B. DO SUCH REQU'D WORK WITH CARE INCLUDING SHORING, BRACING, DUST PROTECTION, ETC. BE RESPONSIBLE FOR ANY DAMAGE WHICH MAY BE CAUSED BY SUCH WORK TO ANY PART OR PARTS OF EXISTING STRUCTURES OR ITEMS DESIGNATED FOR REUSE. PERFORM PATCHING, RESTORATION & NEW WORK AS REQU'D.
- C. DO NOT REMOVE ANY STRUCTURAL FRAMING WITHOUT APPROVAL BY ARCHITECT OR ENGINEER OF RECORD. EISTING STUD FRAMING TO REMAIN UNLESS OTHERWISE INDICATED.
- D. DO NOT LOAD OR PERMIT ANY PART OF ANY STRUCTURE TO BE LOADED TO SUCH AN EXTENT AS TO ENDANGER ITS SAFETY.
- PROVIDE ADEQUATE FIRE PROTECTION IN ACCORDANCE WITH LOCAL FIRE DEPARTMENT REGULATIONS.
- F. NO STRUCTURAL PARTS OF THE EXISTING BUILDING SHALL BE DAMAGED OR REMOVED.

- A. ENTIRE ELECTRICAL INSTALLATION SHALL BE IN ACCORDANCE WITH NEW YORK BOARD OF FIRE UNDERWRITERS, THE 2014 N.E.C., THE CITY OF NEW ROCHELLE BUILDING DEPARTMENT, & ALL OTHER CONTROLLING AGENCIES. CONTRACTOR TO OBTAIN ALL NECESSARY APPROVALS FROM ALL AGENCIES HAVING JURISDICTION.
- B. FURNISH & INSTALL ALL LIGHTING FIXTURES & OTHER ELECTRICAL FIXTURES AS DIRECTED BY THE

A. SMOKE DETECTOR NOTES:

LOT DATA LOT SIZE

SETBACKS

FRONT YARD

SIDE YARD 1

SIDE YARD 2

COMBINED SIDE YARDS

MAX. HEIGHT-STORIES

MAX. HEIGHT- FEET

COVERAGE

MAX. BUILDING COVERAGE 25%

MAX. DEVELOPMENT COVERAGE 35%

WIDTH

DEPTH

1. THE INSTALLATION OF WIRING & EQUIPMENT SHALL BE IN ACCORDANCE WITH THE N.Y. STATE ELECTRICAL CODE.

ZONING ANALYSIS

HASTINGS ON HUDSON

ALLOWABLE

10000

100

30'

12' (MINIMUM)

12' (MINIMUM)

30'

30

2.5

35

2861

4006

LOT

EXISTING

11446

109

130

6'-1"

20'-6"

26'-7"

69'-11"

EXIST

1416

2396

4.40

PROPOSED

NO CHANGE

- 2. SMOKE DETECTORS SHALL BE INSTALLED THROUGHOUT THE ENTIRE DWELLING AREA, INCLUDING BUT NOT LIMITED TO OUTSIDE OF EACH SEPARATE AREA IN THE IMMEDIATE VICINITY OF THE BEDROOMS AND IN BASEMENT & RECREATION AREAS.
- 3. EACH SMOKE DETECTOR SHALL HAVE AN INTEGRAL TEST MEANS TO PERMIT THE OCCUPANT TO CHECK THAT IT IS OPERATIONAL. A CONTINUOUS POWER DISPLAY INDICATOR LIGHT IS RECOMMENDED, & ALL DETECTORS ARE TO BE HARDWIRED & INTERCONNECTED.
- 4. SMOKE DETECTORS SHALL BE LOCATED ON OR NEAR THE CEILING & WITHIN FIFTEEN FEET OF ALL ROOMS USED FOR SLEEPING PURPOSES. IN ALL DWELLING UNITS W/MULTIPLE LEVELS, WHEN ANY LEVEL HAS ONLY ONE MEANS OF EGRESS, THE DWELLING UNIT SHALL BE PROVIDED WITH SMOKE DETECTORS AT ALL LEVELS.
- 5. IF CLG. MOUNTED, CLOSEST EDGE OF THE DETECTOR SHALL BE A MIN. OF 4" FROM WALL
- 6. IF WALL MOUNTED THE CLOSEST EDGE OF THE DETECTOR SHALL BE FOUR INCHES & A MAXIMUM OF TWELVE INCHES FROM THE CEILING.
- 7. SMOKE DETECTOR UNIT(S) SHALL BE APPROVED BY BSA ACCEPTED PURSUANT TO RULES & REGULATION PROMULGATED BY THE COMMISSIONER OR LISTED BY AN ACCEPTABLE TESTING AGENCY SUCH AS UNDERWRITERS LABORATORY OR APPROVED EQUAL.
- 8. UNITS TO BE EITHER, IONIZATION CHAMBER OR PHOTO ELECTRIC AND TO COMPLY WITH RS 17-11. 9. COMPLIANCE WITH 2015 IRC,R314 AND R315 HARDWIRED WITH BATTERY BACKUP


CARBON MONOXIDE DETECTOR NOTES:

1. CARBON MONOXIDE DETECTORS TO BE INSTALLED THROUGOUT THE DWELLING IN ACCORDANCE WITH NEW YORK STATE BUILDING CODE.

STRUCTURAL NOTES:

THE INTEGRITY OF EXISTING FRAMING AND FOUNDATION MEMBERS ARE NOT KNOWN PRIOR TO DEMOLITION. AN ENGINEER MUST CERTIFY THAT LOADS ARE AS ANTICIPATED AS WELL AS CONNECTIONS TO SUPPORTING MEMBERS AT DEMOLITION. PLUMBING NOTES:

ALL NEW INSTALLED WATER LINES SHALL BE INSULATED

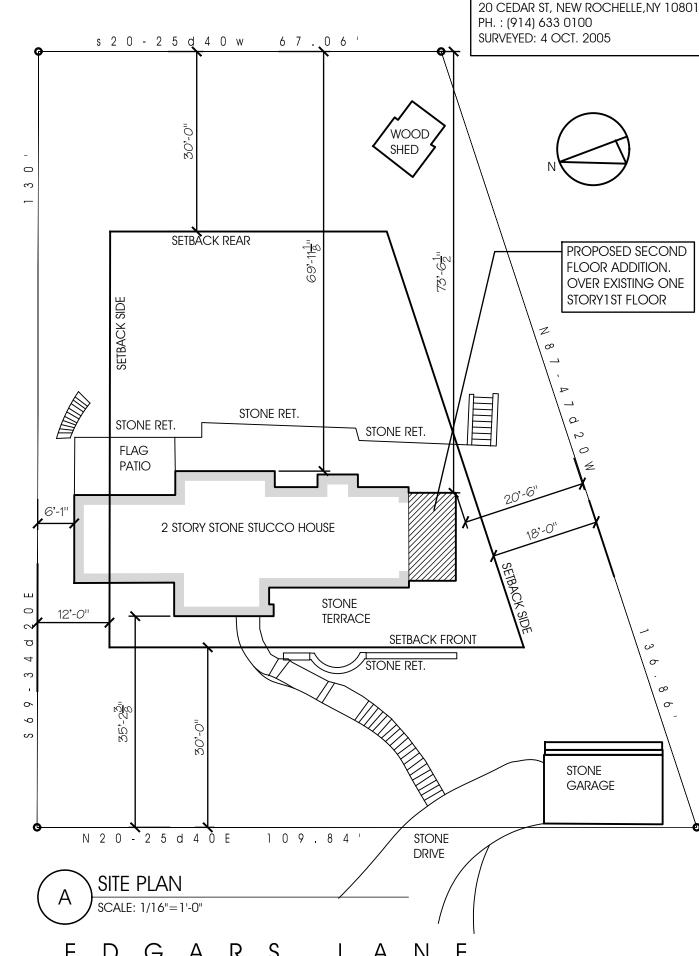

E D G A R S

RIVERVIEW PL 66 EDGARDS LN

McC | Architecture pllc

25 n. dutcher st., irvington, ny 10533 mcc-architecture.com t: 917.887.0975 e: dmcclure@mcc-architecture.com

NOTES:

SITE PLAN PREPARED FROM SURVEY BY: ARISTOTLE BOURNAZOS LAND SURVEYORS

PROJECT INFORMATION:


s alterations RESIDENCE

REV. #/DATE

DRAWING TITLE:

SITE PLAN, ZONING CODE COMPLIANCE

DRAWING INFO.

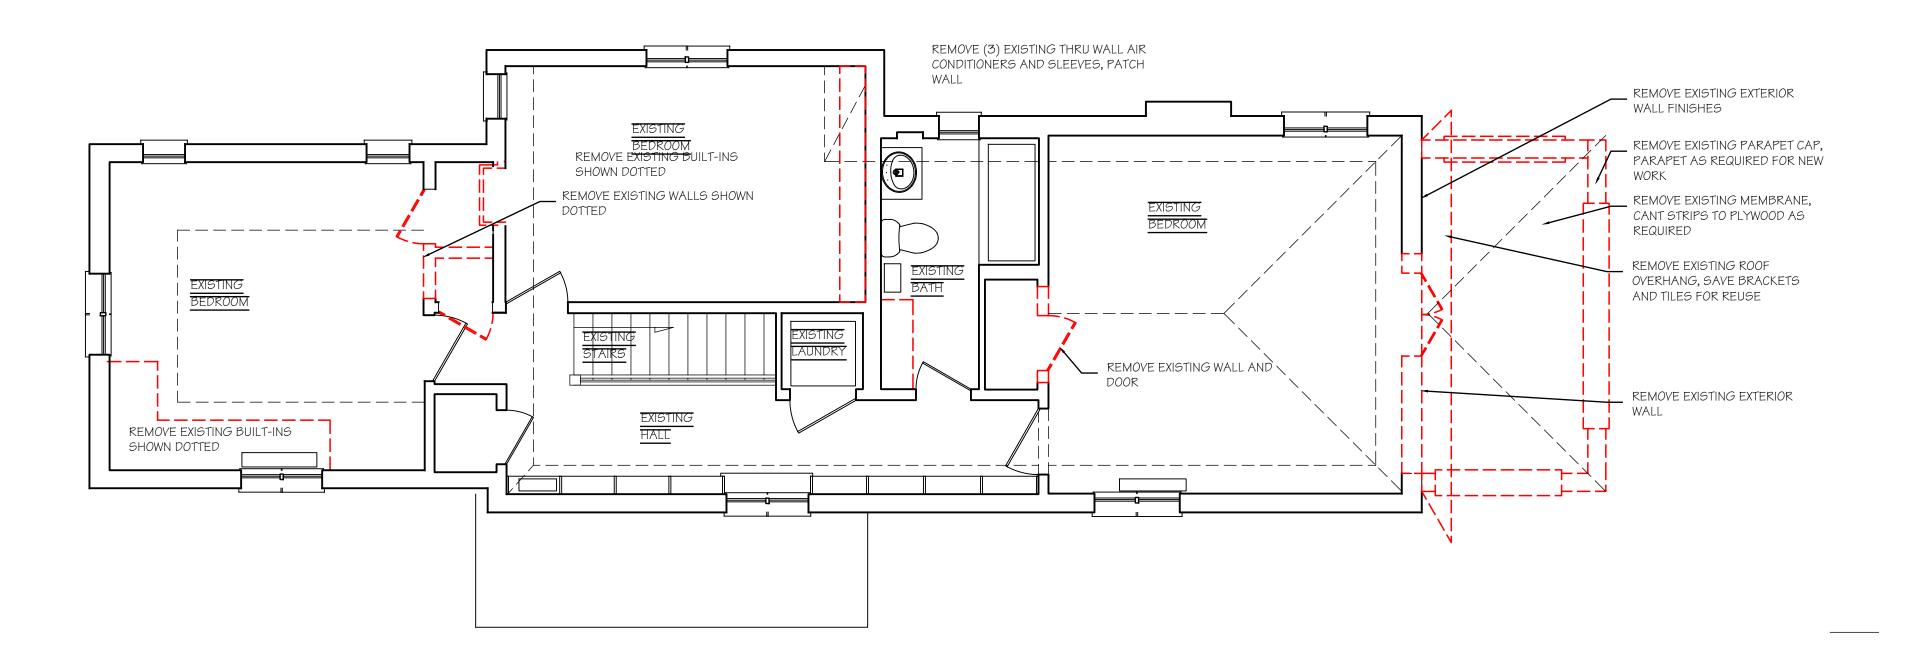


SECOND FL DEMOLITION

SCALE: 1/4"=1'-0"

- XI. DEMOLITION CUTTING PROTECTION:
- A. PROBE TO LOCATE UTILITIES OR STRUCTURE PRIOR TO REMOVING MATERIALS. DO ALL WORK SO AS NOT TO ENDANGER BUILDING STRUCTURE AND UTILITIES; PROVIDE TEMPORARY BRACES AND OTHER SUPPORTS AS MAY BE REQUIRED TO ASSURE THE SAFETY OF THE EXISTING CONSTRUCTION, WORKMEN, OCCUPANTS AND FINISHES.
- B. DO SUCH REQ'D WORK WITH CARE INCLUDING SHORING, BRACING, DUST PROTECTION, ETC. BE RESPONSIBLE FOR ANY DAMAGE WHICH MAY BE CAUSED BY SUCH WORK TO ANY PART OR PARTS OF EXISTING STRUCTURES OR ITEMS DESIGNATED FOR REUSE. PERFORM PATCHING, RESTORATION & NEW WORK AS REQ'D.
- C. DO NOT REMOVE ANY STRUCTURAL FRAMING WITHOUT APPROVAL BY ARCHITECT OR ENGINEER OF RECORD. EXISTING STUD FRAMING TO REMAIN UNLESS OTHERWISE INDICATED.
- D. DO NOT LOAD OR PERMIT ANY PART OF ANY STRUCTURE TO BE LOADED TO SUCH AN EXTENT AS TO ENDANGER ITS SAFETY.
- E. PROVIDE ADEQUATE FIRE PROTECTION IN ACCORDANCE WITH LOCAL FIRE DEPARTMENT REGULATIONS.F. NO STRUCTURAL PARTS OF THE EXISTING BUILDING SHALL BE DAMAGED OR REMOVED.

PLANS.

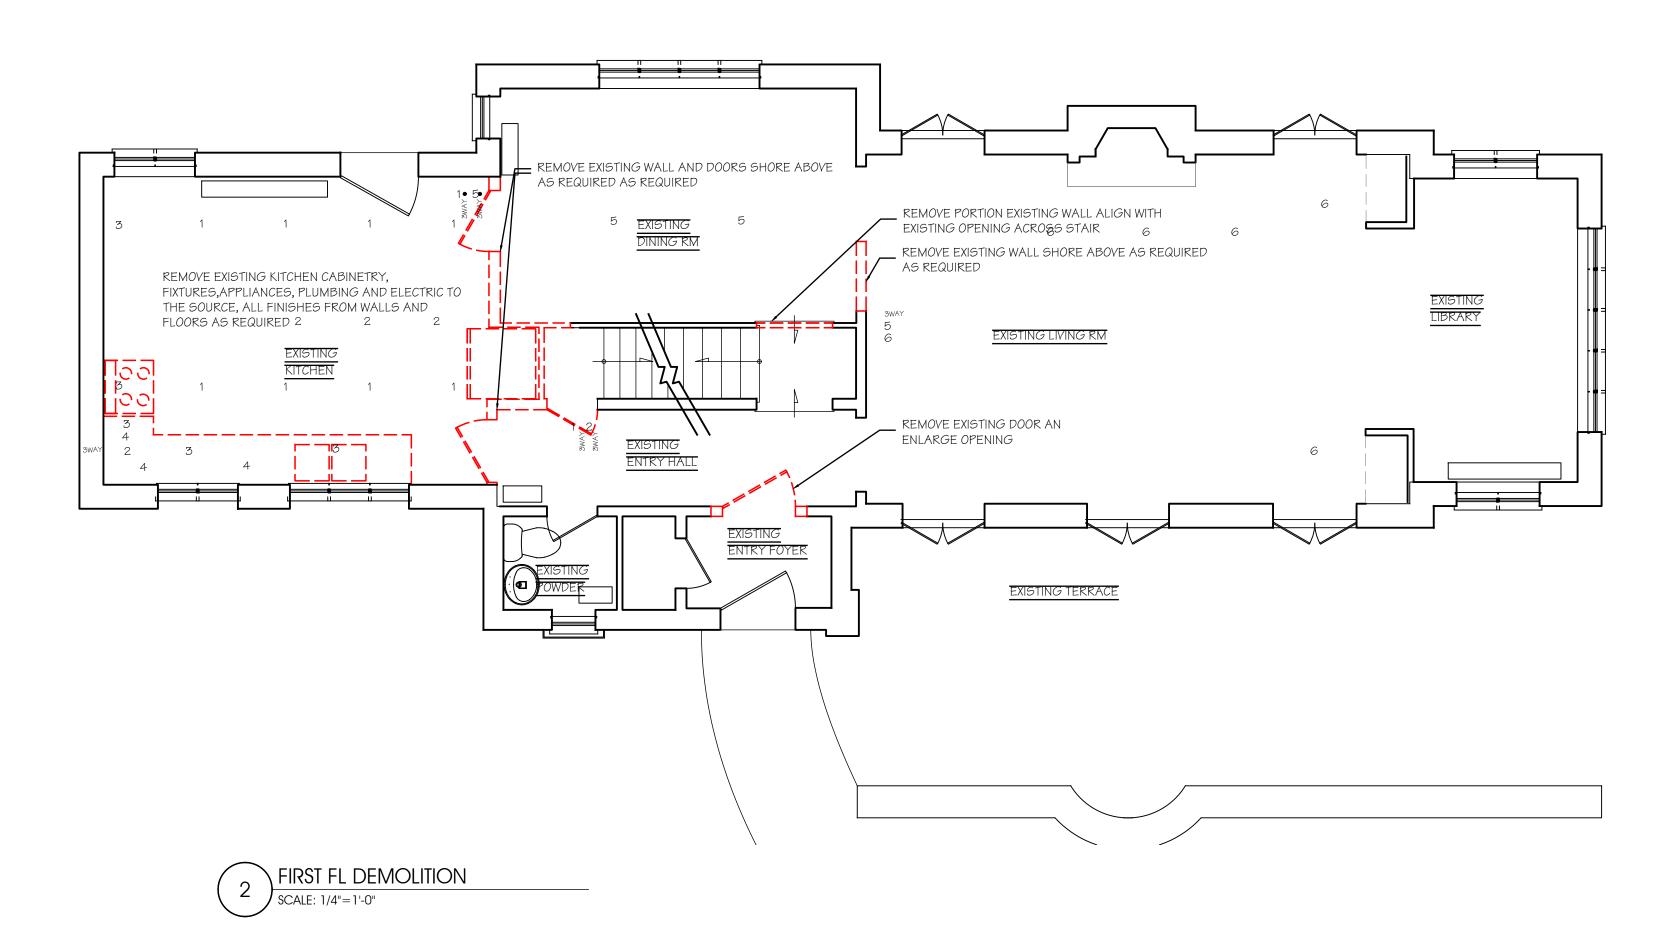

McC | Architecture pllc

25 n. dutcher st., irvington, ny 10533 | mcc-architecture.com t: 917.887.0975 | e: dmcclure@mcc-architecture.com

NOTES:

PROJECT INFORMATION:

Additions alterations
MOY RESIDENCE
66 EDGARDS LN
66 EDGARDS LN
66 EDGARDS LN
HASTINGS ON HUDSON, NY


REV. #/DATE

DRAWING TITLE:

DEMOLITION PLANS

DRAWING INFO.

D1.U NOTED

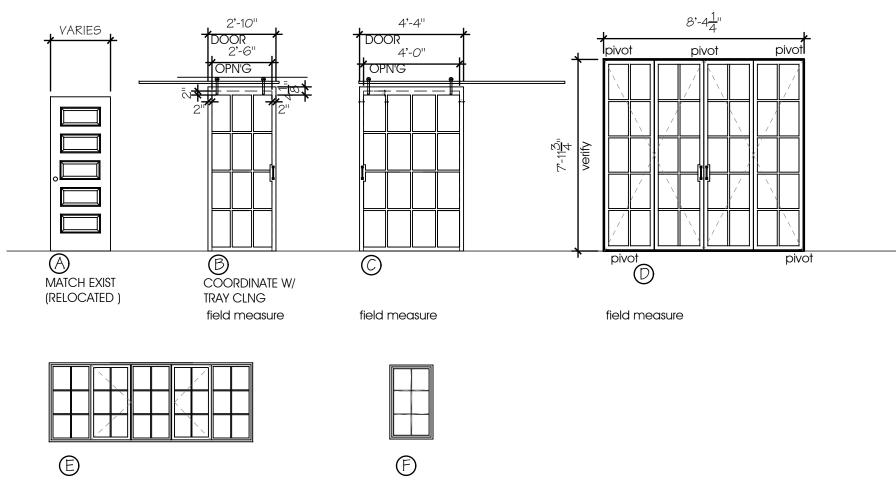


WINDOWS AND DOORS ABOVE OF METAL AND GLASS AND MANUFACTURED BY OWNER'S VENDOR INSTALLED BY G.C

7. DIVIDED LITES PER ELEVATION1. 8. INTERIOR HARDWARE AS SELECTED

2. ALL DOORS SHALL HAVE SAFETY GLASS

NOTE: ALL SAFETY GLASS MUST BE LASER OR ACID ETCHED

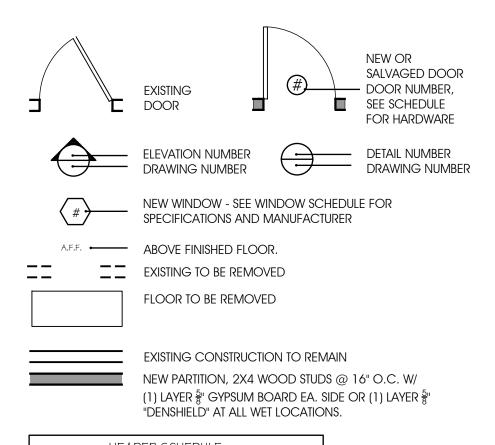

HEADER SCHEDULE OPENING HEADER UP TO 4'-0" (2) 2" X 8" WOOD 4'-0" TO 6'-0" (2) 2" X 10" WOOD 6'-0" TO 10'-0" (2) 2" X 12" WOOD NOTE: SEE "S"PLAN FOR ADDITIONAL FRAMING


NOTE: 1. INSTALL TWO STUDS AT ENDS OF EA. HEADER

WINDOW - SEE WINDOW SCHEDULE FOR SPECIFICATIONS AND MANUFACTURER

PARTITION, 2X4 WOOD STUDS @ 16" O.C. W/ (1) LAYER 5 GYPSUM BOARD BOTH SIDES OR (1) LAYER 5" "DENSHIELD" AT ALL WET LOCATIONS.

PARTITION, 2X6 WOOD STUDS @ 16" O.C. W/ (1) LAYER $\frac{5}{8}$ " GYPSUM BOARD BOTH SIDES OR (1) LAYER 5" "DENSHIELD" AT ALL WET LOCATIONS.

PARTITION, 2X4 WOOD STUDS @ 16" O.C. W/ (1) LAYER 5 GYPSUM BOARD BOTH SIDES OR (1) LAYER 8" "DENSHIELD" AT ALL WET LOCATIONS. LOW WALL HEIGHT @ 7'-1 $\frac{3}{8}$ ". TO BE COORDINATED WITH ARCHITECT.

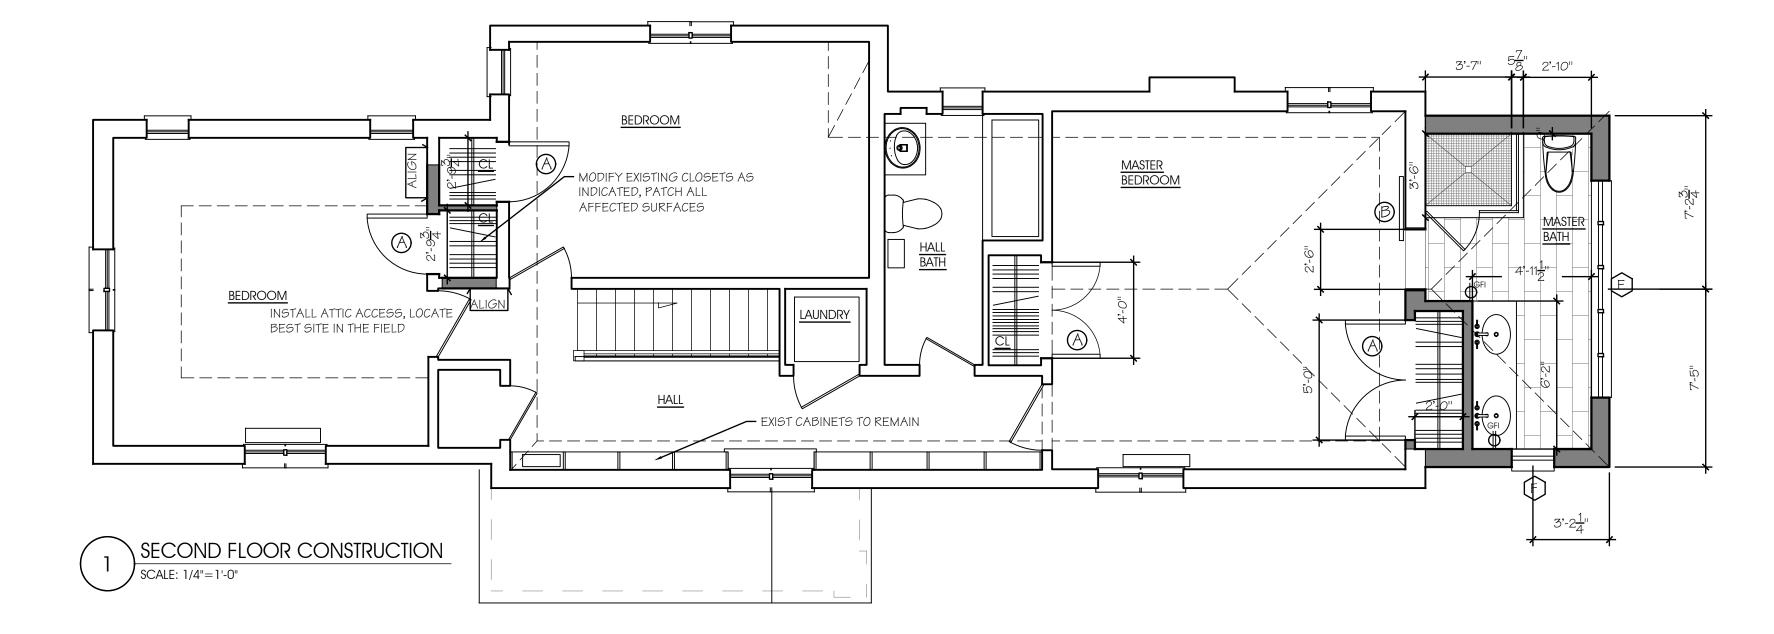

McC | Architecture pllc

25 n. dutcher st., irvington, ny 10533 | mcc-architecture.com t: 917.887.0975 | e: dmcclure@mcc-architecture.com

NOTES:

PROJECT INFORMATION:

Additions alterations MOY RESIDENCE


REV. #/DATE


DRAWING TITLE:


CONSTRUCTION PLANS

DRAWING INFO.

NOTED

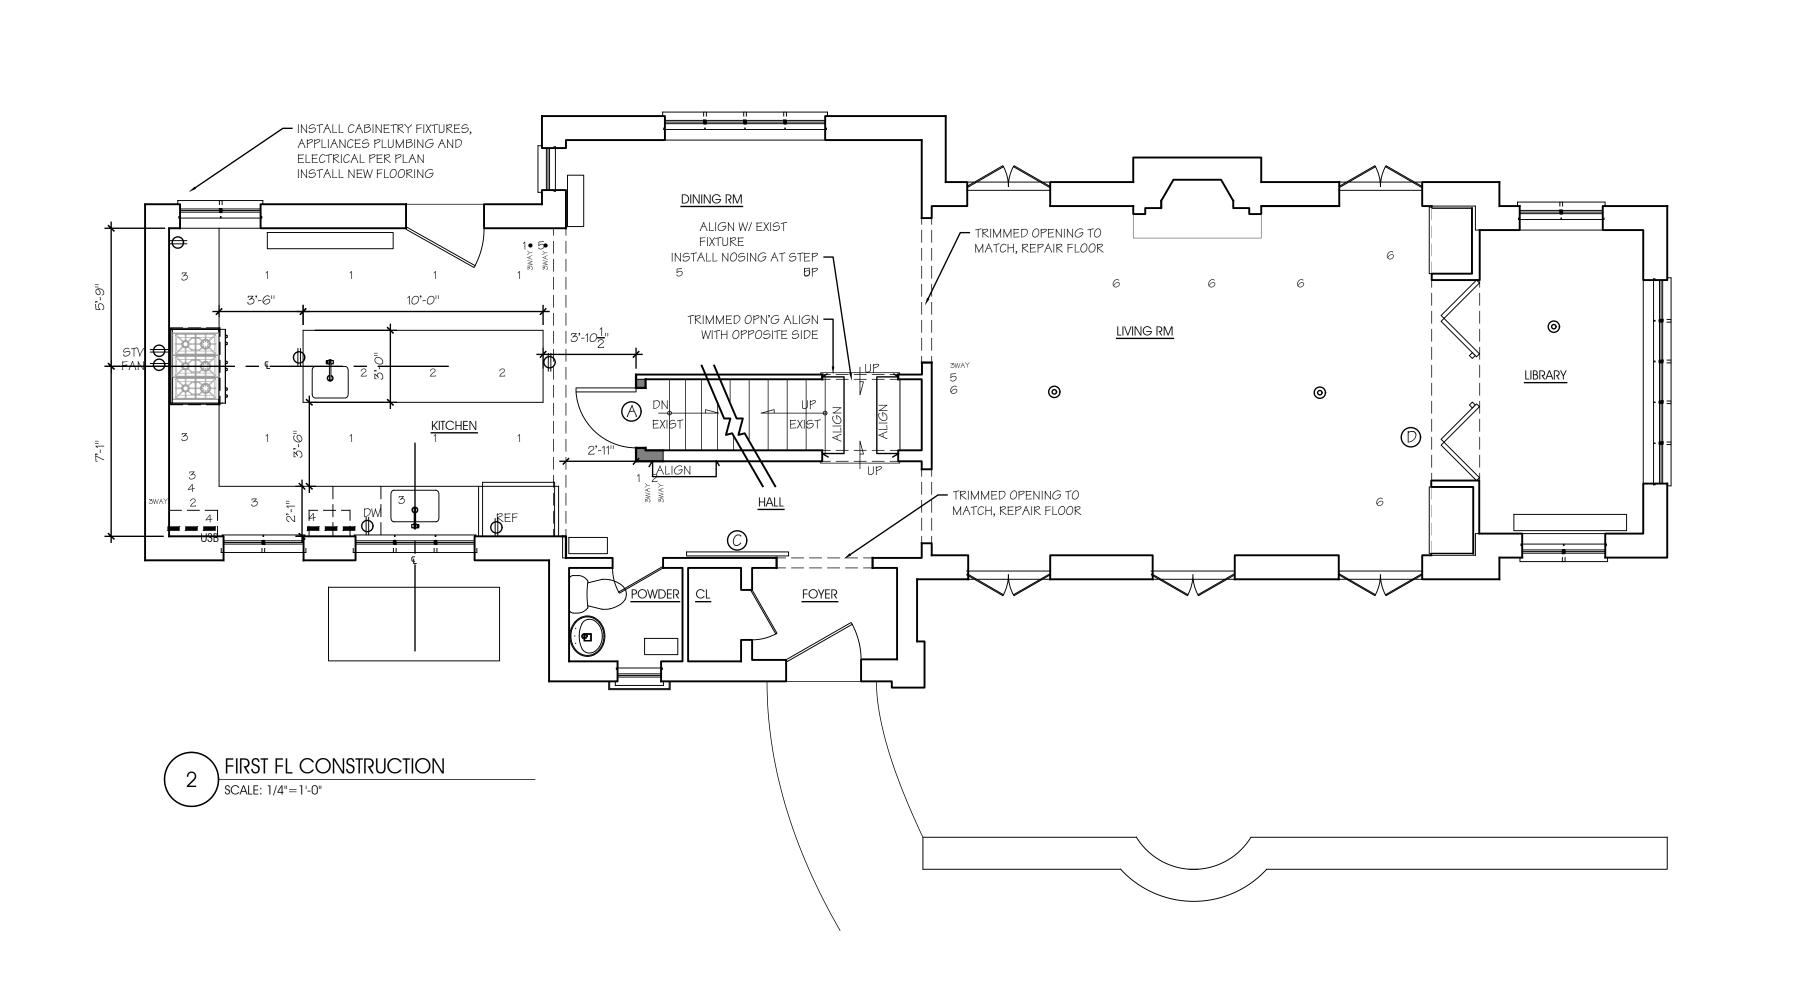

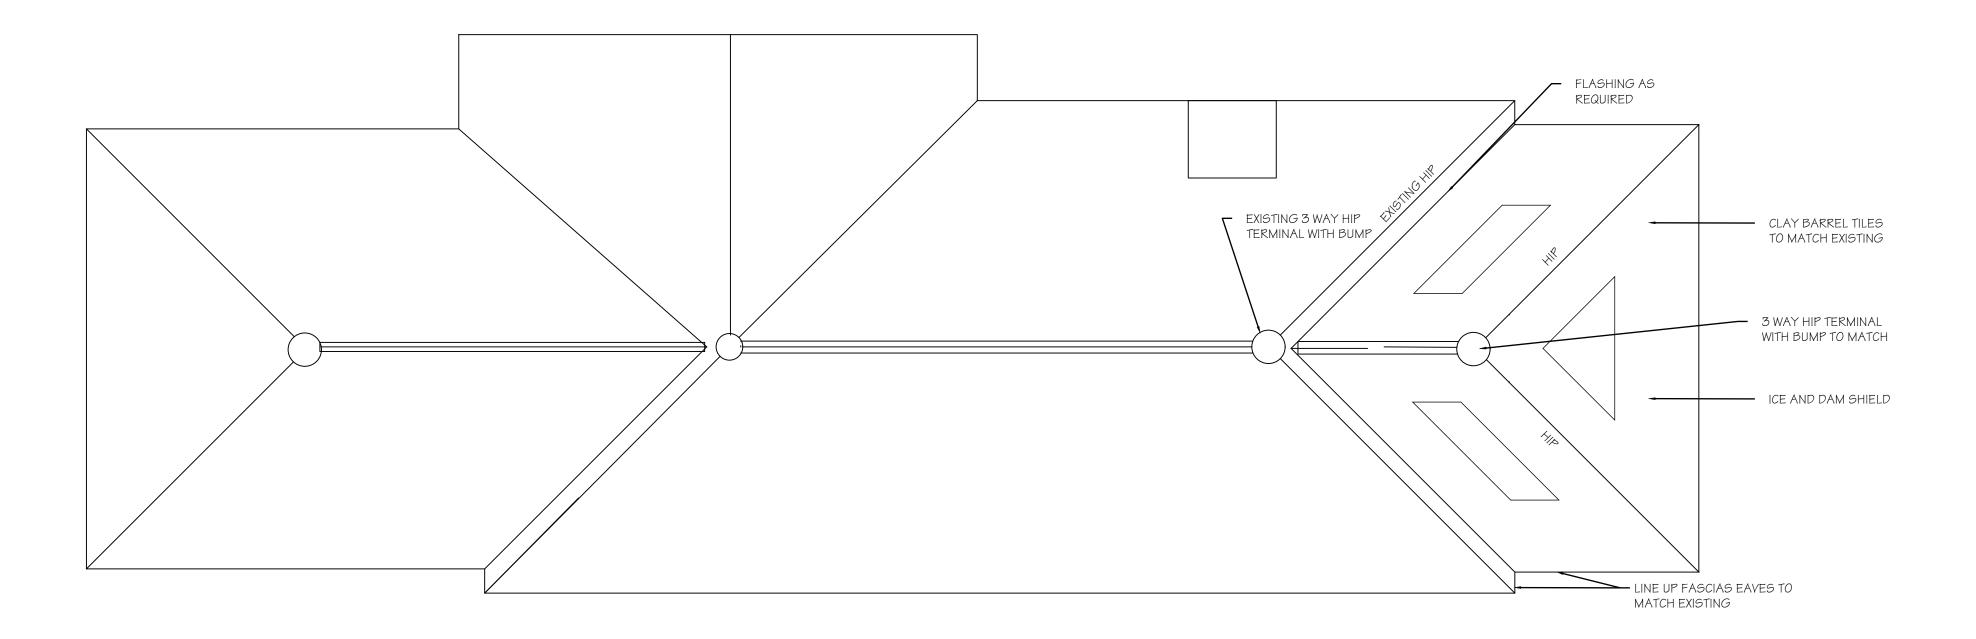

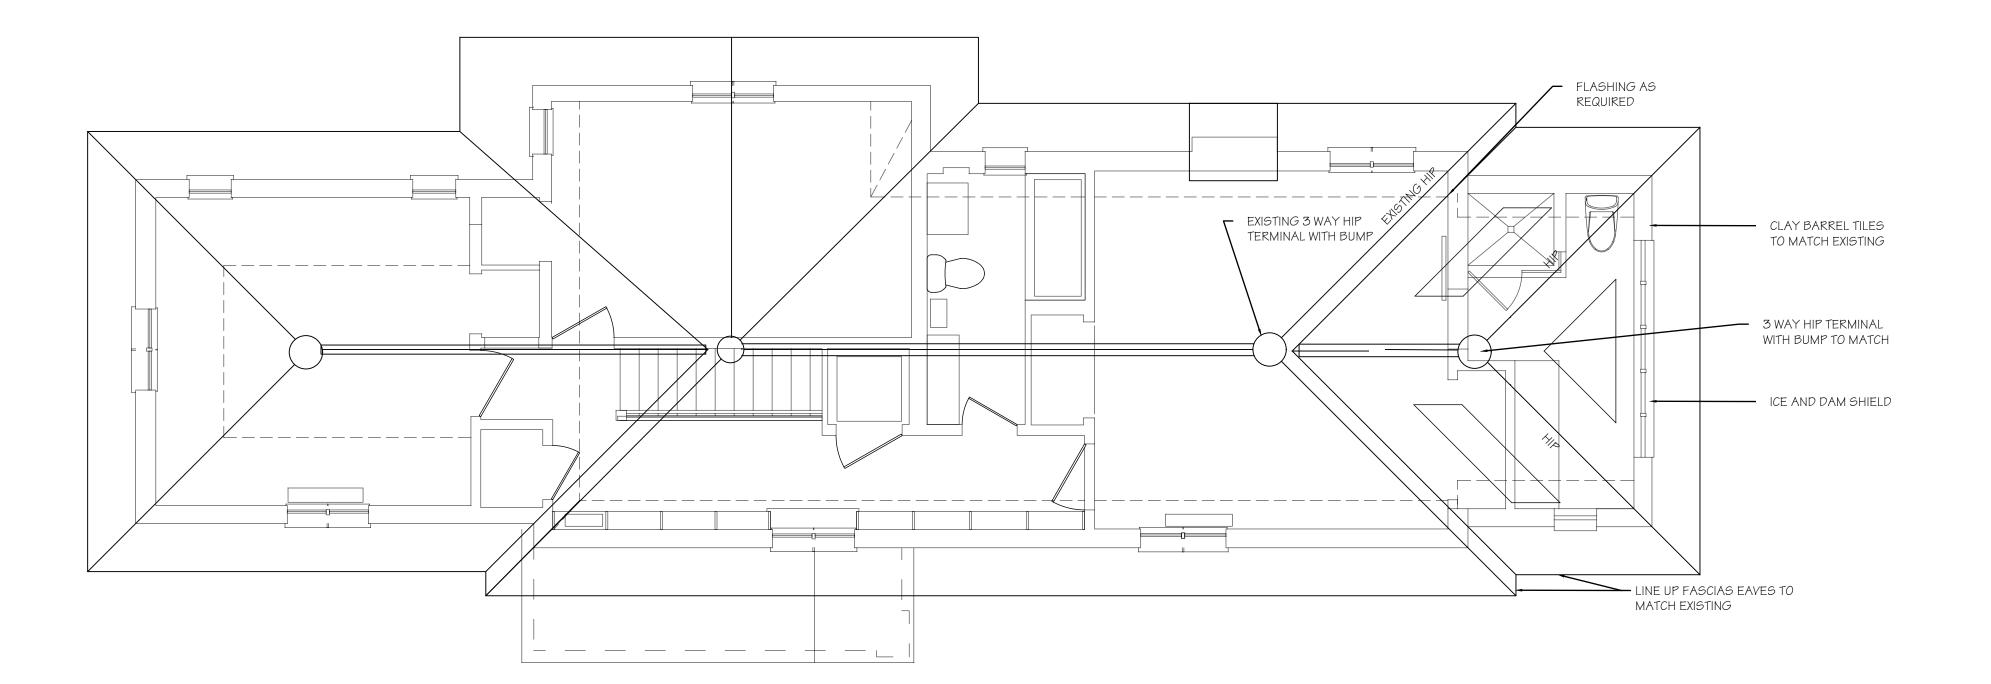

ROOF WITH 2ND BELOW

SCALE: 1/4"=1'-0"

McC | Architecture pllc

25 n. dutcher st., irvington, ny 10533 | mcc-architecture.com t: 917.887.0975 | e: dmcclure@mcc-architecture.com

NOTES:

PROJECT INFORMATION:

Additions alterations
MOY RESIDENCE
66 EDGARDS LN
66 EDGARDS LN
HASTINGS ON HUDSON, NY

REV. #/DATE

DRAWING TITLE:

ROOF PLAN

DRAWING INFO.

NOTED



McC | Architecture pllc

25 n. dutcher st., irvington, ny 10533 | mcc-architecture.com t: 917.887.0975 | e: dmcclure@mcc-architecture.com

NOTES:

PROJECT INFORMATION:

Additions alterations
MOY RESIDENCE
66 EDGARDS LN
66 EDGARDS LN
HASTINGS ON HUDSON, NY

RIGHT SIDE ELEVATION

SCALE: 1/4"=1'-0"

EXIST

3 WAY HIP TERMINAL
 WITH BUMP TO MATCH

HALF ROUND GUTTERS TO MATCH

EXIST CHIMNEY BEYOND

CLAY BARREL TILES TO MATCH EXISTING

LINE UP FASCIAS EAVES TO

MATCH EXISTING

STUCCO TO MATCH

CONTROL JT

EXIST WINDOW


DRAWING TITLE:

REV. #/DATE

EXT. ELEVATIONS SECTIONS & DETAILS

DRAWING INFO.

A2.0 NOTED

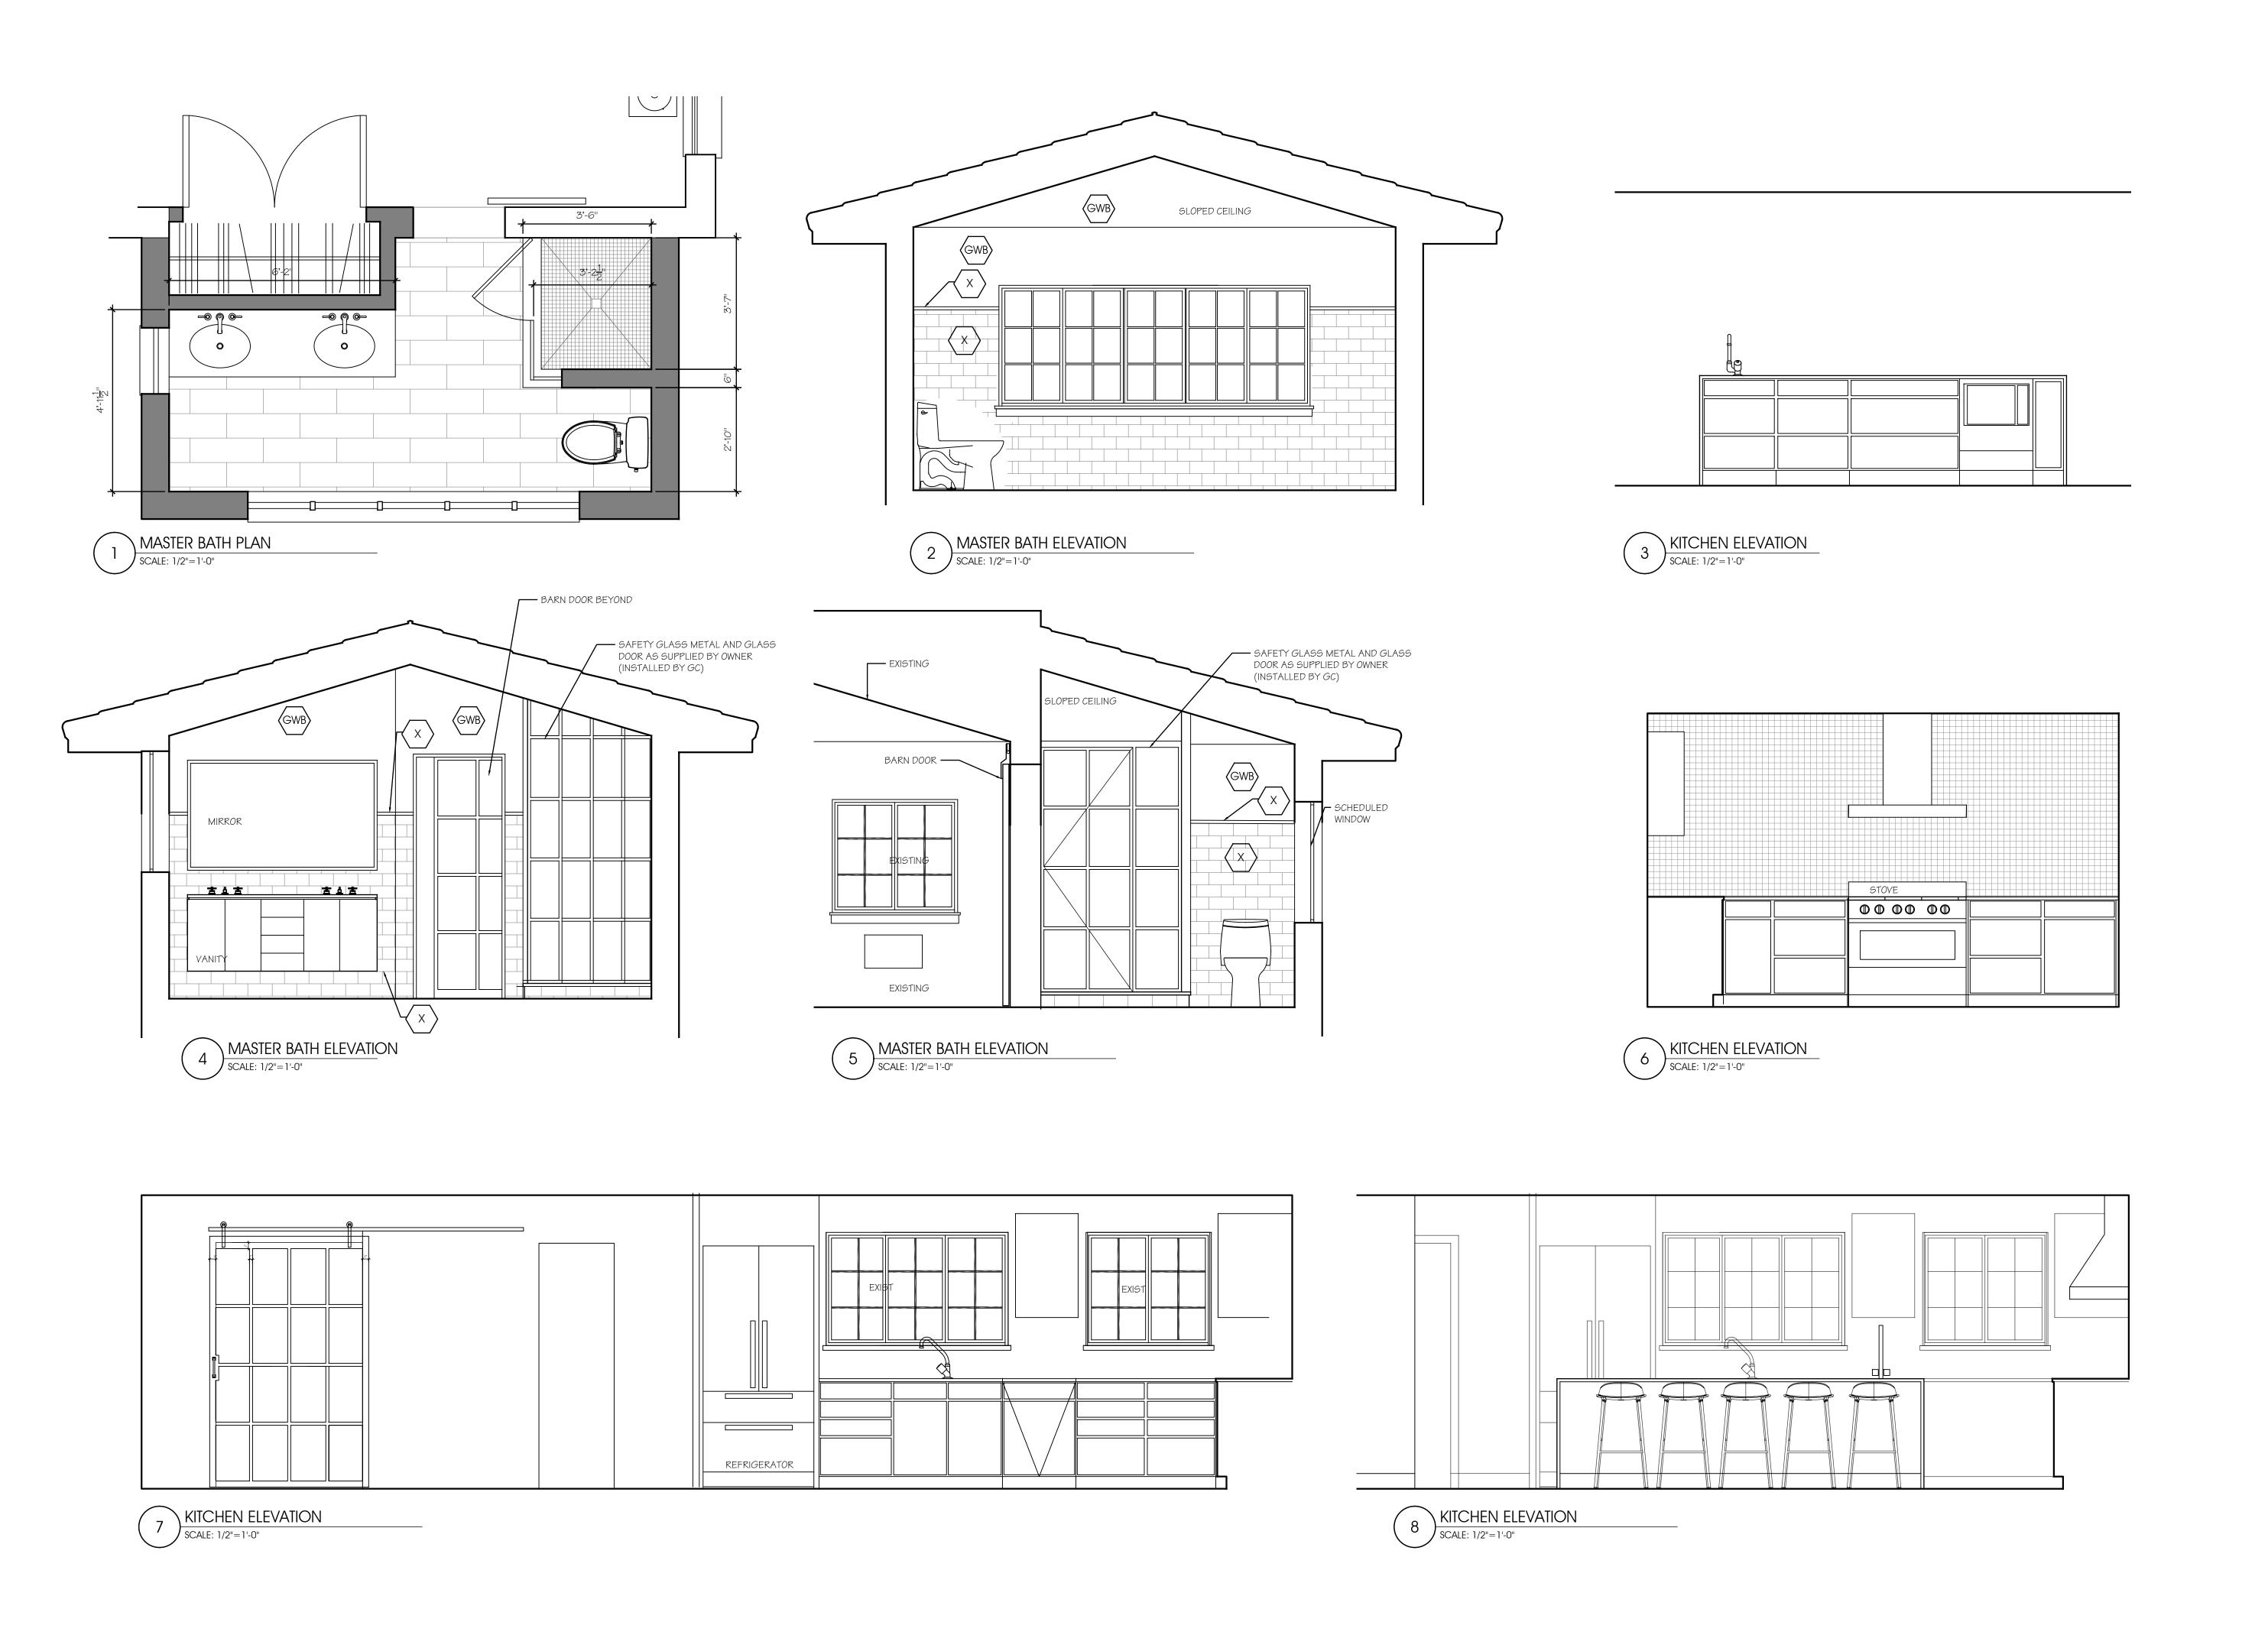

McC | Architecture pllc

25 n. dutcher st., irvington, ny 10533 | mcc-architecture.com t: 917.887.0975 | e: dmcclure@mcc-architecture.com

NOTES:

PROJECT INFORMATION:

Additions alterations
MOY RESIDENCE
66 EDGARDS LN
66 EDGARDS LN
HASTINGS ON HUDSON, NY


REV. #/DATE


DRAWING TITLE:

INTERIOR ELEVATIONS

DRAWING INFO.

A3.0 NOTED

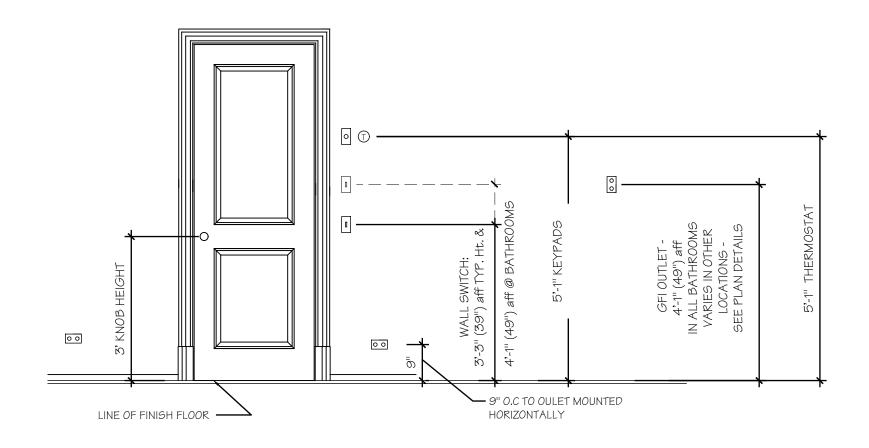

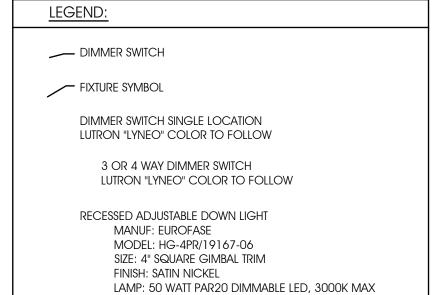

RECESSED LENSED INCANDESCENT DOWNLIGHT - SHOWER LOCATIONS MANUF: LIGHTOLIER

MODEL: 2090/2003R - LYTECASTER RECESSED DOWNLIGHTING SIZE: $4\frac{5}{8}$ " DIA. x $5\frac{3}{16}$ " DEEP

LAMP: 50 W. PAR 20 DIMMABLE LED, 3000K MAX

CLOSET LIGHT ON JAMB SWITCH MANUF: PROGRESSIVE LIGHTING MODEL: P3910-30WB, WHITE ETCHED OPAL ACRYLIC BOWL

LAMP: 26 W CFL, WARM WHITE (2700 K) SURFACE MOUNTED DECORATIVE WALL SCONCE INCANDESCENT FIXTURE - SUPPLIED BY OWNER - 100 WATTS SET MOUNTING HEIGHT IN FIELD WITH ARCHITECT.

SURFACE MOUNTED DECORATIVE CEILING INCANDESCENT FIXTURE ON JUNCTION BOX - SUPPLIED BY OWNER - 100 WATTS

SURFACE MOUNTED STRIP LIGHTING MOUNTED TO THE UNDERSIDE OF THE CABINETS MANUF: W.A.C. LIGHTING MODEL: LOW VOLTAGE - HALOGEN LIGHT BARS #BA-LV

HARDWIRED COLOR: WHITE SIZE: VARIES FROM 9-1/4" TO 39" - VERIFY WITH ARCHITECT SURFACE MOUNTED TRACK LIGHT

MANUF: W.A.C. LIGHTING TRACK: 120 V. SINGLE CIRCUIT TRACK, WHITE HEAD: EXTERMINATOR !! 22W,38° FLOOD, 2700K #1023F-827-WT COLOR: WHITE

SURFACE MOUNTED PORCELAIN SOCKET BASE

STANDARD JUNCTION BOX

COMBINATION SMOKE/CO DETECTOR MANUF: KIDDE MODEL: #KN-COPE-1

EXHAUST FAN - SWITCH CONTROLLED - PANASONIC MODEL NO. FV-08V Q2(90CFM) - VENT TO EXTERIOR

CEILING FAN MANUF: REJUVENATION MODEL: FALCON LED CEILING FAN COLOR: MATTE BLACK AND NATURAL BLADE

POWER LEGEND

NOTE: ONLY NEW OUTLETS AND OTHER ELECTRICAL DEVICES ARE SHOWN. EXISTING OUTLETS TO BE RECIRCUITED, REPLACED, OR ABANDONED AS DIRECTED BY OWNER AND AS PER EXIST. NEW YORK STATE ELECTRICAL CODE

DUPLEX ELECTRIC OUTLET MOUNTED @ 15" A.F.F. UNLESS OTHERWISE NOTED.

G.F.I. OUTLET

USB DUPLEX ELECTRIC OUTLET WITH INTEGRATED USB MOUNTED @ 15' A.F.F. UNLESS OTHERWISE NOTED.

FLOOR OUTLET

WATERPROOF OUTLET

QUAD OUTLET

 $f \Psi$ TELEPHONE/DATA OUTLET MOUNTED HORIZONTALLY - PROVIDE 2 CAT 5E CABLES AT EACH LOCATION


▼ TELEVISION OR VIDEO CABLE OUTLET


APPLIANCE HOOK UP - VERIFY CONNECTION W/MANUFACTURE'S CUT

■ ■ UNDER CABINET PLUG-MOLD

USB UNDER CABINET PLUG-MOLD W/USB

MINIMUM 50% OF ALL FIXTURE LAMPS TO BE HIGH EFFICIENCY, AS PER NY STATE ENERGY CONSERVATION CODE. ALL RECESSED FIXTURES IN 2ND FLOOR CEILING SHALL BE IC TYPE

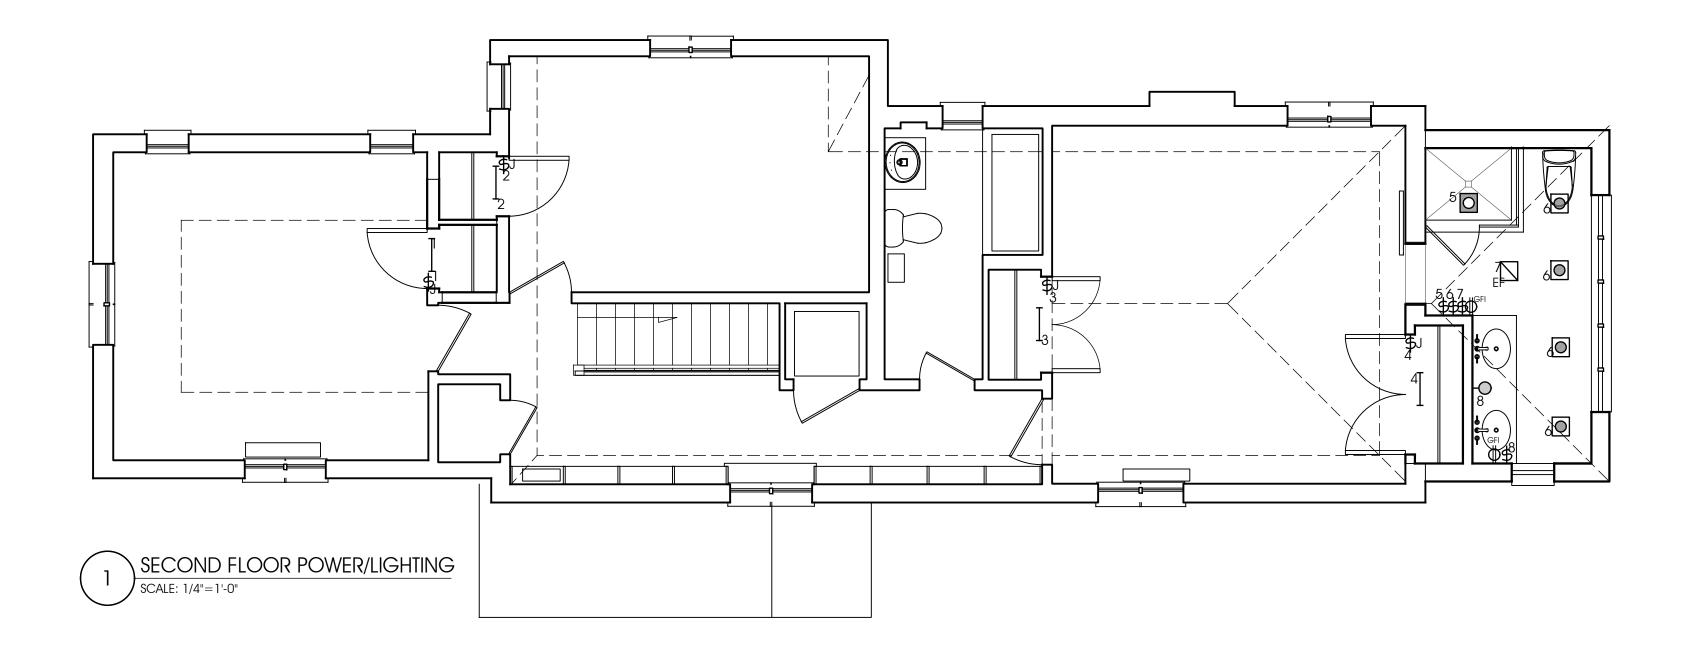

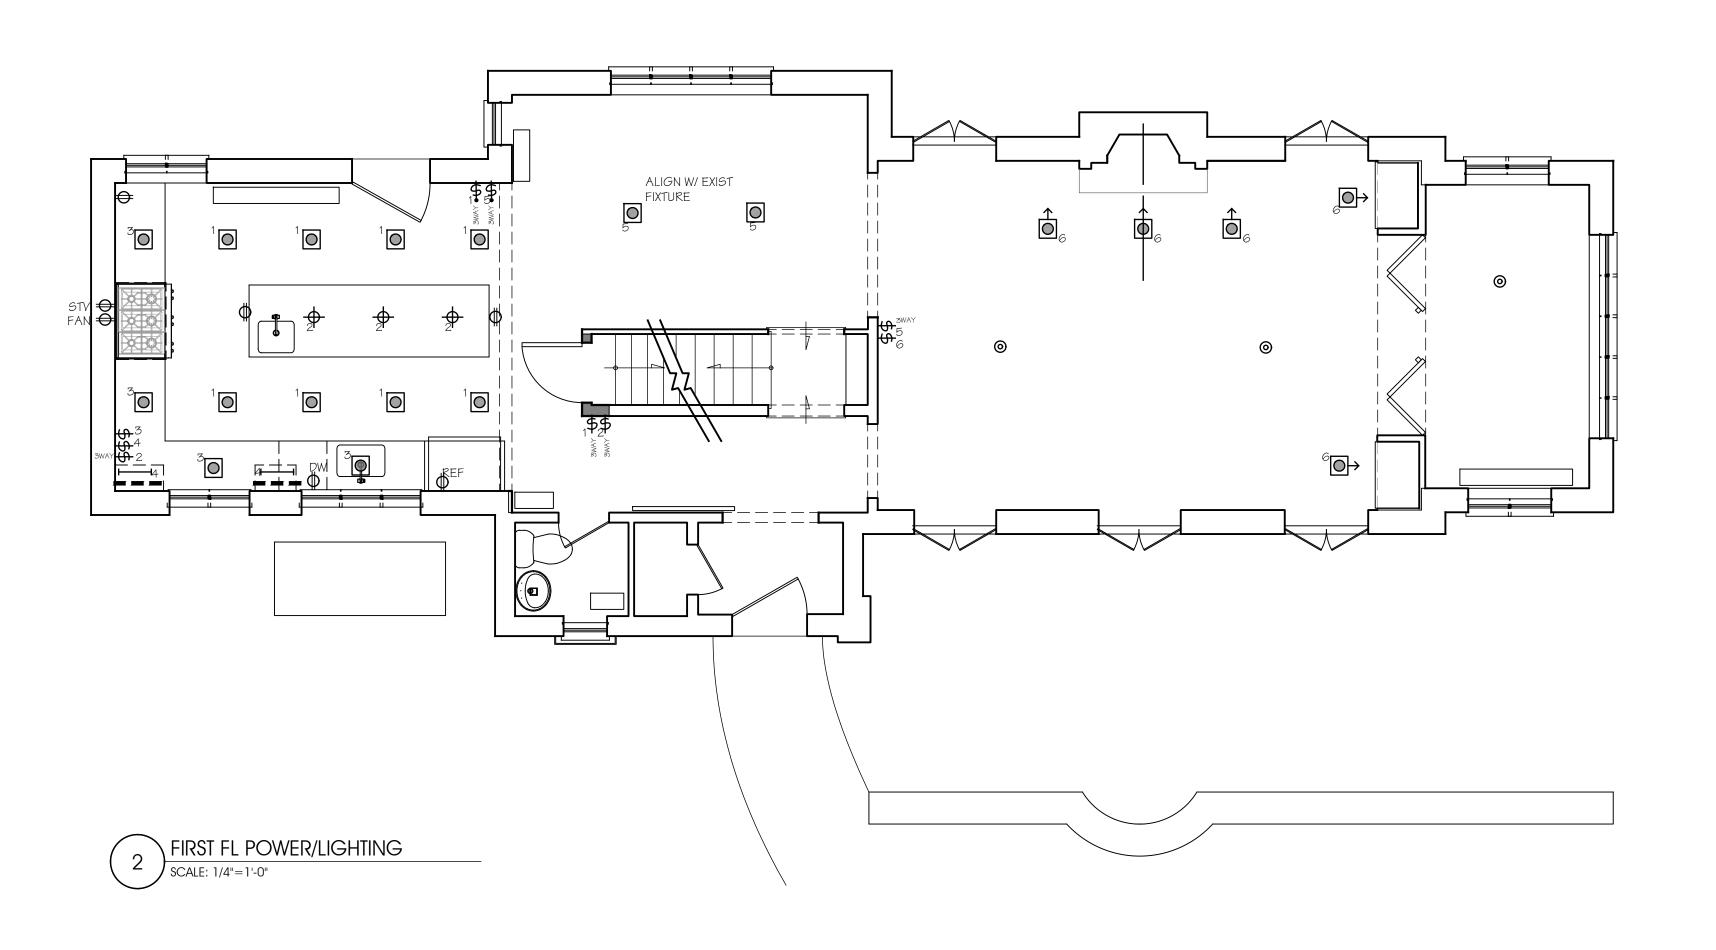

McC | Architecture pllc

25 n. dutcher st., irvington, ny 10533 | mcc-architecture.com t: 917.887.0975 | e: dmcclure@mcc-architecture.com

NOTES:

PROJECT INFORMATION:

dditions alterations MOY RESIDENCE


REV. #/DATE

DRAWING TITLE:

LIGHTING/POWER

DRAWING INFO.

NOTED

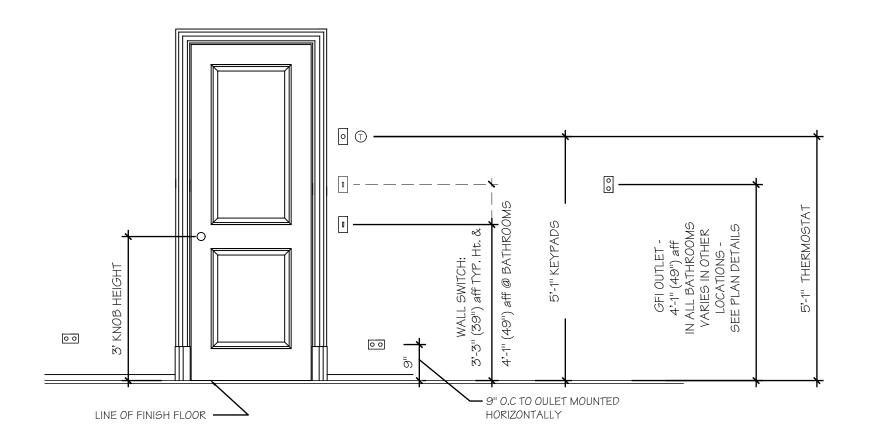



SURFACE MOUNTED DECORATIVE CEILING INCANDESCENT FIXTURE ON JUNCTION BOX - SUPPLIED BY OWNER - 100 WATTS

SURFACE MOUNTED STRIP LIGHTING MOUNTED TO THE UNDERSIDE OF THE CABINETS

MANUF: W.A.C. LIGHTING

MODEL: LOW VOLTAGE - HALOGEN LIGHT RAPS #BAJIN

MODEL: LOW VOLTAGE - HALOGEN LIGHT BARS #BA-LV HARDWIRED COLOR: WHITE

SIZE: VARIES FROM 9-1/4" TO 39" - VERIFY WITH ARCHITECT SURFACE MOUNTED TRACK LIGHT MANUF: W.A.C. LIGHTING TRACK: 120 V. SINGLE CIRCUIT TRACK, WHITE HEAD: EXTERMINATOR !! 22W,38° FLOOD, 2700K

COLOR: WHITE
SURFACE MOUNTED PORCELAIN SOCKET BASE

STANDARD JUNCTION BOX

#1023F-827-WT

COMBINATION SMOKE/CO DETECTOR MANUF: KIDDE MODEL: #KN-COPE-1

EXHAUST FAN - SWITCH CONTROLLED - PANASONIC MODEL NO. FV-08V Q2(90CFM) - VENT TO EXTERIOR

Fan

CEILING FAN

MANUF: REJUVENATION

MODEL: FALCON LED CEILING FAN

COLOR: MATTE BLACK AND NATURAL BLADE

DUPLEX ELECTRIC OUTLET MOUNTED @ 15" A.F.F. UNLESS OTHERWISE NOTED. GFI G.F.I. OUTLET USB DUPLEX ELECTRIC OUTLET WITH INTEGRATED USB MOUNTED @ 15" A.F.F. UNLESS OTHERWISE NOTED. FLOOR OUTLET WATERPROOF OUTLET QUAD OUTLET TELEPHONE/DATA OUTLET MOUNTED HORIZONTALLY - PROVIDE 2 CAT 5E CABLES AT EACH LOCATION

NOTE: ONLY NEW OUTLETS AND OTHER ELECTRICAL DEVICES ARE SHOWN.

EXISTING OUTLETS TO BE RECIRCUITED, REPLACED, OR ABANDONED AS DIRECTED BY OWNER AND AS PER EXIST. NEW YORK STATE ELECTRICAL CODE

PROVIDE 2 CAT 5E CABLES AT EACH LOG

TELEVISION OR VIDEO CABLE OUTLET

APPLIANCE HOOK UP - VERIFY CONNECTION W/MANUFACTURE'S CUT

■ ■ UNDER CABINET PLUG-MOLD


UNDER CABINET PLUG-MOLD W/USB


USB UNDER CABINET PLUG-IVIOLD

POWER LEGEND

NOTE:

MINIMUM 50% OF ALL FIXTURE LAMPS TO BE HIGH EFFICIENCY, AS PER NY STATE ENERGY CONSERVATION CODE. ALL RECESSED FIXTURES IN 2ND FLOOR CEILING SHALL BE IC TYPE

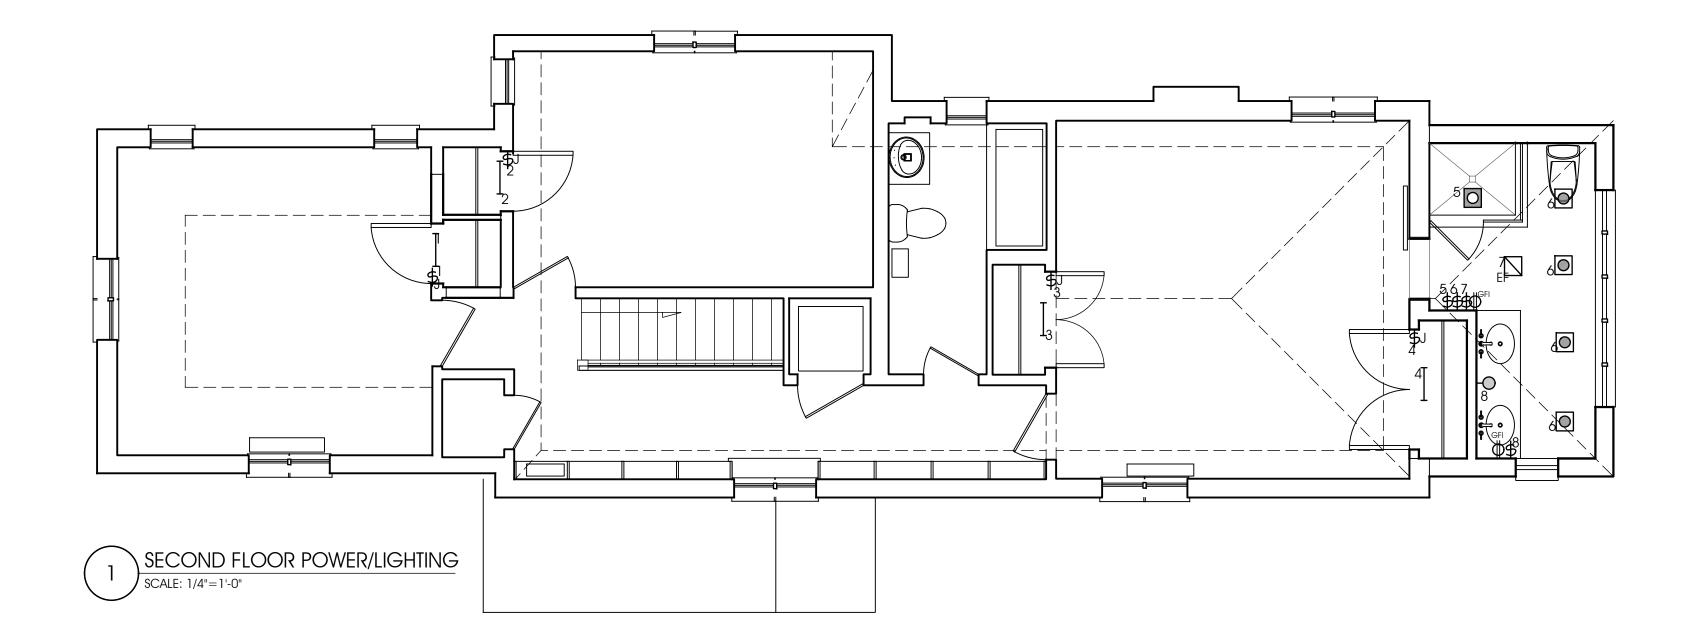

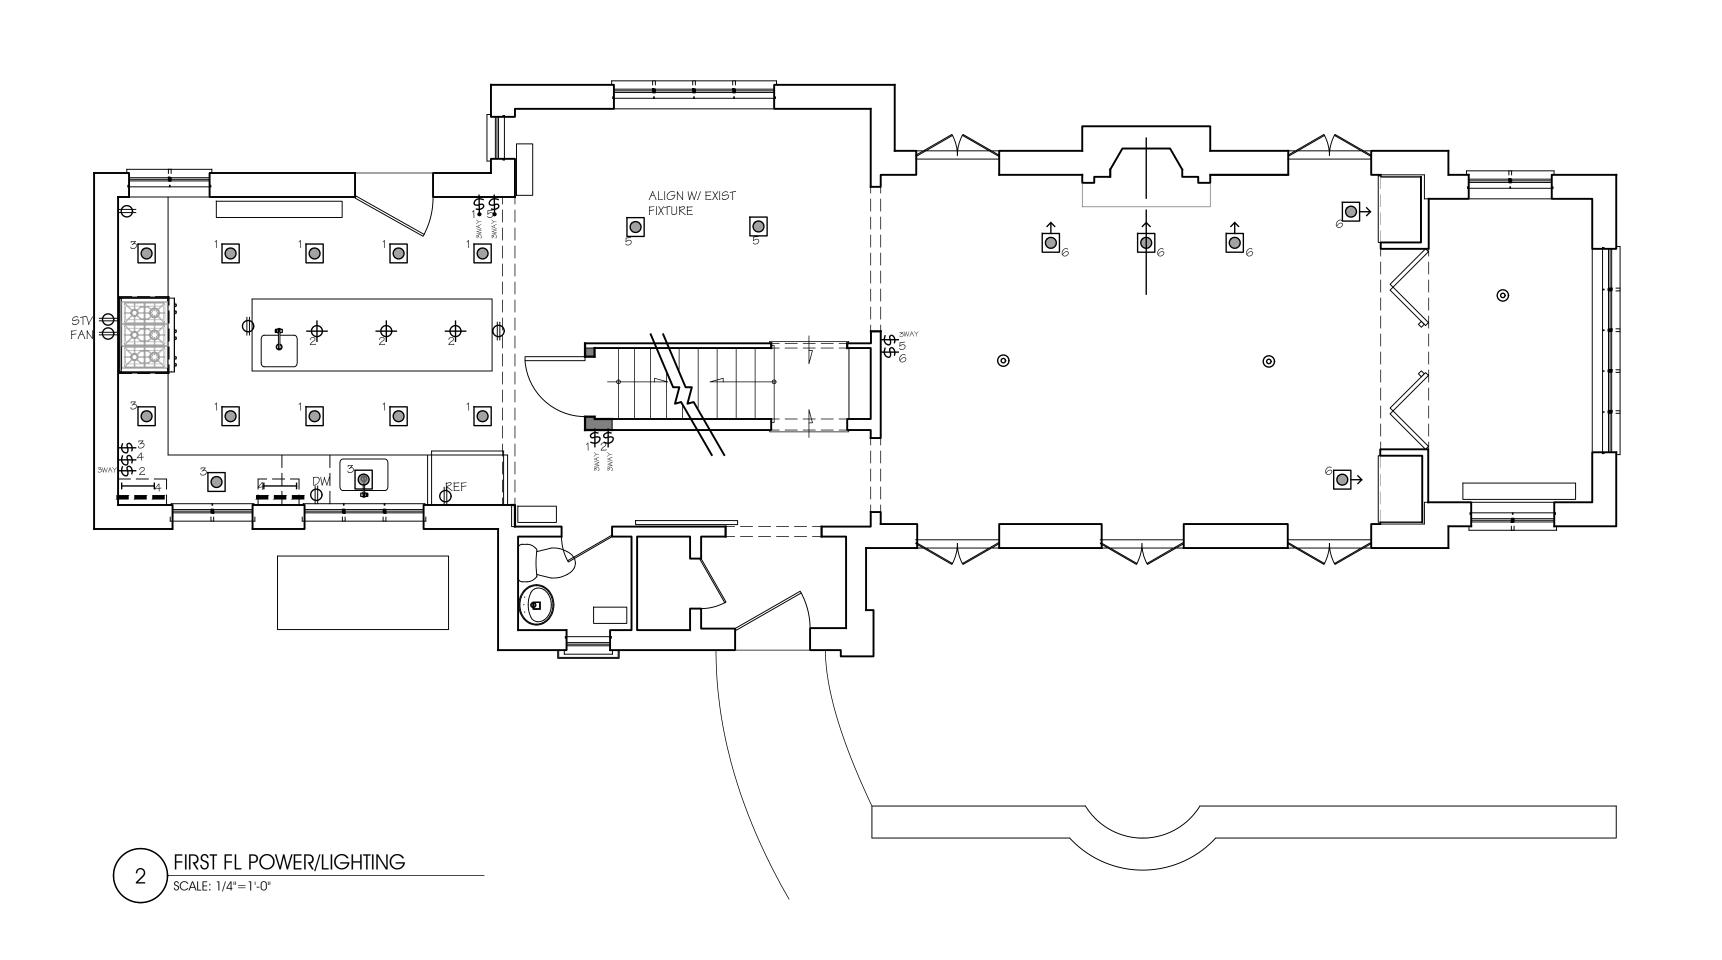

McC | Architecture pllc

25 n. dutcher st., irvington, ny 10533 | mcc-architecture.com t: 917.887.0975 | e: dmcclure@mcc-architecture.com

NOTES:

PROJECT INFORMATION:

Additions alterations
MOY RESIDENCE
66 EDGARDS LN
67 NGS ON HILDSON NY

REV. #/DATE

DRAWING TITLE:

LIGHTING/POWER PLANS

DRAWING INFO.


E1.0
NOTED

Roof Framing Plan

NOTES:


 Coordinate all dimensions and elevations with Architectural Drawings, and coordinate all work with Electrical, Mechanical, and Plumbing Drawings for floor and wall penetration requirements.

- 2. Refer to S2.0 for Structural Notes and Specifications.
- 3. All structural steel to be supported by steel, masonry, or concrete. Steel will not
- 4. _____ Denotes walls below refer to Architectural Drawing for layout.
- 5. All wood framing permanently exposed to weather shall be pressure treated (P.T.).
- Use joist & beam hangers by Simpson or approved equal all flush framed connections where required.
- Denotes anchor/strap connector by Simpson or approved equal. Refer to anchor/strap schedule for more information.

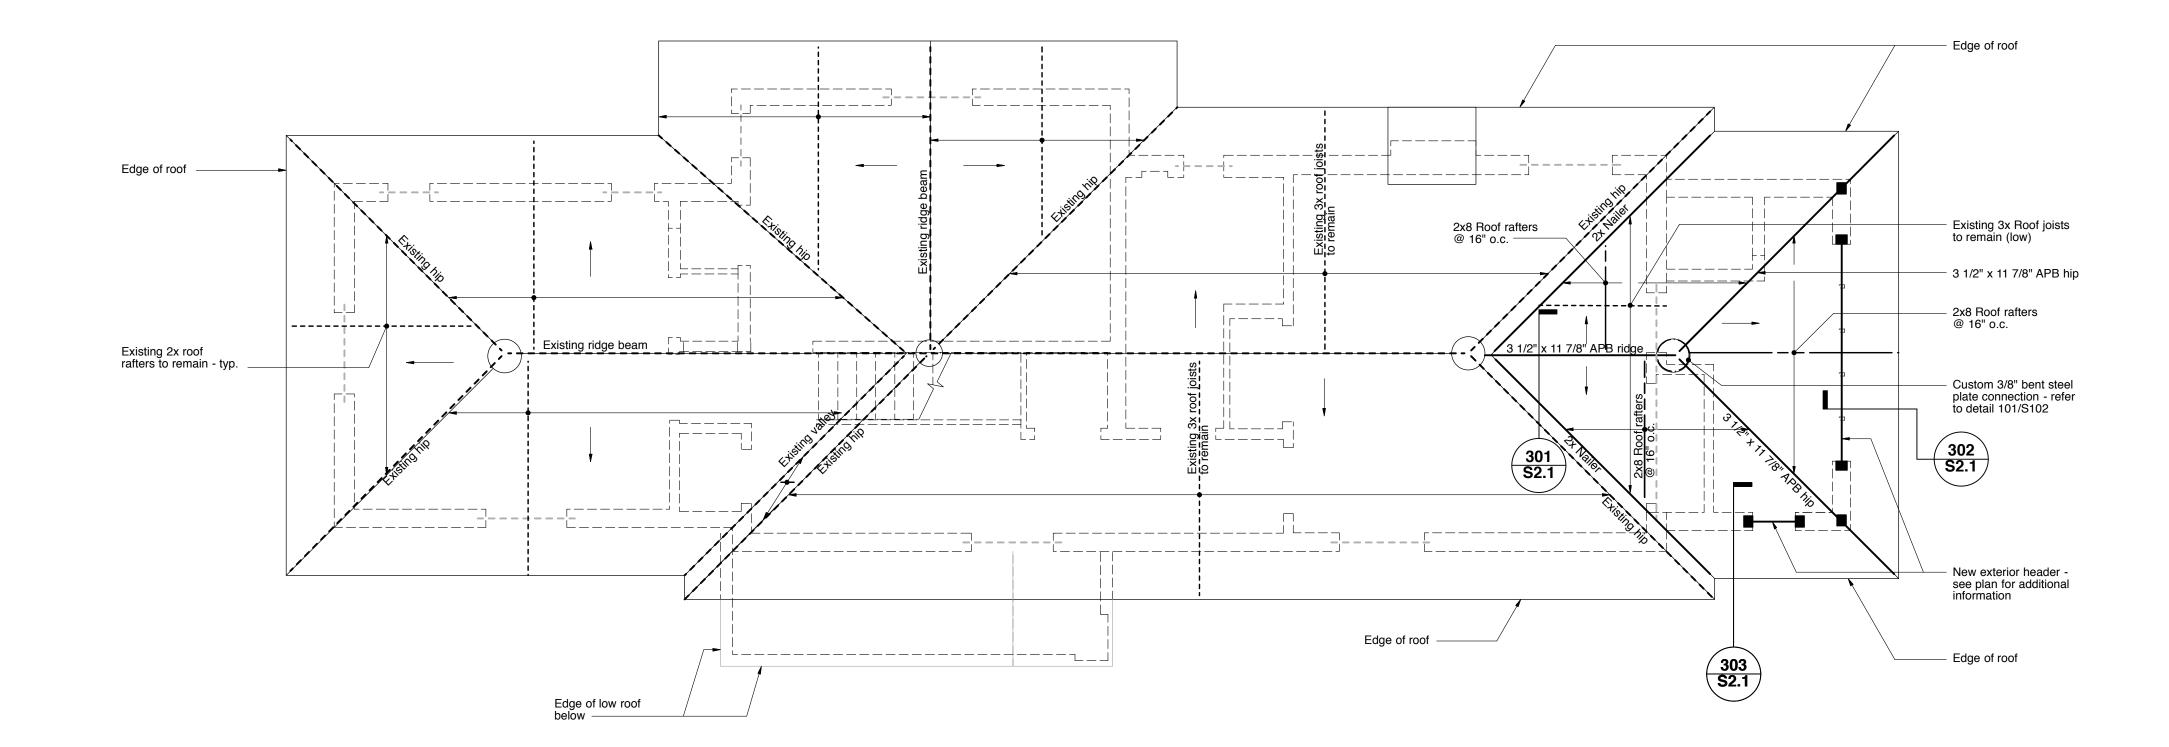

Second Floor Framing Plan

- Coordinate all dimensions and elevations with Architectural Drawings, and coordinate all work with Electrical, Mechanical, and Plumbing Drawings for floor and wall penetration requirements.
- 2. Refer to S2.0 for Structural Notes and Specifications.
- 3. All structural steel to be supported by steel, masonry, or concrete. Steel will not
- 4. Denotes walls above refer to Architectural Drawings for layout. _____ Denotes walls below - refer to Architectural Drawings for layout.
- 5. All wood framing permanently exposed to weather shall be pressure treated (P.T.).
- Use joist & beam hangers by Simpson or approved equal all flush framed connections where required.
- Denotes anchor/strap connector by Simpson or approved equal. Refer to anchor/strap schedule for more information.
- 8. Refer to Detail 203/S2.0 for required strapping @ window.

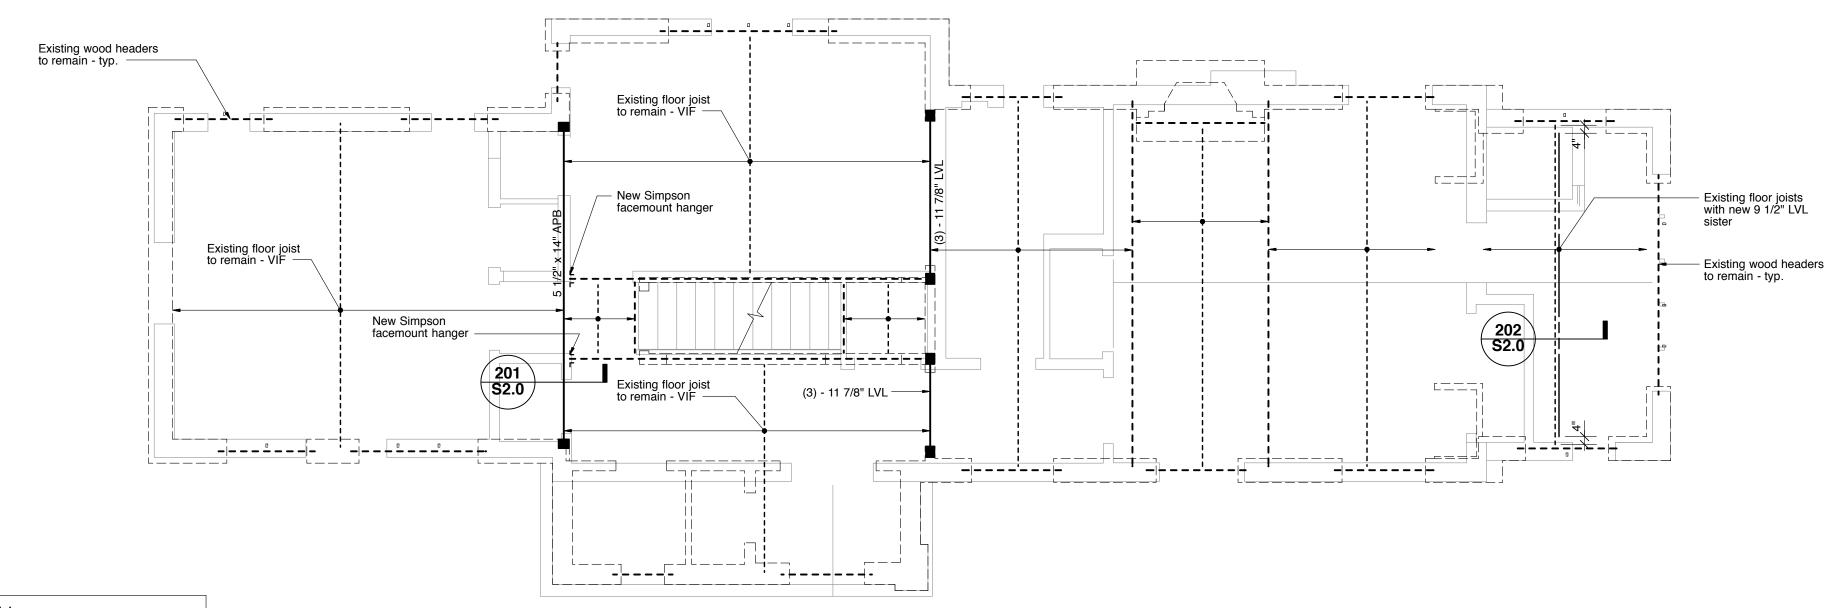


| | Anonor / Grap Concard | | | | |
|---------------------|---|--|--|--|--|
| Plan Desig. | Simpson Connector | Connection Description | | | |
| 1 | LSTA30 | Rafter to rafter over ridge (all rafters) | | | |
| ② H6, H2A | | Rafter over double top plate at eave to stud or beam below (all wall studs) | | | |
| 3 | DSP | All window and door posts to foundation wall | | | |
| 4 LSTA18 @ 32" o.c. | | All exterior headers to posts. If header \geq 8'-0" provide one each side of post, each end of beam. | | | |
| 5 | MSTA36 | 2nd Floor stud to 1st Floor stud @ 32" o.c. | | | |
| | *Note: Provide 5/8" Ø x 1'-4" anchor bolts between sill plates & foundation wall at 36" max use Simpson BP 5/8" Bearing Plate @ each. | | | | |

Anchor / Strap Schedule **Nailing Schedule** 8d @ 6" o.c. @ Panel edge 8d @ 12" o.c. @ Panel interior of adjacent panels 5/8" Plywood Within 3'-0" 8d @ 6" o.c. @ Panel edge of corners 8d @ 6" o.c. @ Panel interior

MCC Architecture pllc

25 n. dutcher st., irvington, ny 10533 mcc-architecture.com t: 917.887.0975 e: dmcclure@mcc-architecture.com

08/09/18 REVIEW SET

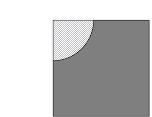

Blue Sky Design, Inc. Consulting Engineers 121 West 27th Street, Suite 904 New York, NY 10001 Tel. 646-230-9900 Fax 646-230-7400

PROJECT INFORMATION:

REV. #/DATE

DRAWING TITLE:

2ND FLOOR & FIRST FLOOR FRAMING PLANS

DRAWING INFO.

19057 - Moy Residence

AS NOTED

Structural Notes:

General:

- 1. All work shall comply with The Building Code of New York State, latest edition, and all other applicable Local Codes and Regulations of Agencies having jurisdiction.
- Work these drawings with the Specifications, the Architectural, Mechanical, Electrical, Plumbing, Site Drawings, and all other related documents. Contractor shall coordinate all dimensions with Architectural drawings and shall verify all data on existing conditions prior to commencement of work.
- 3. Specific notes and details shall take precedence over General Notes and typical details. The Contractor shall refer to the Specifications for information not covered by these General Notes & Specifications
- 4. The Contractor shall provide temporary erection bracing and/or shoring for all structural work as required for structural stability during all phases of construction.
- Contractor shall make special provisions and provide protection as required for cold or hot weather concrete and masonry work, in conformance with the appropriate technical associations.

Loads:

- Floor load, snow load, and wind load have been analyzed in accordance with the Building Code of New York State and ASCE-7 where appropriate.

 Wood Framing:
- All lumber work and materials shall conform to the latest edition of the following Specifications and the The Building Code of New York State:
- a. American Institute of Timber Construction (AITC).
 b. National Forest Products Assoc. "Design Specifications for Stress Grade Lumber".
 c. U.S. Dept. of Commerce Standard CS 253.
 d. American Plywood Association.
- Lumber for all interior structural framing, including roof framing, joists, posts, studs, sills, cap
 plates, wood bearing plates, and blocking, shall be surface dry and used at maximum 19%
 moisture content with the following minimum base design values:

Base Design Values for Visually Graded Dimension Lumber:

Bending: Horizontal Shear: Comp. Perpendicular to Grain: Comp. Parallel to Grain: Modulus of Elasticity:

bearing walls.

Ice Barrier and Underlayment: Required


Fb = 850 psi Fv = 95 psi Fc = 625 psi Fc = 1,300 psi E = 1,600,000 psi


All values shall be adjusted with appropriate adjustment factors as per the per NDS Supplement. Any lumber species may be used, subject to review and acceptance by the Engineer, if they meet the above minimum requirements.

- Should Cedar be used for exterior framing, western species should be used.
- 3. TJI Series:
 TJI joist sections shall be of the size and type specified on the plans, as manufactured by Truss Joist McMillan Ltd., or equal. Flange members, wed members and adhesives shall conform to the provisions of CABO Report No. NER-200. Coordinate bridging and stiffener requirements with TJI manufacturer.
- Plywood: Subfloor shall consist of 3/4" Exposure 1 Grade plywood, glued and screwed to joists. Exterior wall sheathing shall consist of 3/4" Exposure 1 Grade plywood fastened to wall studs with 8d nails at 6" o.c. max.
- 5. Laminated Veneer Lumber:
 Laminated Veneer Lumber (LVL) sections shall be "MICRO=LAM ®" or "PARALLAM ®" as manufactured by Truss Joist MacMillan, Ltd., or equal, with the following minimum properties: Fb = 2865 psi, Fc = 750 psi, Fv = 285 psi, E = 2,000,000 psi.
- Multiple sections shall be fastened together with a minimum of two rows of 16d nails at 12" o.c., and as recommended by the manufacturer.
- All bearing stud walls shall have crosskats at mid-height or 4'-6" o.c. minimum.
 Use double members at all jambs and heads of all openings. Use double joists (min.) below all non-bearing stud walls parallel to spans and provide solid blocking between joists below all


non-bearing stud walls perpendicular to joist spans. Use double sills and cap plates for all


| | LOAD SCHEDULE (I | PSF) | |
|-------------------------|-------------------------------------|------------|--|
| | Floor loads | Roof loads | |
| Dead Load | 25 | 20 | |
| Live Load | 40 | 20 | |
| now load | Ground Snow: | 20 + Drift | |
| | Enclosure Classification: Enclosed* | | |
| Vind Load | Enclosure (Category II): C | | |
| | Wind Speed: | 130 mph | |
| eismic Category: | В | | |
| subject to damage from: | | | |
| Frostline Depth: | 4'-0" Below Grade | | |
| Weathering: Severe | | | |
| Termite: | Moderate - Heavy | | |

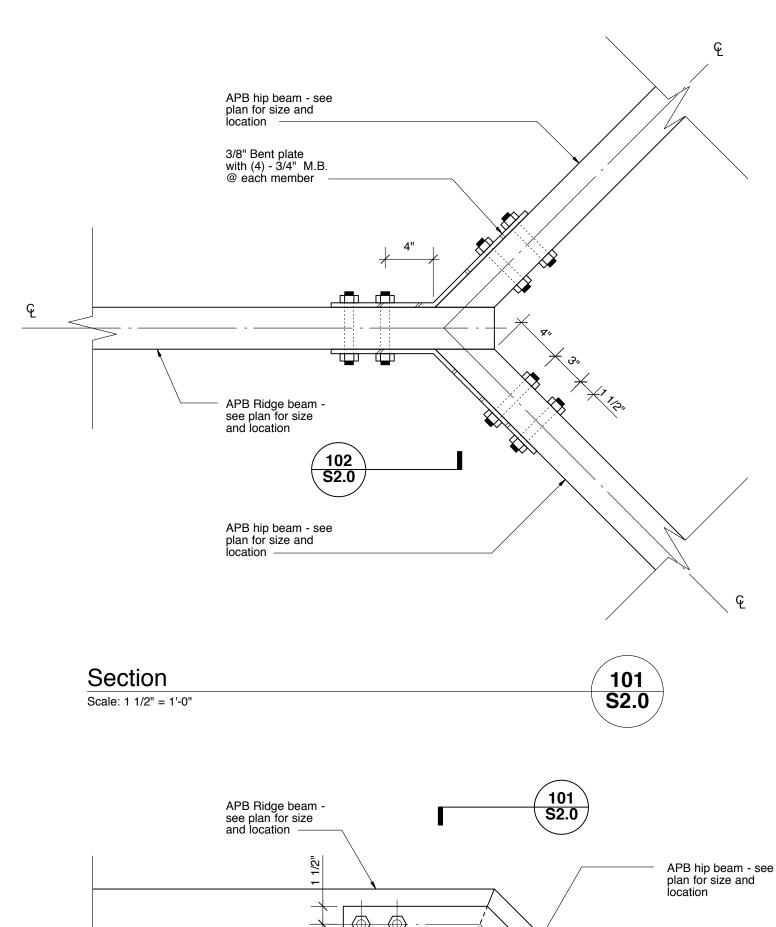


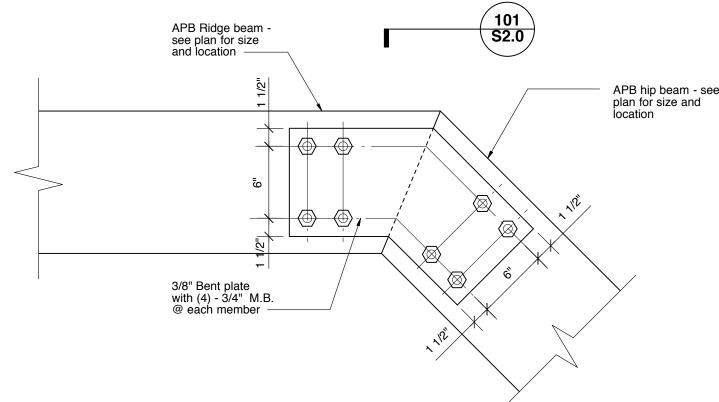



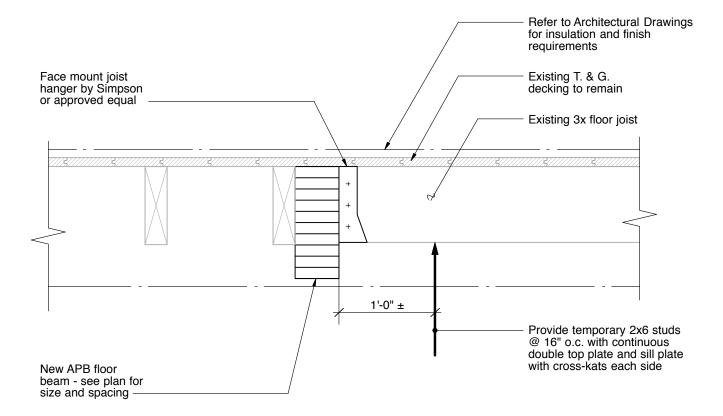

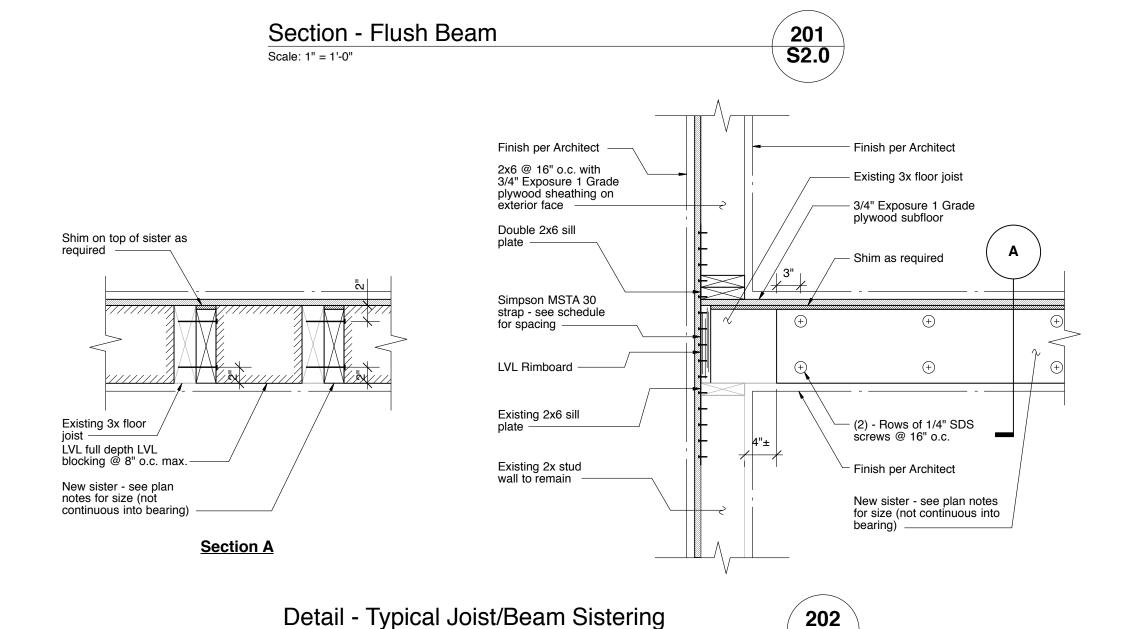

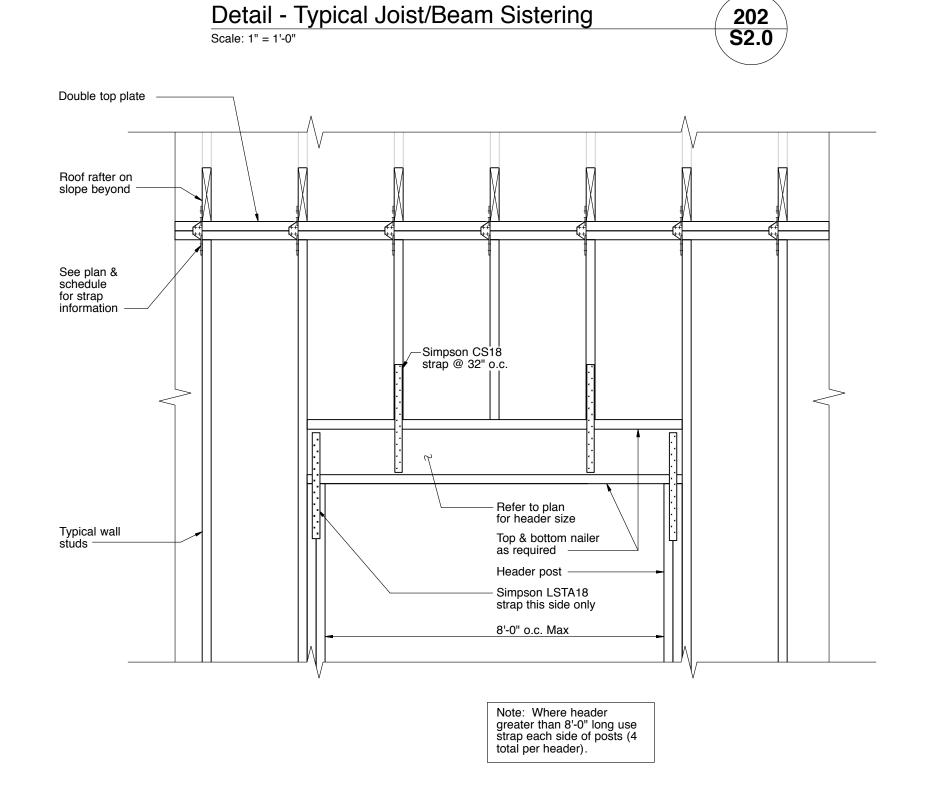

Elevation - Typical 2nd Floor Header To Post Strapping

Scale: N.T.S.

Where Required/View From Exterior




McC Architecture pllc

25 n. dutcher st., irvington, ny 10533 mcc-architecture.com t: 917.887.0975 e: dmcclure@mcc-architecture.com

IOTES:

1. 08/09/18 REVIEW SET

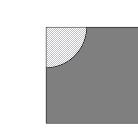

Blue Sky Design, Inc.
Consulting Engineers
121 West 27th Street, Suite 904
New York, NY 10001
Tel. 646-230-9900
Fax 646-230-7400

PROJECT INFORMATION:

Moy Residence
66 Edgars Lane Hastings-on-Hudson, NY

REV. #/DATE


DRAWING TITLE:

STRUCTURAL NOTES, SECTIONS & DETAILS


DRAWING INFO.

S2.0
AS NOTED


Sheet 2 of 3 19057 - Moy Residence

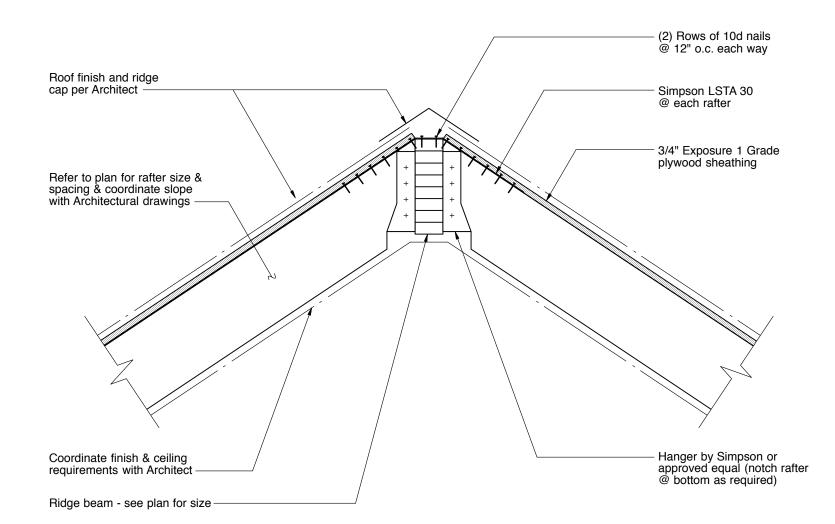



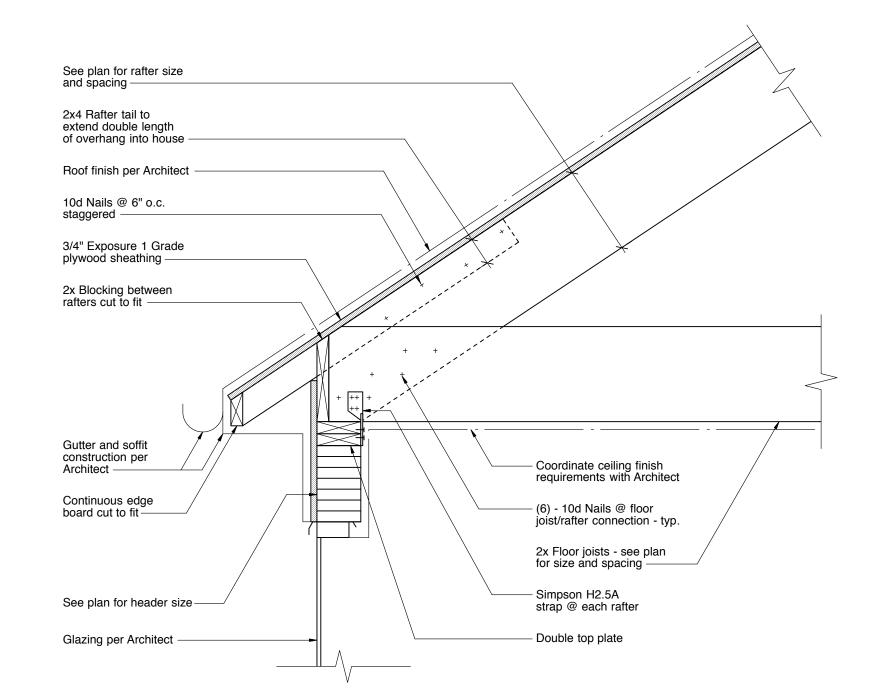



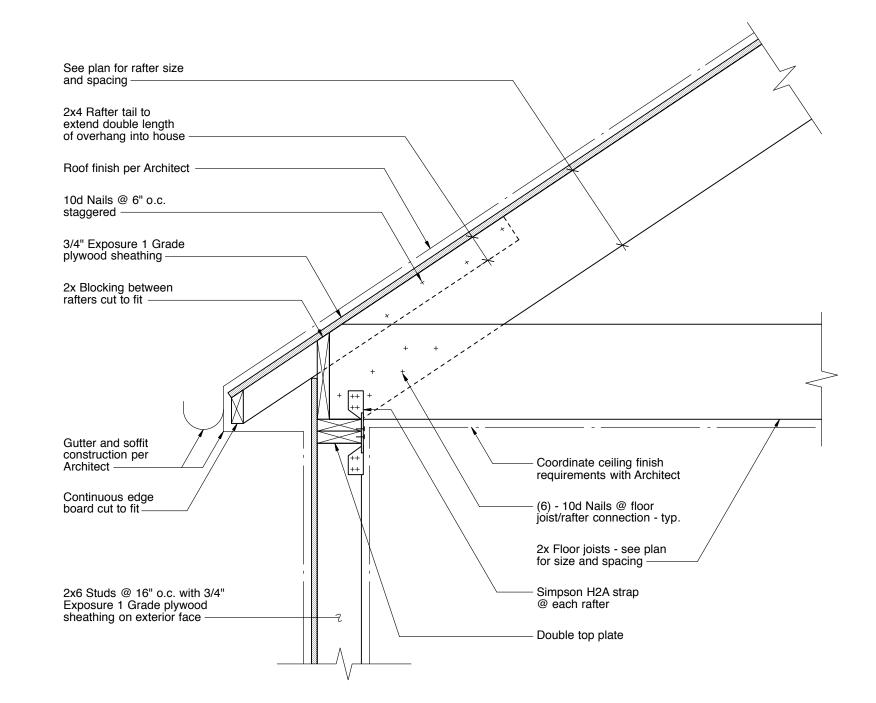

Section - Typical Roof Eave
Scale: 1" = 1'-0"

@ Wall


\$303
\$3.0

McC Architecture pllc

25 n. dutcher st., irvington, ny 10533 mcc-architecture.com t: 917.887.0975 e: dmcclure@mcc-architecture.com

NOTES:

1. 08/09/18 REVIEW SET

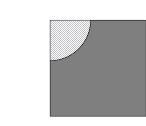

Blue Sky Design, Inc.
Consulting Engineers
121 West 27th Street, Suite 904
New York, NY 10001
Tel. 646-230-9900
Fax 646-230-7400

PROJECT INFORMATION:

Moy Residence
66 Edgars Lane Hastings-on-Hudson, NY

REV. #/DATE

DRAWING TITLE:

SECTIONS & DETAILS

DRAWING INFO.

S2.1
AS NOTED

Sheet 3 of 3 19057 - Moy Residence

Zoning Board of Appeals

<u>Application and Procedure for Application for</u>

Variance/Interpretation/View Preservation



- 1. File one (1) original completed Application and all related drawings and documents, for a Variance, Interpretation or View Preservation Approval, with original signatures and notarization, a flash drive and two (2) copies (residential) or seven (7) copies (commercial) (See requirements in step #2) with the Office of the Building Inspector, no less than four (4) weeks prior to scheduled ZBA meeting.
- 2. Application must be complete with all plans, diagrams, surveys, photographs, etc. as necessary to fully describe requested variance/s and compelling reasons for non-conformity with the zoning regulations.
- 3. Pay an application fee as per following fee schedule:

| \checkmark | Single family residence | \$ 250.00 | \$ 500.00* |
|--------------|---|-----------|-------------|
| \checkmark | Two family residence | \$ 300.00 | \$ 600.00* |
| \checkmark | Multiple family residence | \$ 350.00 | \$ 700.00* |
| \checkmark | Commercial, apartment & office buildings | \$ 500.00 | \$ 1000.00* |
| \checkmark | Industry, subdivision, land development, etc. | \$1000.00 | \$2000.00* |

✓ View Preservation Stand Alone 1-2 Family-\$250.00/\$500.00* Other-\$500.00/\$1000.00*

*For Variances/ZBA action for illegal construction

- 4. Upon receipt of the application and prescribed fee, Office of the Building Inspector will prepare a legal notice describing the variance and submit the notice to an official newspaper for publication.
- Office of the Building Inspector will prepare a mailing list of all neighbors within a 300-foot radius (500-feet if deemed necessary by the Building Inspector) of the subject property and make it available to the applicant prior to the ZBA meeting
- 6. The applicant must pick up copies of the legal notice and mailing list in a timely manner so as to be able to do the following:
 - Either mail copies of the legal notice to neighbors on the mailing list by certified mail requested or any other method of delivery providing proof of delivery no later than 14 days prior to the ZBA meeting
 - Or hand deliver copies of the legal notice no later than 10 days prior to the ZBA meeting.
- 7. No later that one (1) week prior to the ZBA meeting submit the following to the Office of the Building Inspector:

| | P | | |
|---|--|----------------------------------|-----------------|
| | Proof of mailing and and supporting documentation or | ŗ | |
| • | The mailing list with dates and initials of recipients and | d a notarized affidavit stating: | |
| | I, fill in your name | , do hereby swear that all the | e legal notices |
| | were hand delivered to the people on this mailing list | on <u>fill in the date</u> | and that the |
| | signatures/initials of the recipients are authentic. | | |

8. The applicant or his/her authorized representative must appear before the ZBA on the scheduled meeting date to present his/her case, enter into record any additional evidence, and answer any questions.

Submit a flash drive and a total of three (3) copies (residential) or eight (8) copies (commercial), of the application along with the property survey showing the existing and proposed construction and all other supporting documents (plans, drawings, site maps, photographs, etc. as necessary to describe and support your application) with required fee, to the Office of the Building Inspector, no less than four (4) weeks prior to the date of scheduled meeting of the Zoning Board of Appeals.

Zoning Board of Appeals Application and Procedure for Application for Variance/Interpretation/View Preservation



| Case number: | Case number: Date of application: | | | | | | | |
|------------------------|------------------------------------|--|--|--|--|--|--|--|
| Property owner: | | | | | | | | |
| Sheet: 27 | Block: 4.40 | Lot/Parcel: 21 | Zoning District: | | | | | |
| Applicant: | | | | | | | | |
| | uested for (See §295-146B & C : | ☐ Use Variance/s: ☐ Interpretation: e variance or interpretation i | ☐ Area Variance/s; ☐ View Preservation (See §295-82) | | | | | |
| Section* | Code Provision* | Existing Condition* | Proposed Condition* | | | | | |
| 295-68.F1c | Two side yards totalling 30 ft. | Two side yards totalling 26'-7" | No change | | | | | |
| | | | | | | | | |
| *Soo ovample | holow | | | | | | | |
| *See example295-68F.1a | DeTOW: Front Yard Min. 30 ft. deep | 26.5 ft | | | | | | |

Zoning Board of Appeals Zoning Analysis



ZONING REQUIREMENTS:

| YARD SETBACKS | , |
|----------------------|----|
| (Principal Structure | (ڊ |

| | REQUIRED | EXISTING | PROPOSED |
|--------------------|----------|----------|-----------|
| FRONT | 30' | 35'-2" | No change |
| REAR | 30' | 69'-11" | No change |
| SIDE ONE | 12' min. | 6'-1" | No change |
| SIDE TWO | 12' min. | 20'-6" | No change |
| TOTAL OF TWO SIDES | 30' | 26'-7" | No change |

YARD SETBACKS (Accessory Structure)

| | REQUIRED | EXISTING | PROPOSED |
|--------------------|----------|----------|----------|
| TO PRINCIPAL BLDG. | | | |
| REAR | | | |
| SIDE | | | |

BUILDING HEIGHT

| | PERMITTED | EXISTING | PROPOSED |
|---------|-----------|----------|-----------|
| STORIES | 2.5 | 2 | No change |
| FEET | 35 | Existing | No change |

LOT COVERAGE

| | PERMITTED | EXISTING | PROPOSED |
|---|-----------|----------|-----------|
| LOT AREA | 10,000 | 11,466 | No change |
| *BLDG. COVERAGE/ % OF LOT AREA | 2,861 | 1416 | No change |
| *DEVELOPMENT COVERAGE / % OF LOT AREA | 4,006 | 2396 | No change |

*See Definitions of Building and Development Coverage in Section 295-5 of the Village code.

OCCUPANCY AND USE

| | PERMITTED | EXISTING | PROPOSED |
|---------------|---------------|---------------|-----------|
| CURRENT USE** | Single family | Single family | No change |

^{**} Single Family, Two Family, Commercial, Mixed Use etc.

Zoning Board of Appeals Application and Procedure for Application for Variance/Interpretation/View Preservation



List any previous application or appeal filed with The Zoning Board of Appeals for this premises:

| Date of Appeal | Purpose of the Appeal | Resolution if any | Date of Action | | |
|--|------------------------------------|-------------------|----------------|--|--|
| | | | | | |
| List pending v | iolations on this property if any: | | | | |
| | | | | | |
| Is there an approved site plan for this property?: | | (Yes) | | | |
| Is there an Accessory Apartment at this property?: | | (Yes) | (No) | | |
| Does this property have Boarder's Permit?: | | (Yes) | | | |
| On a separate typewritten sheet of paper, state the principal points on which you are making this application. Describe the construction, addition or alteration that requires the variance. Explain why a variance is necessary and demonstrate how the variance satisfies the criteria for the type of variance (use or area) sought. The criteria for the two types of variances are attached. (If an interpretation is sought, explain the issue. If you wish you may also state your argument for how the issue should be resolved.) Submit a flash drive and a total of three (3) copies (residential) or eight (8) copies (commercial), of the application along with the property survey showing the existing and proposed construction and all other supporting documents (plans, drawings, site maps, photographs, etc. as necessary to describe and support your application) with required fee, to the Office of the Building Inspector, no | | | | | |
| less than four (4) weeks prior to the date of scheduled meeting of the Zoning Board of Appeals. STATE OF NEW YORK COUNTY OF WESTCHESTER ss.: | | | | | |
| I hereby depose and say that all of the above statements and statements contained in all papers I have submitted in connection with this application are true: | | | | | |
| Curary to bafara - | Applicant day | | | | |
| of | ne thisday _, 20 | | | | |
| Notary Public | | | | | |

§ 295-146. Variances.

A. The Board of Appeals, on appeal from the decision or determination of the administrative officer charged with enforcement of this chapter, shall have the power to grant use variances and area variances, as defined herein.

B. Use variances.

- 1) "Use variance" shall mean the authorization by the Board of Appeals for the use of land for a purpose that is otherwise not allowed or is prohibited by the applicable zoning regulations.
- 2) No use variance shall be granted by the Board of Appeals without a showing by the applicant that applicable zoning regulations and restrictions have caused unnecessary hardship. In order to prove such unnecessary hardship, the applicant shall demonstrate to the Board of Appeals that for each and every permitted use under the zoning regulations for the particular district where the property is located:
 - a. The applicant cannot realize a reasonable return, provided that lack of return is substantial as demonstrated by competent financial evidence;
 - b. The alleged hardship relating to the property in question is unique, and does not apply to a substantial portion of the district or neighborhood;
 - c. The requested use variance, if granted, will not alter the essential character of the neighborhood; and
 - d. The alleged hardship has not been self-created.
- 3) The Board of Appeals, in the granting of a use variance, shall grant the minimum variance that it shall deem necessary and adequate to address the unnecessary hardship proved by the applicant, and at the same time preserve and protect the character of the neighborhood and the health, safety and welfare of the community.

C. Area variances.

- 1) "Area variance" shall mean the authorization by the Board of Appeals for the use of land in a manner that is not allowed by the dimensional or physical requirements of the applicable zoning regulations.
- 2) In determining whether to grant an area variance, the Board of Appeals shall take into consideration the benefit to the applicant if the variance is granted, as weighed against the detriment to the health, safety and welfare of the neighborhood or community by such grant. In making such determination, the Board of Appeals shall also consider:
 - a. Whether an undesirable change will be produced in the character of the neighborhood or a detriment to nearby properties will be created by the granting of the area variance.
 - b. Whether the benefit sought by the applicant can be achieved by some method, feasible for the applicant to pursue, other than an area variance.
 - c. Whether the requested area variance is substantial.
 - d. Whether the proposed variance will have an adverse effect or impact on the physical or environmental conditions in the neighborhood or district.
 - e. Whether the alleged difficulty was self-created, which consideration shall be relevant to the Board of Appeals but shall not necessarily preclude the granting of the area variance.
- 3) The Board of Appeals, in the granting of an area variance, shall grant the minimum variance that it shall deem necessary and adequate and at the same time preserve and protect the character of the neighborhood and the health, safety and welfare of the community.
- D. Imposition of conditions. The Board of Appeals shall, in the granting of both use variances and area variances, have the authority to impose such reasonable conditions and restrictions as are directly related to and incidental to the proposed use of the property. Such conditions shall be consistent with the spirit and intent of this chapter, and shall be imposed for the purpose of minimizing any adverse impact such variance may have on the neighborhood or community.

CODE OF THE VILLAGE OF HASTINGS ON HUDSON

§ 295-82. View Preservation (VP) Districts

- A. Principal and accessory uses. Subject to the provisions of Subsection <u>C</u> below, the permitted principal and accessory uses for any lot or parcel in a VP District shall be the same as otherwise permitted in the district in which the lot or parcel is located.
- C. Approval by Planning Board and Board of Appeals.
 - (1) No building or structure shall be erected, altered, enlarged or moved in the district unless approved in accordance with the provisions of this section.
 - (2) Every application to permit the erection or exterior alteration of a building or structure in a VP District shall be referred by the Building Inspector to the Planning Board for its report and recommendations as to the best siting, dimensions and configuration of principal and accessory structures so as to cause the least possible obstruction of the view of the Hudson River and the Palisades for neighboring properties and adjacent public property and rights-of-way. The Planning Board shall issue its report and recommendations within 60 days after receipt of the application.
 - (3) After approval by the Planning Board, the plan for erection or exterior alteration of the building or structure shall be referred to the Board of Appeals, which shall conduct a public hearing on the plan. The Board of Appeals shall hold the hearing and render its decision within 60 days after the referral by the Planning Board.
 - (4) Joint notice of both the Planning Board meeting at which the application is to be considered and the Board of Appeals public hearing on the application shall be given at least 14 days before the Planning Board meeting. Notice shall be given as required in § 295-143C. In addition, notice shall be given to the Architectural Review Board and shall be published in a newspaper of general circulation in the Village not less than 10 days before both the Planning Board meeting and the Board of Appeals hearing.