12 Spring Street Hastings-on-Hudson New York 10706 914.478.0799



christinagriffinarchitect.com

January 30, 2023

Chairperson and Members of the Hastings-on-Hudson Zoning Board of Appeals Village of Hastings-on-Hudson 7 Maple Avenue, Hastings-on-Hudson, NY 10706

Re: Renovations and Extensions to the Brower Residence 26 Amherst Drive, Hastings-on-Hudson NY SBL: 4.110-112-10 Building Permit Application #141

Dear Chairperson and Members of the Zoning Board:

As the architect representing Peter and Rebecca Brower, owners of 26 Amherst Drive, we are submitting the following documents for review by the Zoning Board of Appeals:

- A-0 Title Sheet
- S-1 Site Plan, Zoning Compliance, Coverage Calculations, Area Map
- S-2 Area Map, Photos of Neighboring Properties & Photos of Existing Conditions
- A-1 Entry Level Floor Plan
- A-2 Primary Bedroom Level Plan
- A-3 Roof Plan
- A-4 Exterior Elevations
- A-5 Exterior Elevations
- D-1 Demolition Plans Site Survey

We are requesting that the Zoning Board of Appeals grant the following variances from the Hastings Zoning Code:

## 1. Variance from Section 295-68F.1(a) – Front Yard Setback

We are requesting a variance for a 21.9 ft front yard setback on the northeast side of the property. This property is a corner lot so side setbacks are not in effect on this side of the house and the required front yard setback is 30 ft. The variance requested is for 8.1 ft which matches the front yard variance granted for this property on July 20<sup>th</sup> 1962, granted in order to build the existing garage.

We propose to extend the main level of the house over the existing garage and build an addition to complement this extension which will maintain the current front setback of 21.9 ft on the northeast side of the house.

**2.** Variance from Section 295-55.A&B - Extension of a Legally Non-Conforming Structure We are requesting a variance for an extension to a legally non-conforming structure. The existing garage is 21.9 ft from the front property line instead of the required 30 ft setback. A variance was granted for this garage on July 20<sup>th</sup> 1962, per documentation provided to our firm.

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We propose to improve the use of the space above the garage, which is currently a deck, by enclosing a portion of it. This proposed extension, along with a proposed addition will become a family room and a home office/guest room on the main level of the house. The proposed addition will enlarge the main level by 326 sf beyond the footprint of the existing garage, 55 sf of which requires a variance from front setback requirements yet maintains the existing front setback of 21.9 ft.

## 3. Variance from Section 295-68F.1(b) – Rear Yard Setback

We are requesting a variance for a 27.67 ft rear yard setback. The required rear yard setback is 30 ft. The variance requested is for 2.3 ft.

We propose an addition to the main level of the house to accommodate the need for a home office/guest room to improve the use of this small 2,318 sf house. The area of the addition that is beyond the rear setback line is limited with a footprint of 12 sf.

We appreciate your understanding of our request for these variances and look forward to presenting the drawings at the next Zoning Board of Appeals meeting. Thank you for your time and consideration to review our proposal.

Sincerely,

Christina Griffin AIA LEED AP CPHC Principal CGA Studio Architects



## VILLAGE OF HASTINGS-ON-HUDSON

Zoning Board of Appeals Application and Procedure for Application for Variance/Interpretation/View Preservation



- File one (1) original completed Application and all related drawings and documents, for a Variance, Interpretation or View Preservation Approval, with original signatures and notarization, a flash drive and two (2) copies (residential) or seven (7) copies (commercial) (<u>See requirements in step #2</u>) with the Office of the Building Inspector, no less than four (4) weeks prior to scheduled ZBA meeting. <u>(All dimensions on application MUST be in decimal format)</u>
- 2. Application must be complete with all plans, diagrams, surveys, photographs, etc. as necessary to fully describe requested variance/s and compelling reasons for non-conformity with the zoning regulations.
- 3. Pay an application fee as per following fee schedule:

$\checkmark$	Single family residence	\$ 250.00	\$ 500.00*
$\checkmark$	Two family residence	\$ 300.00	\$ 600.00*
$\checkmark$	Multiple family residence	\$ 350.00	\$ 700.00*
$\checkmark$	Commercial, apartment & office buildings	\$ 500.00	\$ 1000.00*
$\checkmark$	Industry, subdivision, land development, etc.	\$1000.00	\$2000.00*
$\checkmark$	View Preservation Stand Alone	1-2 Family-\$250.00/\$500.00*	Other-\$500.00/\$1000.00*

## \*For Variances/ZBA action for illegal construction

- 4. Upon receipt of the application and prescribed fee, Office of the Building Inspector will prepare a legal notice describing the variance and submit the notice to an official newspaper for publication.
- Office of the Building Inspector will prepare a mailing list of all neighbors within a 300-foot radius (500-feet if deemed necessary by the Building Inspector) of the subject property and make it available to the applicant prior to the ZBA meeting
- 6. The applicant must pick up copies of the legal notice and mailing list in a timely manner so as to be able to do the following:
  - Either mail copies of the legal notice to neighbors on the mailing list by certified mail requested or any other method of delivery providing proof of delivery no later than 14 days prior to the ZBA meeting
  - Or hand deliver copies of the legal notice no later than 10 days prior to the ZBA meeting.
- 7. <u>No later that one (1) week prior to the ZBA meeting</u> submit the following to the Office of the Building Inspector:
  - Proof of mailing and and supporting documentation or
  - The mailing list with dates and initials of recipients and a notarized affidavit stating:

I, fill in your name ,	do hereby swear that all the le	gal notices
were hand delivered to the people on this mailing list on	fill in the date	and that the
signatures/initials of the recipients are authentic.		

8. The applicant or his/her authorized representative must appear before the ZBA on the scheduled meeting date to present his/her case, enter into record any additional evidence, and answer any questions.

Submit a flash drive and a total of three (3) copies (residential) or eight (8) copies (commercial), of the application along with the property survey showing the existing and proposed construction and all other supporting documents (plans, drawings, site maps, photographs, etc. as necessary to describe and support your application) with required fee, to the Office of the Building Inspector, no less than four (4) weeks prior to the date of scheduled meeting of the Zoning Board of Appeals.

## VILLAGE OF HASTINGS-ON-HUDSON Zoning Board of Appeals <u>Application and Procedure for Application for</u> <u>Variance/Interpretation/View Preservation</u>



Case number:						
Property add	er: Peter and Rebecca Brown ress: 26 Amherst Drive ts on which the property is loca					
		Lot/Parcel: 10	Zoning District: R-10			
Standing of ap Address: 26 A Daytime phone	Applicant       Peter and Rebecca Brower         Standing of applicant if not owner:					
ZBA action requested for (See §295-146B & C :          □ Use Variance/s;         □ Interpretation;         □ View Preservation (See §295-82)						
List code section	ons & provisions from which th	e variance or interpretation is r	requested:			
Section*	Code Provision*	Existing Condition*	Proposed Condition*			
295-68 F.1a	Front Yard Min. 30 FT deep	21.9 FT to Garage (Variance dated 7/20/1962)	21.9 FT to Addition			
295-55 A+B	Prohibition on extension of non-conformity	21.9 FT Lawfully non-conforming Front yard setback	21.9 FT Front yard setback to Addition			

 295-68 F.1b
 Rear Yard Min. 30 FT deep
 41.1 FT to Garage
 27.67 FT to Addition

\*See example below:

295-68F.1a	Front Yard Min. 30 ft. deep	26.5 ft	19.5 ft
295-68A	Permitted Principal Use	Single Family Home	Conversion to Dental Office

## VILLAGE OF HASTINGS-ON-HUDSON Zoning Board of Appeals Zoning Analysis



## ZONING REQUIREMENTS:

YARD SETBACKS (Principal Structure)

	REQUIRED	EXISTING	PROPOSED
FRONT	30 FT	21.9 FT (Variance dated 7/2/1962)	21.9 FT Non-Conforming
REAR	30 FT	41.1 FT	27.67 FT Non-Conforming
SIDE ONE	12 FT	8.1 FT (Existing Non-Conforming)	8.1 FT (Existing Non-Conforming)
SIDE TWO	12 FT	N/A Single Side Yard - Corner Lot	N/A Single Side Yard - Corner Lot
TOTAL OF TWO SIDES	30 FT	N/A Single Side Yard - Corner Lot	N/A Single Side Yard - Corner Lot

## YARD SETBACKS (Accessory Structure)

	REQUIRED	EXISTING	PROPOSED
TO PRINCIPAL BLDG.	8 FT	N/A	N/A
REAR	8 FT	N/A	N/A
SIDE	8 FT	N/A	N/A

## **BUILDING HEIGHT**

	PERMITTED	EXISTING	PROPOSED
STORIES	2-1/2	2 (Split Level)	2 (Split Level)
FEET	35 FT	28 FT	28 FT

## LOT COVERAGE

	PERMITTED	EXISTING	PROPOSED
LOT AREA	10,000 SF	10,265 SF	10,265 SF
*BLDG. COVERAGE/ % OF LOT AREA	2,566 SF / 25%	1,373 SF / 13%	1,700 SF / 17%
*DEVELOPMENT COVERAGE/ % OF LOT AREA	3,593 SF / 35%	2,358 SF / 23%	2,682 SF / 26%

## OCCUPANCY AND USE

	PERMITTED	EXISTING	PROPOSED
CURRENT USE**	Single-Family	Single-Family	Single-Family

\*\* Single Family, Two Family, Commercial, Mixed Use etc.

## VILLAGE OF HASTINGS-ON-HUDSON

Zoning Board of Appeals Application and Procedure for Application for Variance/Interpretation/View Preservation



List any previous application or appeal filed with The Zoning Board of Appeals for this premises:

Date of Appeal	Purpose of the Appeal	Resolution if any	Date of Action
7/2/1962	Garage Addition Non-conforming Front Yard Setback	Variance Granted	7/20/1962

List pending violations on this property if any:

*	Is there an approved site plan for this property?:	X(No)
,	Is there an Accessory Apartment at this property?:	⊠(No)
	Does this property have Boarder's Permit?:	[X](No)

On a separate typewritten sheet of paper, state the principal points on which you are making this application. Describe the construction, addition or alteration that requires the variance. Explain why a variance is necessary and demonstrate how the variance satisfies the criteria for the type of variance (use or area) sought. The criteria for the two types of variances are attached. (If an interpretation is sought, explain the issue. If you wish you may also state your argument for how the issue should be resolved.)

Submit a flash drive and a total of three (3) copies (residential) or eight (8) copies (commercial), of the application along with the property survey showing the existing and proposed construction and all other supporting documents (plans, drawings, site maps, photographs, etc. as necessary to describe and support your application) with required fee, to the Office of the Building Inspector, no less than four (4) weeks prior to the date of scheduled meeting of the Zoning Board of Appeals.

## STATE OF NEW YORK · COUNTY OF WESTCHESTER ss.:

I hereby depose and say that all of the above statements and statements contained in all papers I have submitted in connection with this application are true:

Sworn to before me this NUAU, 201

Applicant

MARY ELLEN BALLANTINE Notary Public, State of New York Reg #01BA6278291 Qualified in Westchester County Commission Expires 3/25/2025

## **VILLAGE OF HASTINGS-ON-HUDSON**

Zoning Board of Appeals Application and Procedure for Application for Variance/Interpretation/View Preservation



Name : Peter and Rebecca Brower	, being duly sworn, deposes and says that
he/she resides at 26 Amherst Drive	in the Village of Hastings-on-
Hudson in the County of Westchester, in the State of New York, that	
parcel of land, in fee, lying and being in the Village of Hastings-on-H	udson aforesaid and known and
1 1 1 1 1 1 1 1 1 1 1 1	ot <u>10</u> of the tax map, and that
he/she hereby authorized Christina Griffin Architect	to make the annexed
application in his/her behalf and that the statement of fact contained	

STATE OF NEW YORK COUNTY OF WESTCHESTER ss.:

Owner

th TO BEFORE ME THIS 26 SWORN DAY 23 OF 20

Notary Public

MARY ELLEN BALLANTINE Notary Public, State of New York Reg #01BA6278291 Qualified in Westchester County Commission Expires 3/25/2025

## NOTICE

This application will not be accepted for filing unless accompanied by all necessary papers, plans and data, in accordance with the foregoing and as required by law.

## § 295-146. Variances.

- A. The Board of Appeals, on appeal from the decision or determination of the administrative officer charged with enforcement of this chapter, shall have the power to grant use variances and area variances, as defined herein.
- B. Use variances.
  - 1) "Use variance" shall mean the authorization by the Board of Appeals for the use of land for a purpose that is otherwise not allowed or is prohibited by the applicable zoning regulations.
  - 2) No use variance shall be granted by the Board of Appeals without a showing by the applicant that applicable zoning regulations and restrictions have caused unnecessary hardship. In order to prove such unnecessary hardship, the applicant shall demonstrate to the Board of Appeals that for each and every permitted use under the zoning regulations for the particular district where the property is located:
    - a. The applicant cannot realize a reasonable return, provided that lack of return is substantial as demonstrated by competent financial evidence;
    - b. The alleged hardship relating to the property in question is unique, and does not apply to a substantial portion of the district or neighborhood;
    - c. The requested use variance, if granted, will not alter the essential character of the neighborhood; and
    - d. The alleged hardship has not been self-created.
  - 3) The Board of Appeals, in the granting of a use variance, shall grant the minimum variance that it shall deem necessary and adequate to address the unnecessary hardship proved by the applicant, and at the same time preserve and protect the character of the neighborhood and the health, safety and welfare of the community.
- C. Area variances.
  - 1) "Area variance" shall mean the authorization by the Board of Appeals for the use of land in a manner that is not allowed by the dimensional or physical requirements of the applicable zoning regulations.
  - 2) In determining whether to grant an area variance, the Board of Appeals shall take into consideration the benefit to the applicant if the variance is granted, as weighed against the detriment to the health, safety and welfare of the neighborhood or community by such grant. In making such determination, the Board of Appeals shall also consider:
    - a. Whether an undesirable change will be produced in the character of the neighborhood or a detriment to nearby properties will be created by the granting of the area variance.
    - b. Whether the benefit sought by the applicant can be achieved by some method, feasible for the applicant to pursue, other than an area variance.
    - c. Whether the requested area variance is substantial.
    - d. Whether the proposed variance will have an adverse effect or impact on the physical or environmental conditions in the neighborhood or district.
    - e. Whether the alleged difficulty was self-created, which consideration shall be relevant to the Board of Appeals but shall not necessarily preclude the granting of the area variance.
  - 3) The Board of Appeals, in the granting of an area variance, shall grant the minimum variance that it shall deem necessary and adequate and at the same time preserve and protect the character of the neighborhood and the health, safety and welfare of the community.
- D. Imposition of conditions. The Board of Appeals shall, in the granting of both use variances and area variances, have the authority to impose such reasonable conditions and restrictions as are directly related to and incidental to the proposed use of the property. Such conditions shall be consistent with the spirit and intent of this chapter, and shall be imposed for the purpose of minimizing any adverse impact such variance may have on the neighborhood or community.

## § 295-82. View Preservation (VP) Districts

- A. Principal and accessory uses. Subject to the provisions of Subsection <u>C</u> below, the permitted principal and accessory uses for any lot or parcel in a VP District shall be the same as otherwise permitted in the district in which the lot or parcel is located.
- C. Approval by Planning Board and Board of Appeals.
  - (1) No building or structure shall be erected, altered, enlarged or moved in the district unless approved in accordance with the provisions of this section.
  - (2) Every application to permit the erection or exterior alteration of a building or structure in a VP District shall be referred by the Building Inspector to the Planning Board for its report and recommendations as to the best siting, dimensions and configuration of principal and accessory structures so as to cause the least possible obstruction of the view of the Hudson River and the Palisades for neighboring properties and adjacent public property and rights-of-way. The Planning Board shall issue its report and recommendations within 60 days after receipt of the application.
  - (3) After approval by the Planning Board, the plan for erection or exterior alteration of the building or structure shall be referred to the Board of Appeals, which shall conduct a public hearing on the plan. The Board of Appeals shall hold the hearing and render its decision within 60 days after the referral by the Planning Board.
  - (4) Joint notice of both the Planning Board meeting at which the application is to be considered and the Board of Appeals public hearing on the application shall be given at least 14 days before the Planning Board meeting. Notice shall be given as required in § 295-143C. In addition, notice shall be given to the Architectural Review Board and shall be published in a newspaper of general circulation in the Village not less than 10 days before both the Planning Board meeting and the Board of Appeals hearing.

Application No.141Job Location26 Amherst Dr Hastings-on-Hudson NY 10706Property ownerPeter and Rebecca Brower

RE: SURVEY OF 26 AMHERST DRIVE, HASTINGS-ON-HUDSON NY 10706 SECTION 4.110 BLOCK 112 LOT 10 BY ALL COUNTY LAND SURVEYOR PC DATE SURVEYED: MAY 19, 2022

THE SURVEY WHICH IS BEING SUBMITTED IS "AS THE PROPERTY CURRENTLY EXISTS."

**Owner's Signature** 

th SWORN TO BEFORE ME THIS 26 DAY OF annar 20 23

Notary Public

MARY ELLEN BALLANTINE Notary Public, State of New York Reg #01BA6278291 Qualified in Westchester County Commission Expires 3/25/2025

# RENOVATIONS & EXTENSIONS TO THE BROWER RESIDENCE 26 AMHERST DRIVE, HASTINGS.ON.HUDSON, NY 10706 CGA STUDIO ARCHITECTS 12 SPRING STREET, HASTINGS.ON.HUDSON, NY 10706



# GENERAL NOTES

- 1. These documents remain the exclusive property of the Architect, and may not be used for any purpose whatsoever without written consent of the Architect.
- 2. All construction shall comply fully with the 2020 Residential code of NYS, NY Stretch Energy Code and code, fire department regulations, and all other agencies
- having jurisdiction over project.
- on site for all inspections.
- 4. A current Westchester County licensed and insured contractor must be on file with current building permit until Certificate of Occupancy is issued. If contractor of record has been removed from the project, a stop work order will be issued until a new Westchester County licensed and insured contractor is retained.
- 5. General Contractor shall carry property damage insurance, public liability insurance, workman's compensation, auto insurance, and general liability as required by Federal, State, and Local Codes and as Owner requires.
- 6. Licensed electrician to file separate electrical permit.
- 7. Licensed plumber to file separate plumbing permit. 8. All health, safety, fire, zoning and environmental
- regulations shall be adhered to at all times by the Owner and/or occupant.
- 9. The contractor shall become familiar with conditions of the site, and the work as shown on the construction documents, prior to submitting a bid for construction.
- 10. Contractors shall coordinate all work procedures and working hours with local authorities, neighborhood associations, and any other governing authorities.
- 11. The contractor shall be responsible for providing all labor and materials to complete the project, in accordance with the construction documents, tested and ready for Owner's use.
- 12. All indicated Survey material is for general reference only. The Architect assumes no responsibility for the accuracy or the correctness of the indicated material
- 13. Contractors shall be responsible for protection of all existing and new conditions and materials with and adjacent to the construction area. Any damage caused by 23. The drawings and notes are intended to be complete. the execution of the work indicated or implied herein shall be repaired or replaced to the Owner's satisfaction.
- 14. All construction sites shall conform to the 2020 New York State Property Maintenance Code. All rubbish

garbage and construction debris shall be disposed of in an with the total completion of all work included within the 33. Substitutions of equipment or materials other than those onsite dumpster or removed off site immediately. Materials shall be stacked in orderly fashion as to not create a blight on the community. The village right of way 24. Minor details not usually shown or specified, but must be kept clear and maintained at all times.

- Hastings-on-Hudson Green Building Code, local building 15. General contractor shall be responsible for the removal of construction debris, rubbish and offsite disposal in a responsible manner.
- 3. Approved stamped set of building plans must be present 16. The contractor shall obtain all inspections, approvals and his best skill and attention, he shall be solely responsible permits, and pay all necessary permit fees required by the for all construction means, methods, sequences and local building department and all other agencies having jurisdiction over the project, such as plumbing, electrical & HVAC, except for the building permit, which shall be obtained by the Architect. The contractor shall obtain the certificate of occupancy for the project when construction is complete
  - 17. Contractor shall keep work site free from debris and accumulated refuse, and shall have sole responsibility for protecting all dangerous areas from entry by unauthorized parties.
  - 18. Drawings may be rough scaled for estimating & general purposes, but are not to be scaled for construction locations, dimensions, or any other purposes. Dimensions shown shall govern over measurements scaled from plans. Wall dimensions are given to finished surfaces. Contractor to consult with the Architect for questions regarding final dimensions and locations.
  - 19. All dimensions and conditions shown and assumed on the drawings must be verified at the site by contractor before ordering any material or doing any work.
  - 20.Contractor is to design and install adequate and code approved shoring and bracing where needed to safely complete structural work. Contractor to assume full and sole responsibility for structural adequacy of the shoring 31. If blown or sprayed insulation used, Installer of insulation 36. Finish materials and paint colors shall be reviewed and and for any injuries, damages, cracks, or defects caused by shoring or bracing, and shall repair all such damage at his sole expense.
  - 21. The Architect is not responsible for workmanship, construction methods, or any omissions or derivations from the drawings during construction.
  - 22.Materials and products indicated on drawings shall be installed in accordance with manufacturer's requirements
  - Should anything be omitted from the drawings necessary to the proper construction of the work herein described, it shall be the duty of the contractor to notify the Architect. The builder shall visit the site and inform the Architect of any discrepancies of field conditions that may interfere

contract and verify all conditions prior to the ordering of materials and the start of construction.

- necessary for proper and acceptable construction, installation or operation of any part of the work shall be included in the work the same as specified or indicated. 25. The contractor shall supervise and direct the work using procedures and for coordination of all portions of the work.
- 26. The use of the words "provide" or "provided" in connection with any item specified is intended to mean that such item 34.All work shall be installed so all parts required are readily be furnished and installed and connected where required. 27.Contractor shall maintain a sealed enclosure between
- work area and other areas of the residence. In addition, the contractor shall be responsible to (a) protect all interior made without prior written approval from the Architect. spaces from the area of renovation, and (b) broom sweep 35.Upon completion of the work, the entire project is to be all areas at end of each work day.
- 28. The contractor shall do all the cutting, fitting & patching that may be required to make several parts of the work come together properly, and to fit his work, and/or receive, or be received by the work of others, as shown, or as reasonably implied on the drawings.
- 29.New & existing work shall come together in a seamless fashion.All new or modified surfaces shall be finished including, but not limited to taping, spackling & priming.
- 30. All insulation to comply with the Energy Efficiency Certificate required by 401.3 2020 Energy Conservation Construction Code of New York, prepared by Architect and to comply with NY Stretch Energy Code and Hastings-on-Hudson Green Building Code.
- to submit insulation certification to include the installed thickness of the area covered and R-value of the installed 37. The Architect assumes no responsibility for the accuracy thickness shall be listed on the certificate. The insulation installer shall sign, data and post the certificate in a conspicuous location on the job site per N1101.5 of the 2020 Residential Code of New York State and submit an original signed copy for the Building Departments records.
- 32. All work shall be guaranteed for one year after final payment. The general contractor is to furnish written guarantees on his work and all subcontractors work against defects resulting from the use of inferior materials, equipment, or workmanship as determined solely by the Architect. All such defects are to be replaced or repaired, complete with labor and materials at no cost to owner
- Ceiling Wall

shown on the drawings or in the specifications shall be made only upon approval of the Architect or owner as noted on the drawings or in these specifications. The contractor shall submit his substitution for approval before \*At rooms with ceilings, R-38 insulation extends over releasing any order for fabrication and / or shipments. The Architect reserves the right to disapprove such

substitution, provided in his sole opinion, the item offered is not equal or detailed on the drawings, which requires any redesign of the structure, partitions, piping, redesign, and all new drawings and detailing required therefore shall, with the approval of the Architect, be prepared by the contractor at his own expense.

accessible for inspection, operation, maintenance and repair. Minor deviations from the drawings may be made to accomplish this, but changes of magnitude shall not be

completely cleaned and the site restored to existing condition, including but not limited to the following.

a) Complete sweeping of all areas, and removal of all rubbish and debris, except that caused by the owner or others doing N.I.C. work.

b) Removal of all labels from glass, fixtures, and equipment, etc. and spray cleaning of glass and mirrors. c) Removal of stains, and paint from glass, hardware,

finished flooring, cabinets, etc.

d) Final cleaning of all chrome and aluminum metal work. e) Restoration of property by returning shrubs to original locations, filling of all ruts and raked topsoil and repairs to damaged blacktop.

approved by the homeowner.

or correctness of any material or drawings prepared by others and provided to the Architect.

## Energy Notes R-Values & U-Factors

2020 ECC AMENDED BY NY STRETCH ENERGY CODE Climate Zone 4A

Required		Propos	e
R-49		R-49*	
R-21/20+5	5/13+10	R-21	
	5/13+10		

Glazing Floor Slab

wall plate at eaves to comply with R402.2.1, at cathedral ceilings, R-38 insulation will be installed at roof rafters to comply with R402.2.2 Amended by Stretch Code.

0.27 U value 0.27 U value

R-30

R-10, 4 ft depth R-10, 4 ft depth

R-30

Design Criteria: 5750 Degree Days

15% Maximum Glazing R402.2.1 CEILINGS WITH ATTIC SPACES

Where Section R402.1.2 requires R-49 insulation in the ceiling, installing R-38 over 100% of the ceiling area requiring insulation shall satisfy the requirement for R-49 insulation wherever the full height of uncompressed R-38 insulation extends over the wall top plate at eaves.

R402.2.2 CEILINGS WITHOUT ATTIC SPACES AMENDED BY STRETCH CODE R402.2.2 Where Section R402.1.2 requires insulation greater than R-38 in the ceiling, and the roof / ceiling assembly does not allow sufficient space, the min. R-value shall be R-38. Insulation over and to the outer edge of the top plate shall not be compressed This reduction of insulation shall be limited to 500 square feet, or 20% of the total insulated ceiling area, whichever is less.

Christina Griffin, Architect A.I.A., hereby states that I have prepared these plans and specifications to the best of my knowledge in compliance with all the requirements of the 2020 Residential code of NYS.

## HBGC

HASTINGS GREEN BUILDING CODE COMPLIANCE NOTES

1. NEW PLUMBING FIXTURES TO COMPLY WITH HGBC 160.10A, B & C. 2. PAINTS, STAINS AND OTHER FINISHING

MATERIALS TO COMPLY WITH HGBC 160.11.A.1,2,3,4,& 5

3. CONSTRUCTION WASTE MANAGEMENT TO COMPLY WITH HGBC 160-11.C

4. EXTERIOR LIGHTING CONTROLS TO COMPLY WITH HGBC 160-9.A.1 5. NEW AIR CONDITIONING SYSTEM TO COMPLY WITH HGBC 160-9.A.3

6. ALL NEW FIXTURES APPLIANCES TO COMPLY WITH HGBC 160-9.A.4

7. NEW ELECTRONIC THERMOSTATS FOR HEATING & AIR CONDITIONING ZONES WILL BE PROVIDED, TO COMPLY WITH HGBC 160-9.B.

INS	JL	ΤI	C	)	Ν
REQUIRE		 		-	


CLIMATE ZONE	FENESTRATION U-FACTOR <sup>h</sup>	SKY U-F
4A	0.27	0.5
	MASS WALL <sup>d</sup> R-VALUE	FL R-\
	15/20	

a. R-VALUES ARE MINIMUMS. U-FACTORS AND SHGC ARE MAXIMUMS. WHERE INSULATION IS INSTALLED IN A CAVITY THAT IS LESS THAN THE LABEL OR DESIGN THICKNESS OF THE INSULATION, THE INSTALLED R-VALUE OF THE INSULATION SHALL BE NOT LESS THAN THE R-VALUE SPECIFIED IN THE TABLE. b. INT. (INTERMEDIATE FRAMINGS) DENOTES STANDARD FRAMING 16 INCHES ON CENTER. HEADERS SHALL BE

- INSULATED WITH A MINIMUM OF R-10 INSULATION.
- MORE THAN HALF THE INSULATION IS ON THE INTERIOR OF THE MASS WALL.
- INSULATION AT THE INTERIOR OF THE BASEMENT WALL.
- R-VALUE OF R-19.
- FENESTRATION.

DESIGN	RE	EG
FOR 2020 RESIDENTIA	L COD	E OF

WIND DESIGN GROUND SNOW LOAD SPEED TOPO SPECIAL WI (MPH) EFFECTS WIND REGION DEI 115-125 MPH 30 PSF NO YES

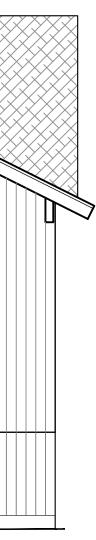

# BUILDING PERMIT & ZBA SUBMISSION 1-30-23

DATES

**BUILDING PERMIT & ZBA SUBMISSION** 

1-30-23

## & FENESTRATION LE R402.1.2 2020 NY ECC AMENDED BY NY STRETCH ENERGY CODE <sup>a</sup>

KYLIGHT <sup>h</sup> J-FACTOR	GLAZED FENESTRATION SHGC <sup>h</sup>	CEILING R-VALUE	WOOD FRAME WALL <sup>b,c</sup> R-VALUE
0.50	0.40	49 see R402.2.1/402.2.2	21 <sup>int.</sup> or 20+5 <sup>cont.</sup> or 13+10 <sup>cont.</sup>
FLOOR R-VALUE	BASEMENT WALL <sup>e</sup> R-VALUE	SLAB <sup>f</sup> R-VALUE & DEPTH	CRAWL SPACE WALL <sup>®</sup> R-VALUE
30 <sup>g</sup>	15/19	10, 4FT (d)	15/19

c. THE FIRST VALUE IS CAVITY INSULATION, THE SECOND VALUE IS CONTINUOUS INSULATION. THEREFORE, AS AN EXAMPLE, "13+10" MEANS R-13 CAVITY INSULATION PLUS R-10 CONTINUOUS INSULATION. d. MASS WALLS SHALL BE IN ACCORDANCE WITH SECTION R402.2.5. THE SECOND R-VALUE APPLIES WHEN

e. 15/19 MEANS R-15 CONTINUOUS INSULATION ON THE INTERIOR OR EXTERIOR OF THE HOME OR R-19 CAVITY

f. R-10 CONTINUOUS INSULATION SHALL BE PROVIDED UNDER THE FULL SLAB AREA OF A HEATED SLAB IN ADDITION TO THE REQUIRED SLAB EDGE INSULATION R-VALUE FOR SLABS AS INDICATED IN THE TABLE. THE SLAB EDGE INSULATION FOR HEATED SLABS SHALL NOT BE REQUIRED TO EXTEND BELOW THE SLAB. g. ALTERNATIVELY, INSULATION SUFFICIENT TO FILL THE FRAMING CAVITY AND PROVIDING NOT LESS THAN AN

h. THE FENESTRATION U-FACTOR COLUMN EXCLUDES SKYLIGHTS. THE SHGC COLUMN APPLIES TO ALL GLAZED



PHOTOS OF NEIGHBORING PROPERTIES &

PHOTOS OF EXISTING CONDITIONS A-1 ENTRY LEVEL FLOOR PLAN A-2 PRIMARY BEDROOM LEVEL FLOOR PLAN

S-2


- A-3 ROOF PLAN
- A-4 SOUTH & WEST ELEVATIONS
- A-5 NORTH & EAST ELEVATIONS
- D-1 DEMOLITION PLANS

SITE SURVEY

# QUIREMENTS

NEW YORK STATE CLIMATIC & GEOGRAPHIC DESIGN CRITERIA

		SUBJECT -	TO DAMA	GE FROM					
'IND ORNE EBRIS ONE	SEISMIC DESIGN CATEGORY	WEATHERING	FROST LINE DEPTH	TERMITE	ICE SHIELD UNDERLAY REQUIRED	FLOOD HAZARDS	AIR FREEZING INDEX	MEAN ANNUAL TEMP	
NO	В	SEVERE	42"	MODERATE TO HEAVY	YES	N/A	2000	51.6	

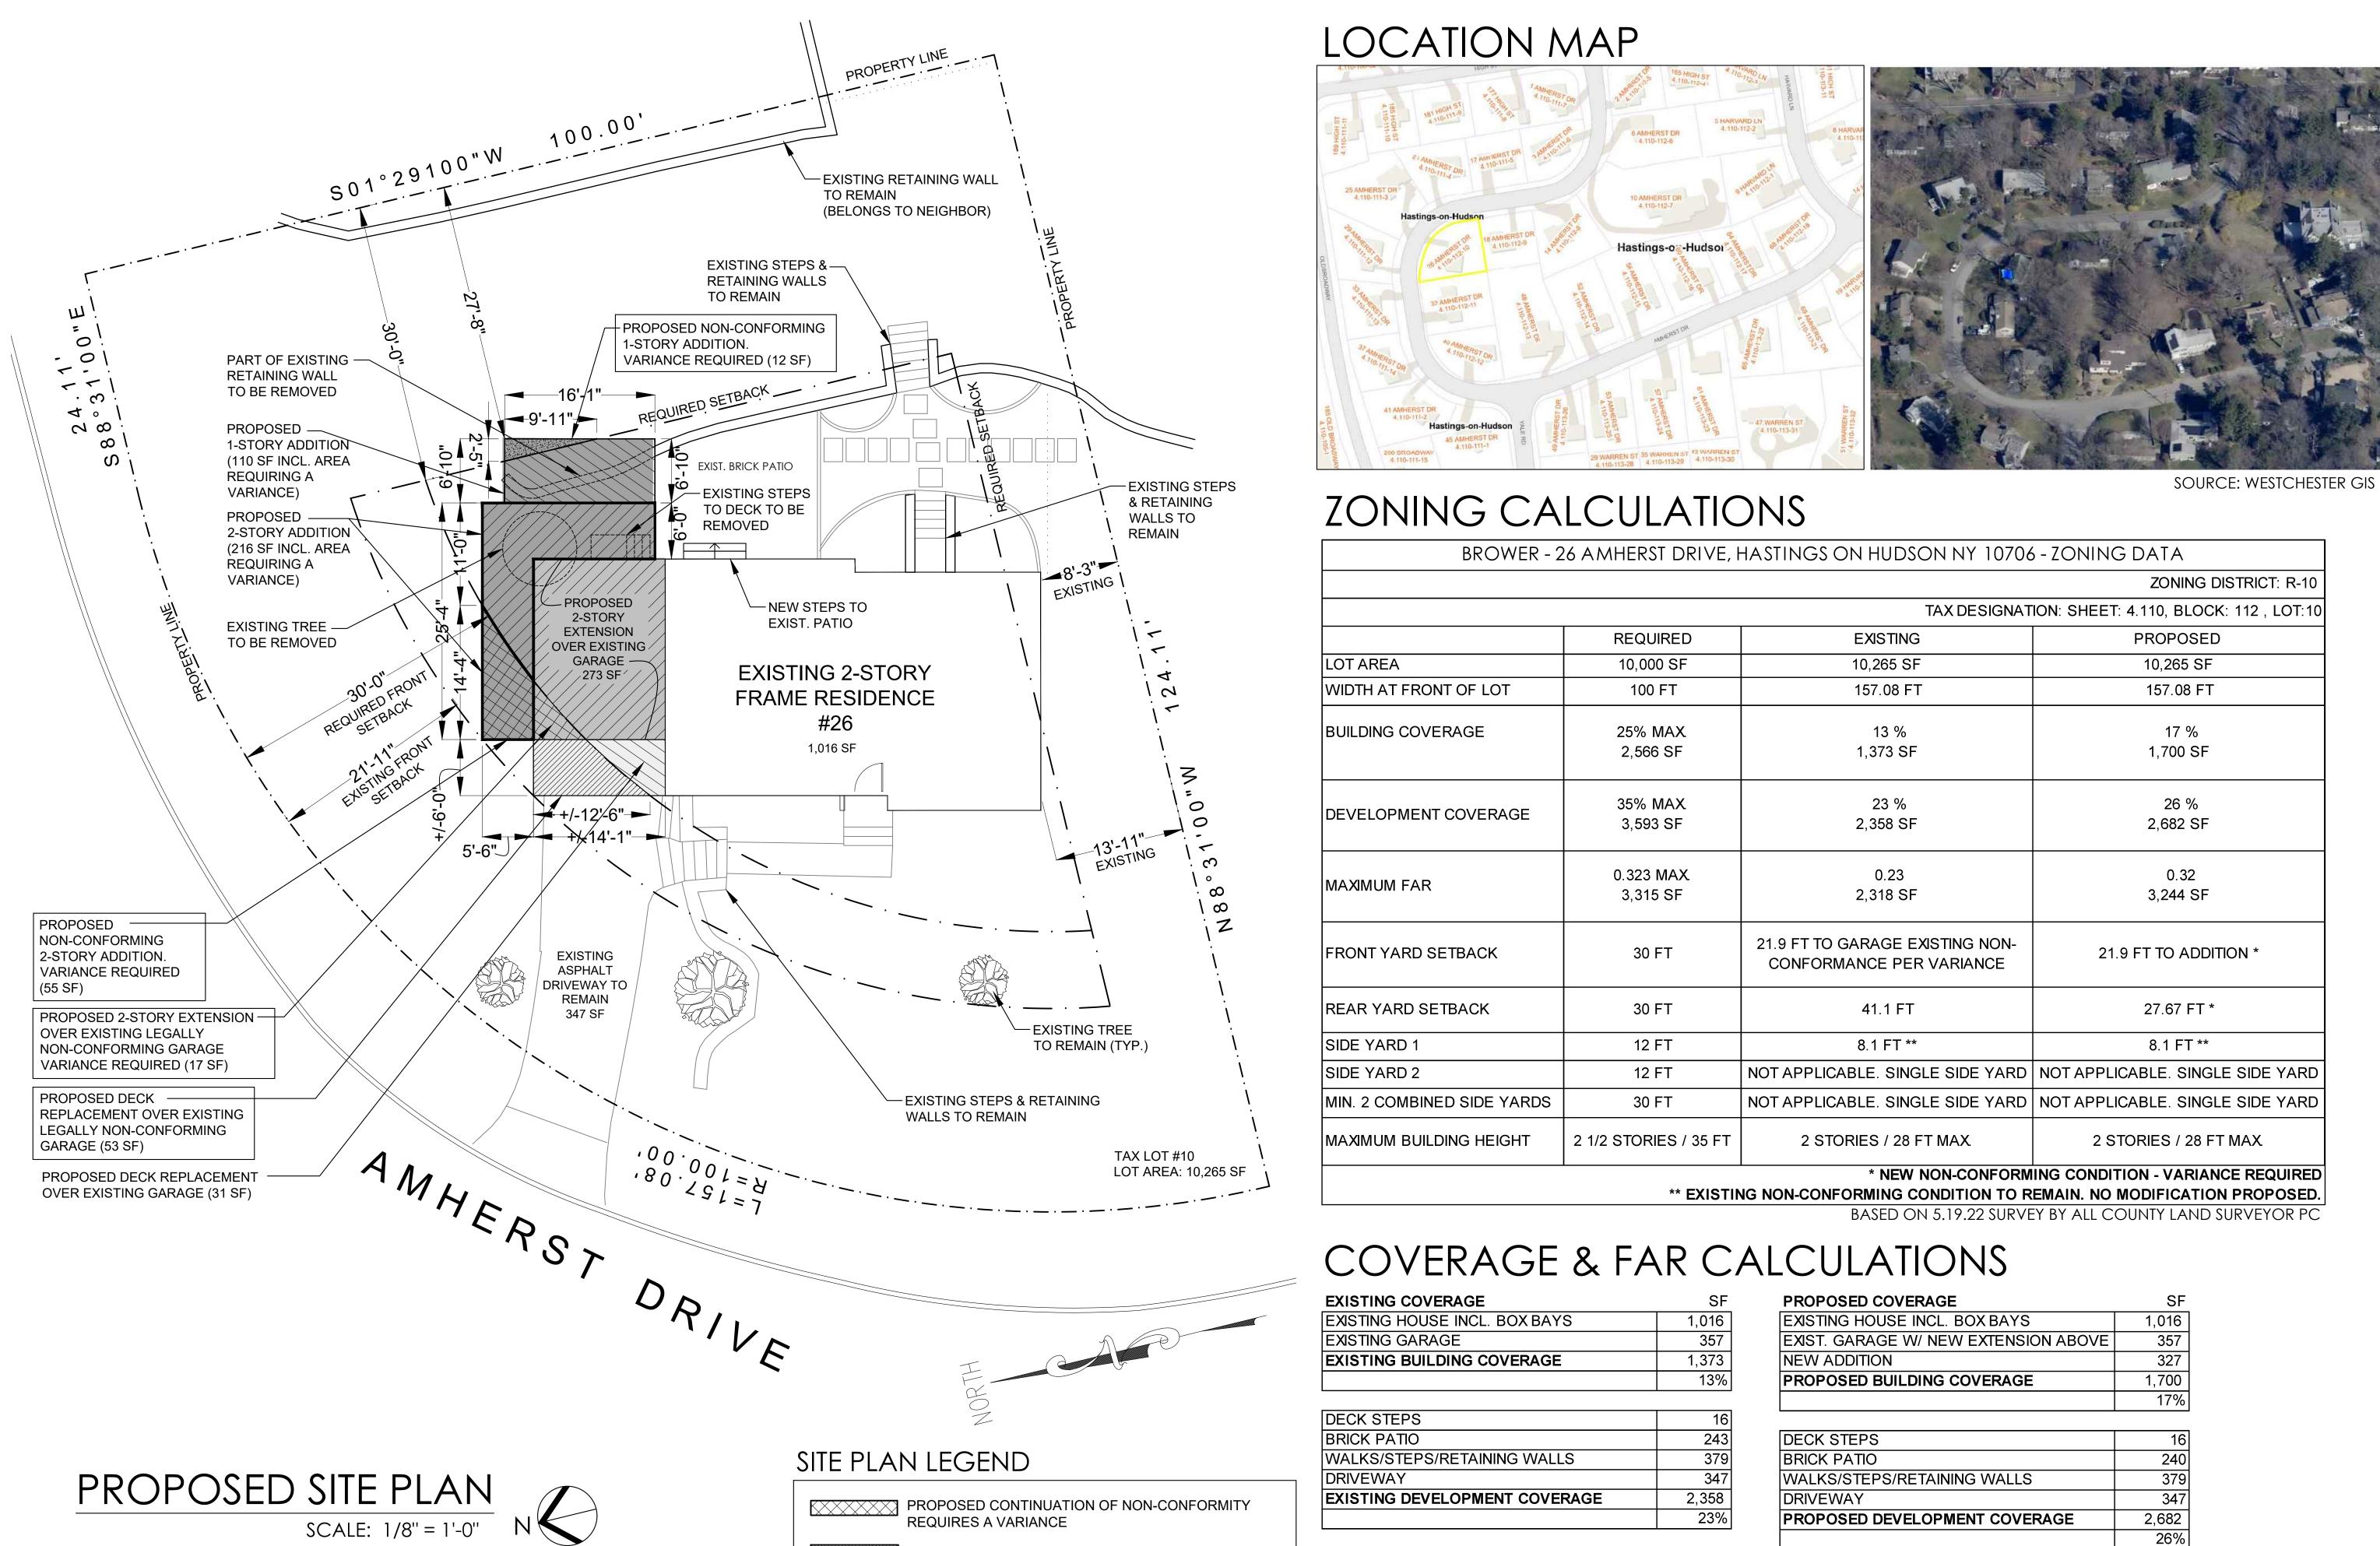

 $\times$ 

PROPOSED CONTINUATION OF NON-CONFORMITY REQUIRES A VARIANCE

- PROPOSED DECK REPLACEMENT ON EXISTING NON-CONFORMING STRUCTURE
- PROPOSED NEW NON-CONFORMITY **REQUIRES A VARIANCE**

PROPOSED CONFORMING CONSTRUCTION

	•	hastings on hudson ny 10708	
			ZONING DISTRICT: R-10
		TAX DESIGNAT	ION: SHEET: 4.110, BLOCK: 112 , LOT:10
	REQUIRED	EXISTING	PROPOSED
LOT AREA	10,000 SF	10,265 SF	10,265 SF
WIDTH AT FRONT OF LOT	100 FT	157.08 FT	157.08 FT
BUILDING COVERAGE	25% MAX 2,566 SF	13 % 1,373 SF	17 % 1,700 SF
DEVELOPMENT COVERAGE	35% MAX 3,593 SF	23 % 2,358 SF	26 % 2,682 SF
MAXIMUM FAR	0.323 MAX 3,315 SF	0.23 2,318 SF	0.32 3,244 SF
FRONT YARD SETBACK	30 FT	21.9 FT TO GARAGE EXISTING NON- CONFORMANCE PER VARIANCE	21.9 FT TO ADDITION *
REAR YARD SETBACK	30 FT	41.1 FT	27.67 FT *
SIDE YARD 1	12 FT	8.1 FT **	8.1 FT **
SIDE YARD 2	12 FT	NOT APPLICABLE. SINGLE SIDE YARD	NOT APPLICABLE. SINGLE SIDE YARD
MIN. 2 COMBINED SIDE YARDS	30 FT	NOT APPLICABLE. SINGLE SIDE YARD	NOT APPLICABLE. SINGLE SIDE YARD
MAXIMUM BUILDING HEIGHT	2 1/2 STORIES / 35 FT	2 STORIES / 28 FT MAX	2 STORIES / 28 FT MAX

EXISTING COVERAGE	
EXISTING HOUSE INCL. BOX BAYS	1,0
EXISTING GARAGE	
EXISTING BUILDING COVERAGE	1,:

	2
EXISTING DEVELOPMENT COVERAGE	2,3
DRIVEWAY	3
WALKS/STEPS/RETAINING WALLS	3
BRICK PATIO	
DECK STEPS	

EXISTING FAR	SF
GARAGE, BASEMENT & LOWER LEVEL	1,093
MAIN & MIDDLE LEVEL	1,016
UPPER LEVEL	209
TOTAL EXISTING FLOOR AREA	2,318
	0.23

PROPOSED COVERAGE	SF
EXISTING HOUSE INCL. BOX BAYS	1,016
EXIST. GARAGE W/ NEW EXTENSION ABOVE	357
NEW ADDITION	327
PROPOSED BUILDING COVERAGE	1,700
	17%

DECK STEPS	16
BRICK PATIO	240
WALKS/STEPS/RETAINING WALLS	379
DRIVEWAY	347
PROPOSED DEVELOPMENT COVERAGE	2,682
	26%

PROPOSED FAR	SF
GARAGE, BASEMENT & LOWER LEVEL	1,093
EXISTING MAIN & MIDDLE LEVEL	1,016
MAIN LEVEL ADDITION	599
EXISTING UPPER LEVEL	209
UPPER LEVEL ADDITION	327
TOTAL PROPOSED FLOOR AREA	3,244
	0.32



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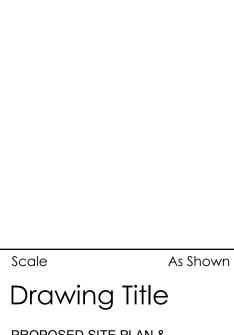
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PROPOSED SITE PLAN & ZONING DATA

Sheet Number

**J**-



PHOTOS OF EXISTING CONDITIONS AT 26 AMHERST DRIVE SCALE: NTS





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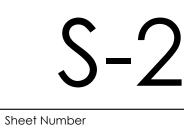
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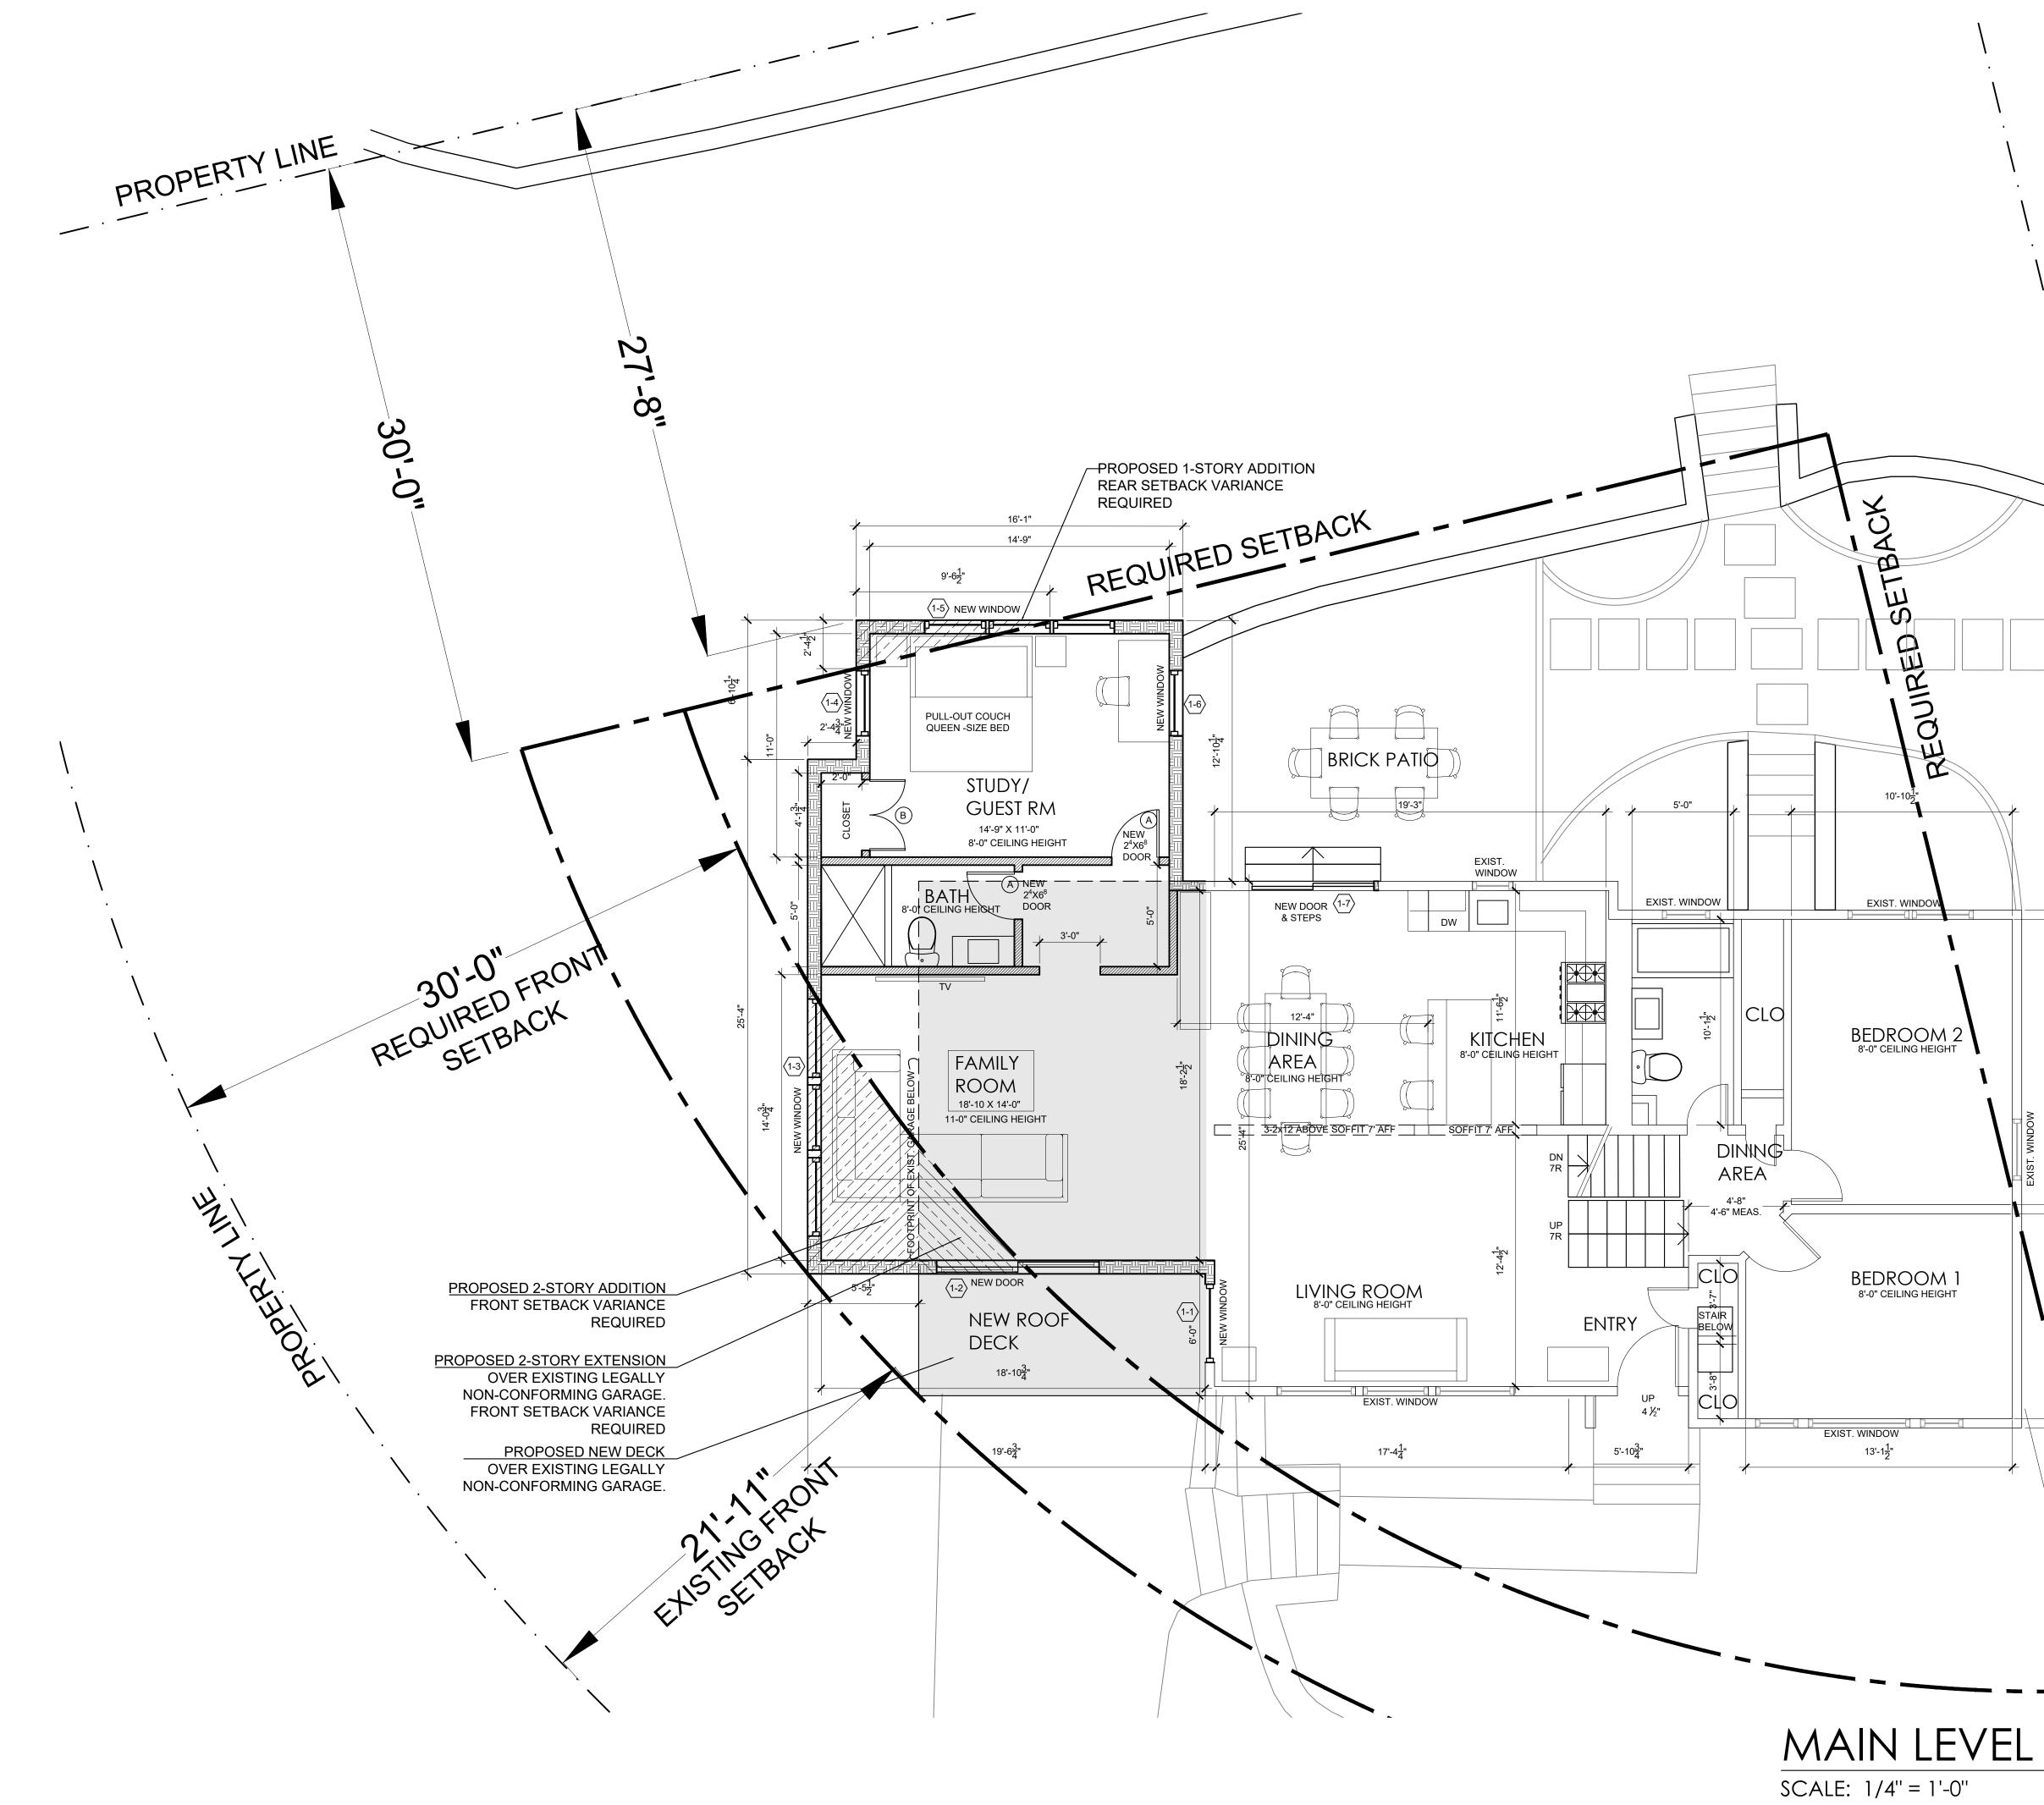
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Drawing Title AERIAL MAP, PHOTOS OF NEIGHBORING PROPERTIES & PHOTOS OF EXISTING CONDITIONS

Scale


As Shown





## LEGEND EXISTING TO BE DEMOLISHED \_ELEVATION EXISTING TO REMAIN NO. ELEVATION SHEET NO. INTERIOR WALL: 5/8" gypsum board ea. side of 2 x 4s @ 16" o.c. INTERIOR WALL WITH KKKKKK ELEVATION ACOUSTICAL INSULATION: SECTION DETAIL 5/8" gypsum board each ARCHITECTS side of 2 x 4s @ 16" o.c., - SHEET NO. Blue Jeans acoustical insul. 3/4" HOUR FIRE RATED WALL: 5/8" fire code gypsum board on 12 SPRING STREET XX DOOR TYPE, FOR DESCRIPTION, outer side of 2x4s @ 16" o.c. HASTINGS.on.HUDSON SEE SPECIFICATIONS -EXTERIOR WALL: Hardieplank siding, house wrap, DOOR SCHEDULE N.Y. 10706 5/8 " Advantech engineered panel, WINDOW TYPE, 2x6 studs 16" o.c., R-21 batt insulation 914.478.0799 $\langle \times \times \rangle$ FOR DESCRIPTION, 5/8" gypsum board SEE SPECIFICATIONS cg@cgastudio.com WINDOW SCHEDULE FOUNDATION WALL: christinagriffinarchitect.com 10" reinforced masonry block wall, stucco finish above grade, troweled on waterproofing below grade CONSTRUCTION REQUIRING 0706 出 A VARIANCE — Z Ο **IN** S Ζ $\sim$ SIO I ₽ 7 PERT ZШ Z $\sim$ RO × STIN n\_ $\mathbf{\mathcal{L}}$ $\propto$ S Ζ Ш DRIV C Ē HERST RENO BRO 26 AMHE 2<mark>1</mark>-Project Submitted BP & ZBA SUBMISSION 1-30-23 12'-0" ' \_13'-11" As Shown Scale Drawing Title PROPOSED FLOOR PLAN MAIN LEVEL FLOOR PLAN A-1 MID LEVEL SHOWN. NO WORK ON MID. LEVEL

Sheet Number

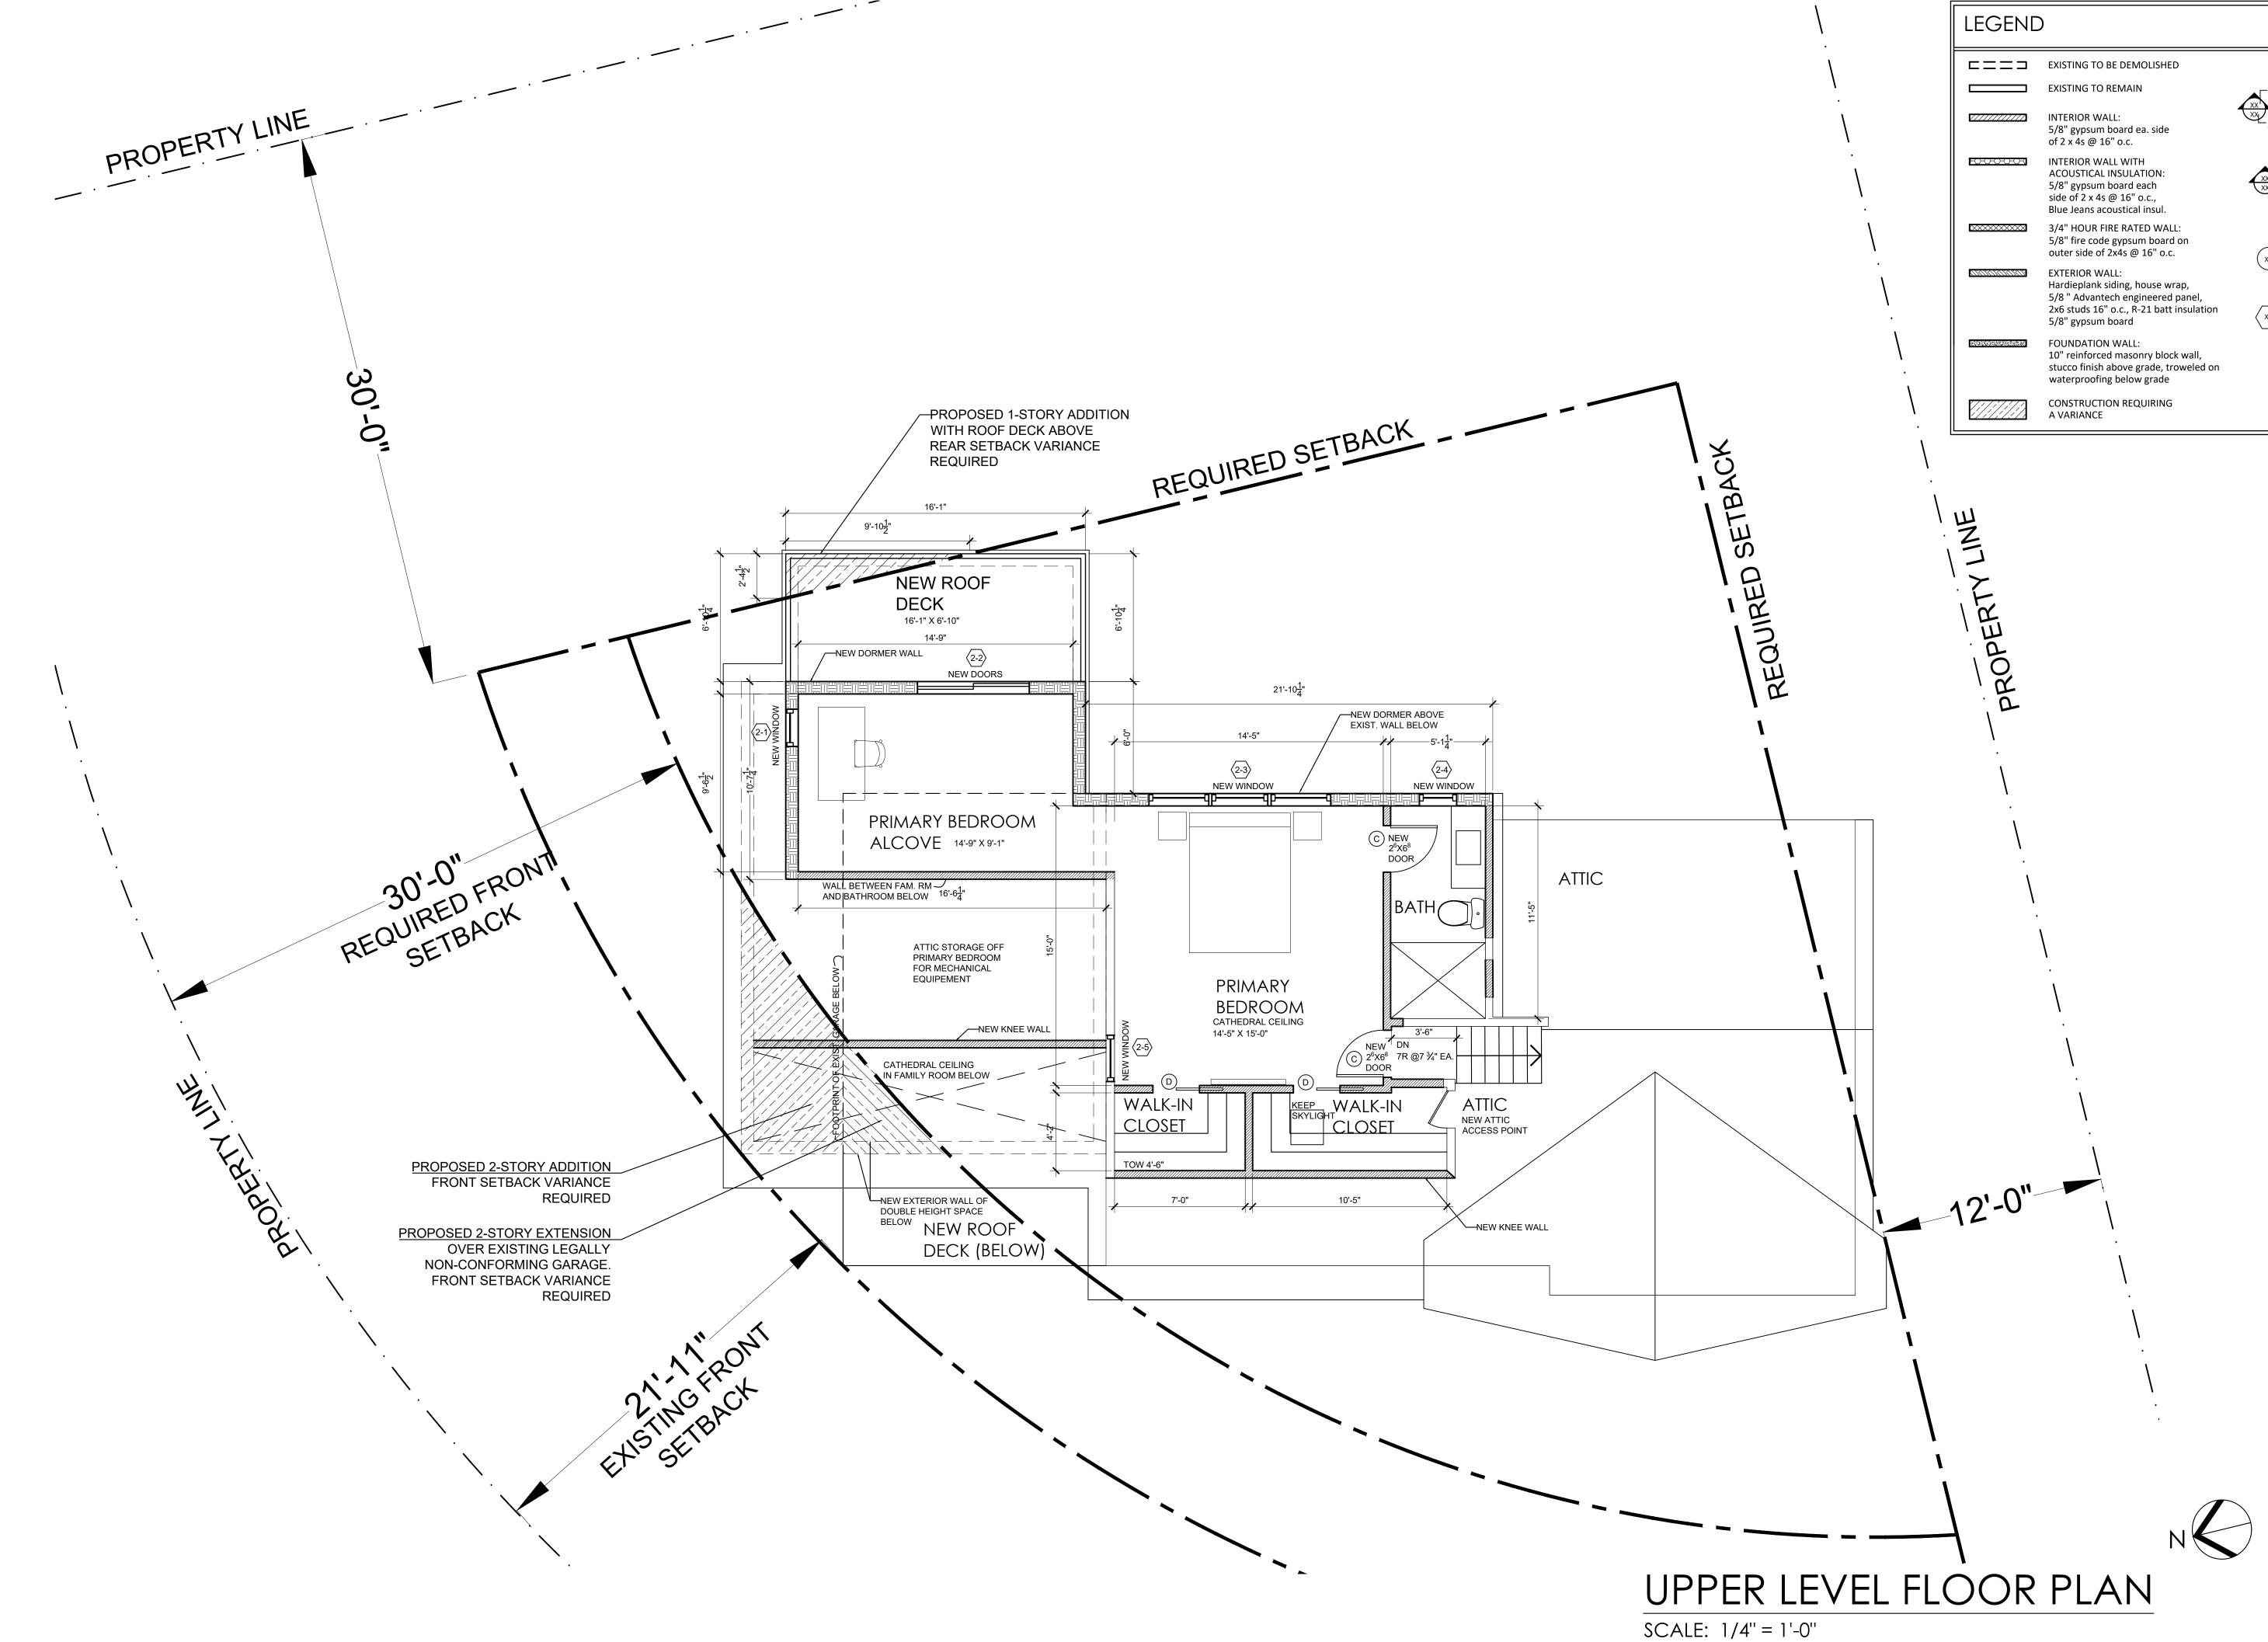

# LEGEND \_ELEVATION NO. SHEET NO. ELEVATION SECTION DETAIL - SHEET NO. XX DOOR TYPE, FOR DESCRIPTION, SEE SPECIFICATIONS -DOOR SCHEDULE WINDOW TYPE, $\langle \times \times \rangle$ FOR DESCRIPTION, SEE SPECIFICATIONS -WINDOW SCHEDULE



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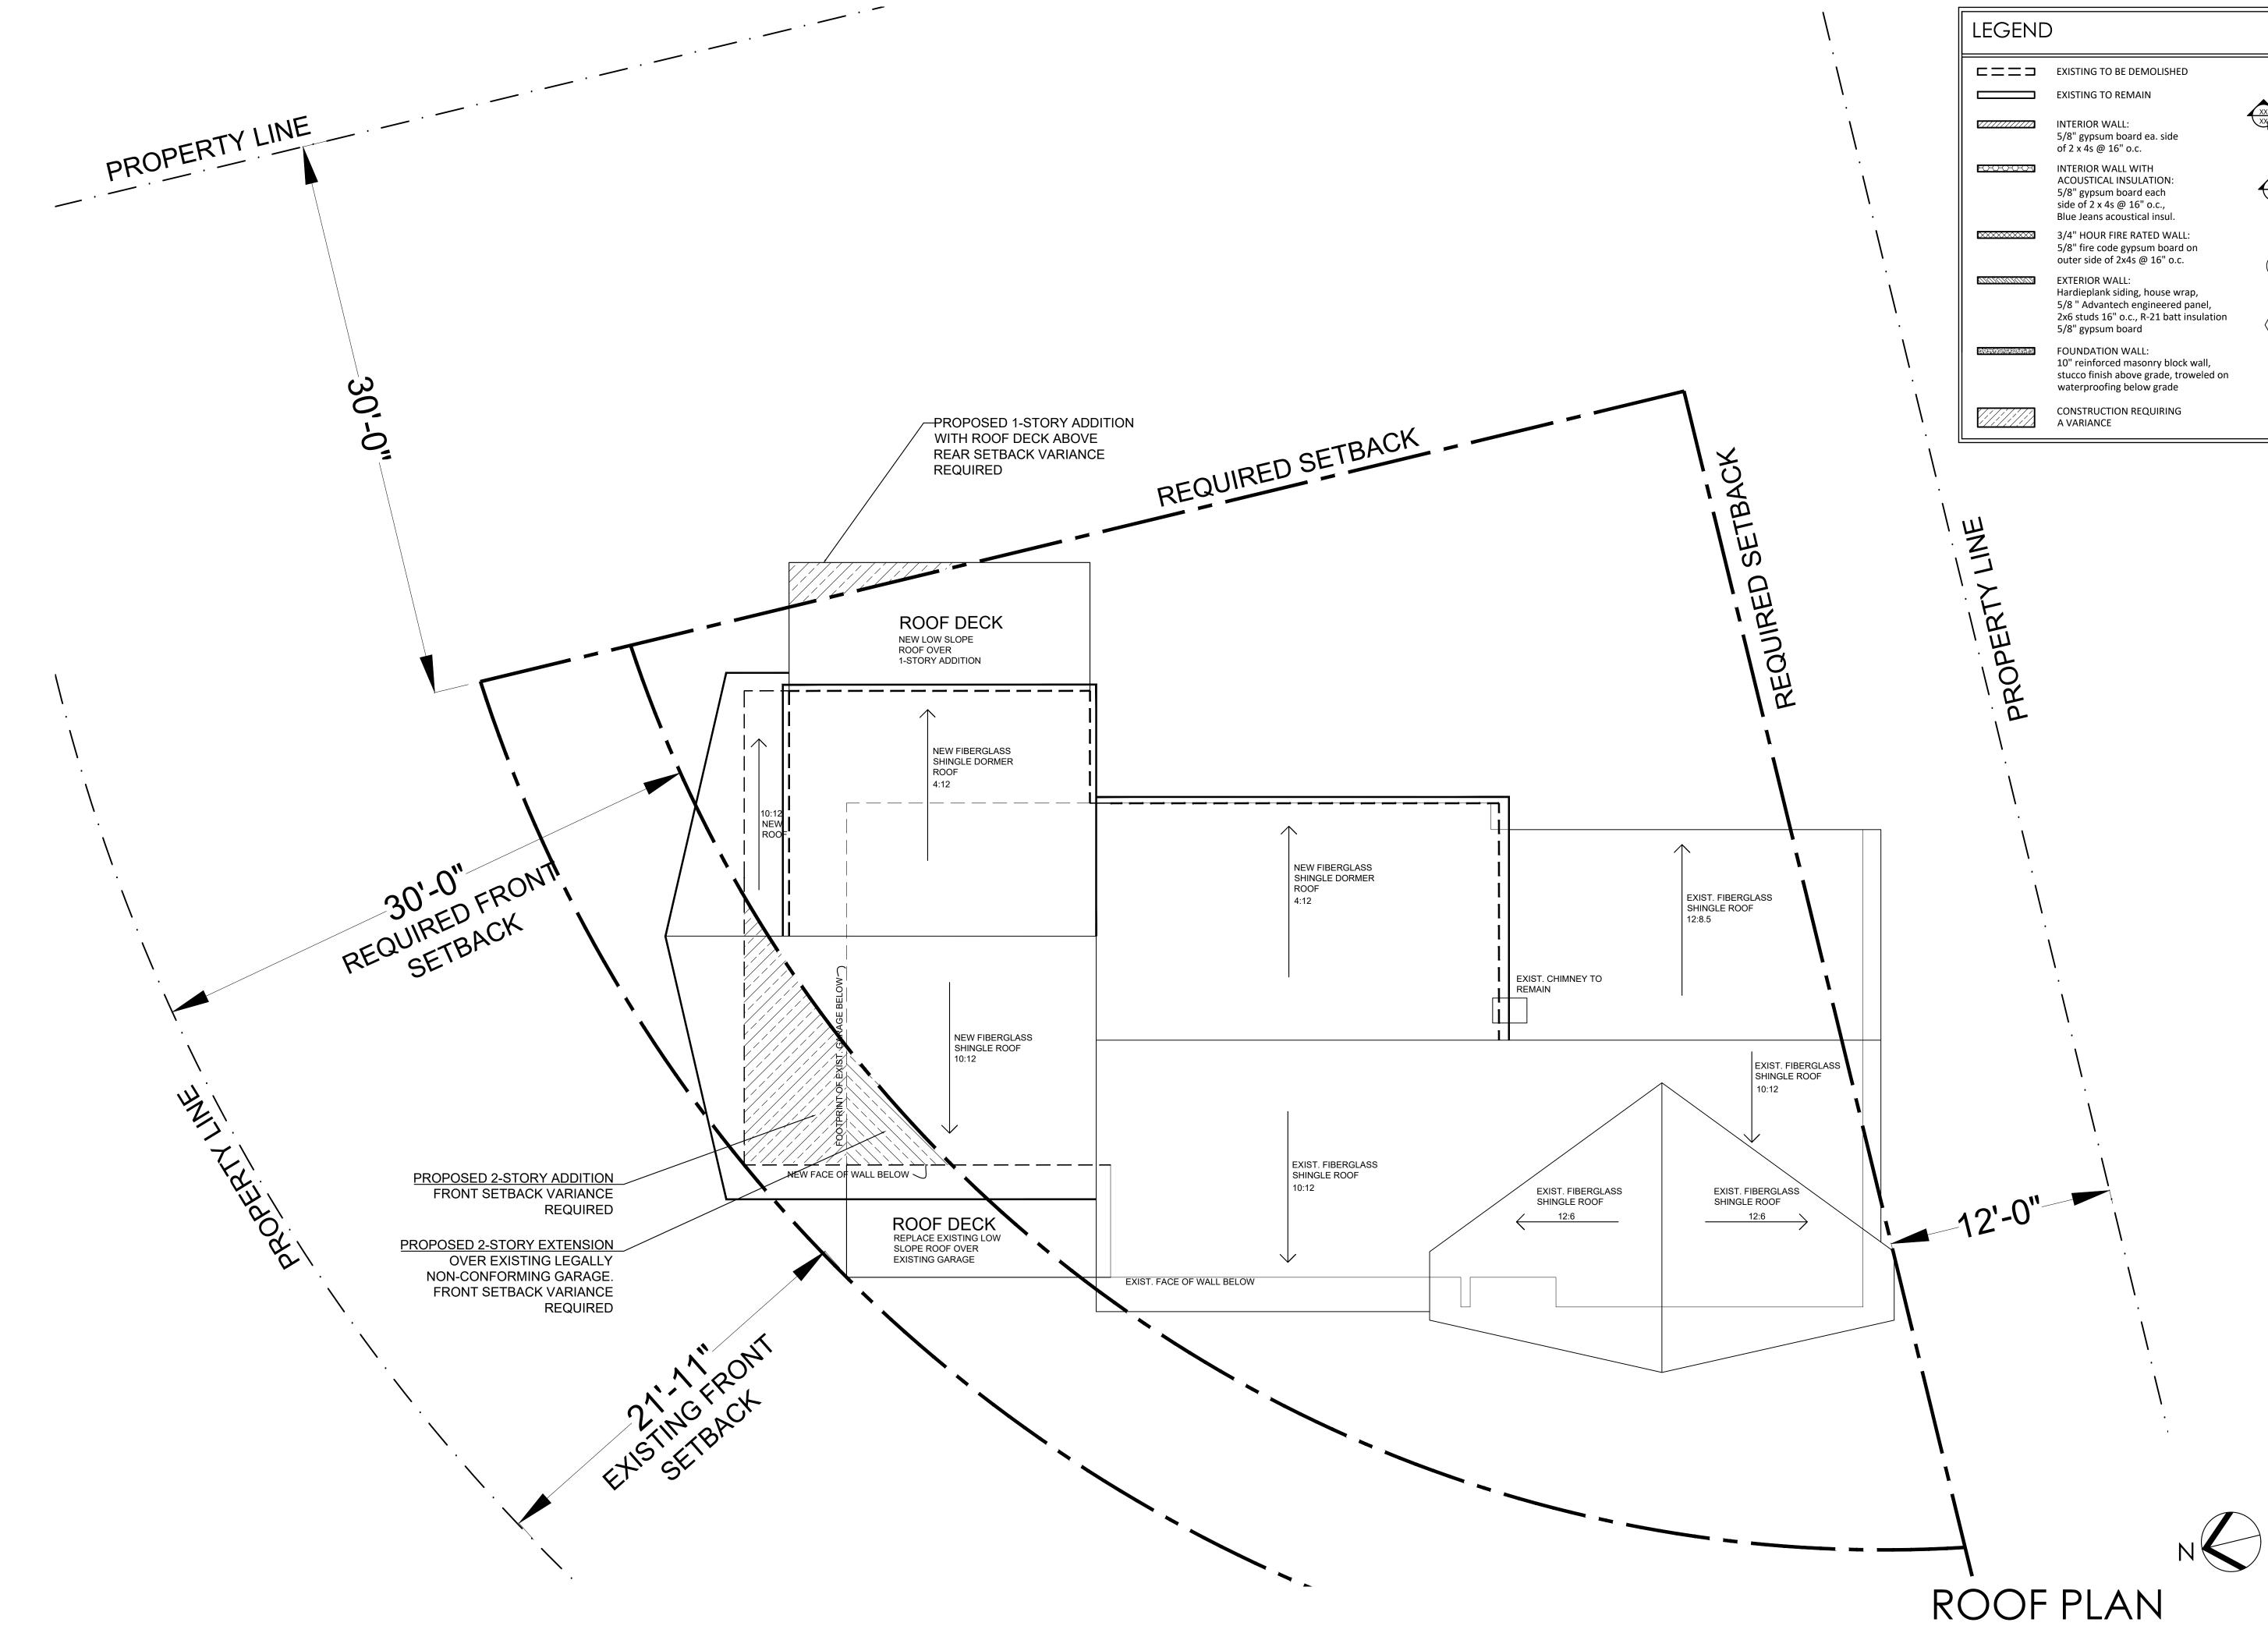
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Project Submitted

BP & ZBA SUBMISSION 1-30-23

As Shown Scale Drawing Title PROPOSED FLOOR PLAN





# LEGEND \_ELEVATION NO. SHEET NO. ELEVATION SECTION DETAIL - SHEET NO. XX DOOR TYPE, FOR DESCRIPTION, SEE SPECIFICATIONS -DOOR SCHEDULE WINDOW TYPE, $\langle \times \times \rangle$ FOR DESCRIPTION, SEE SPECIFICATIONS -WINDOW SCHEDULE

SCALE: 1/4" = 1'-0"




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As Shown Scale Drawing Title PROPOSED ROOF PLAN








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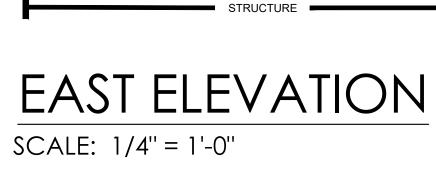


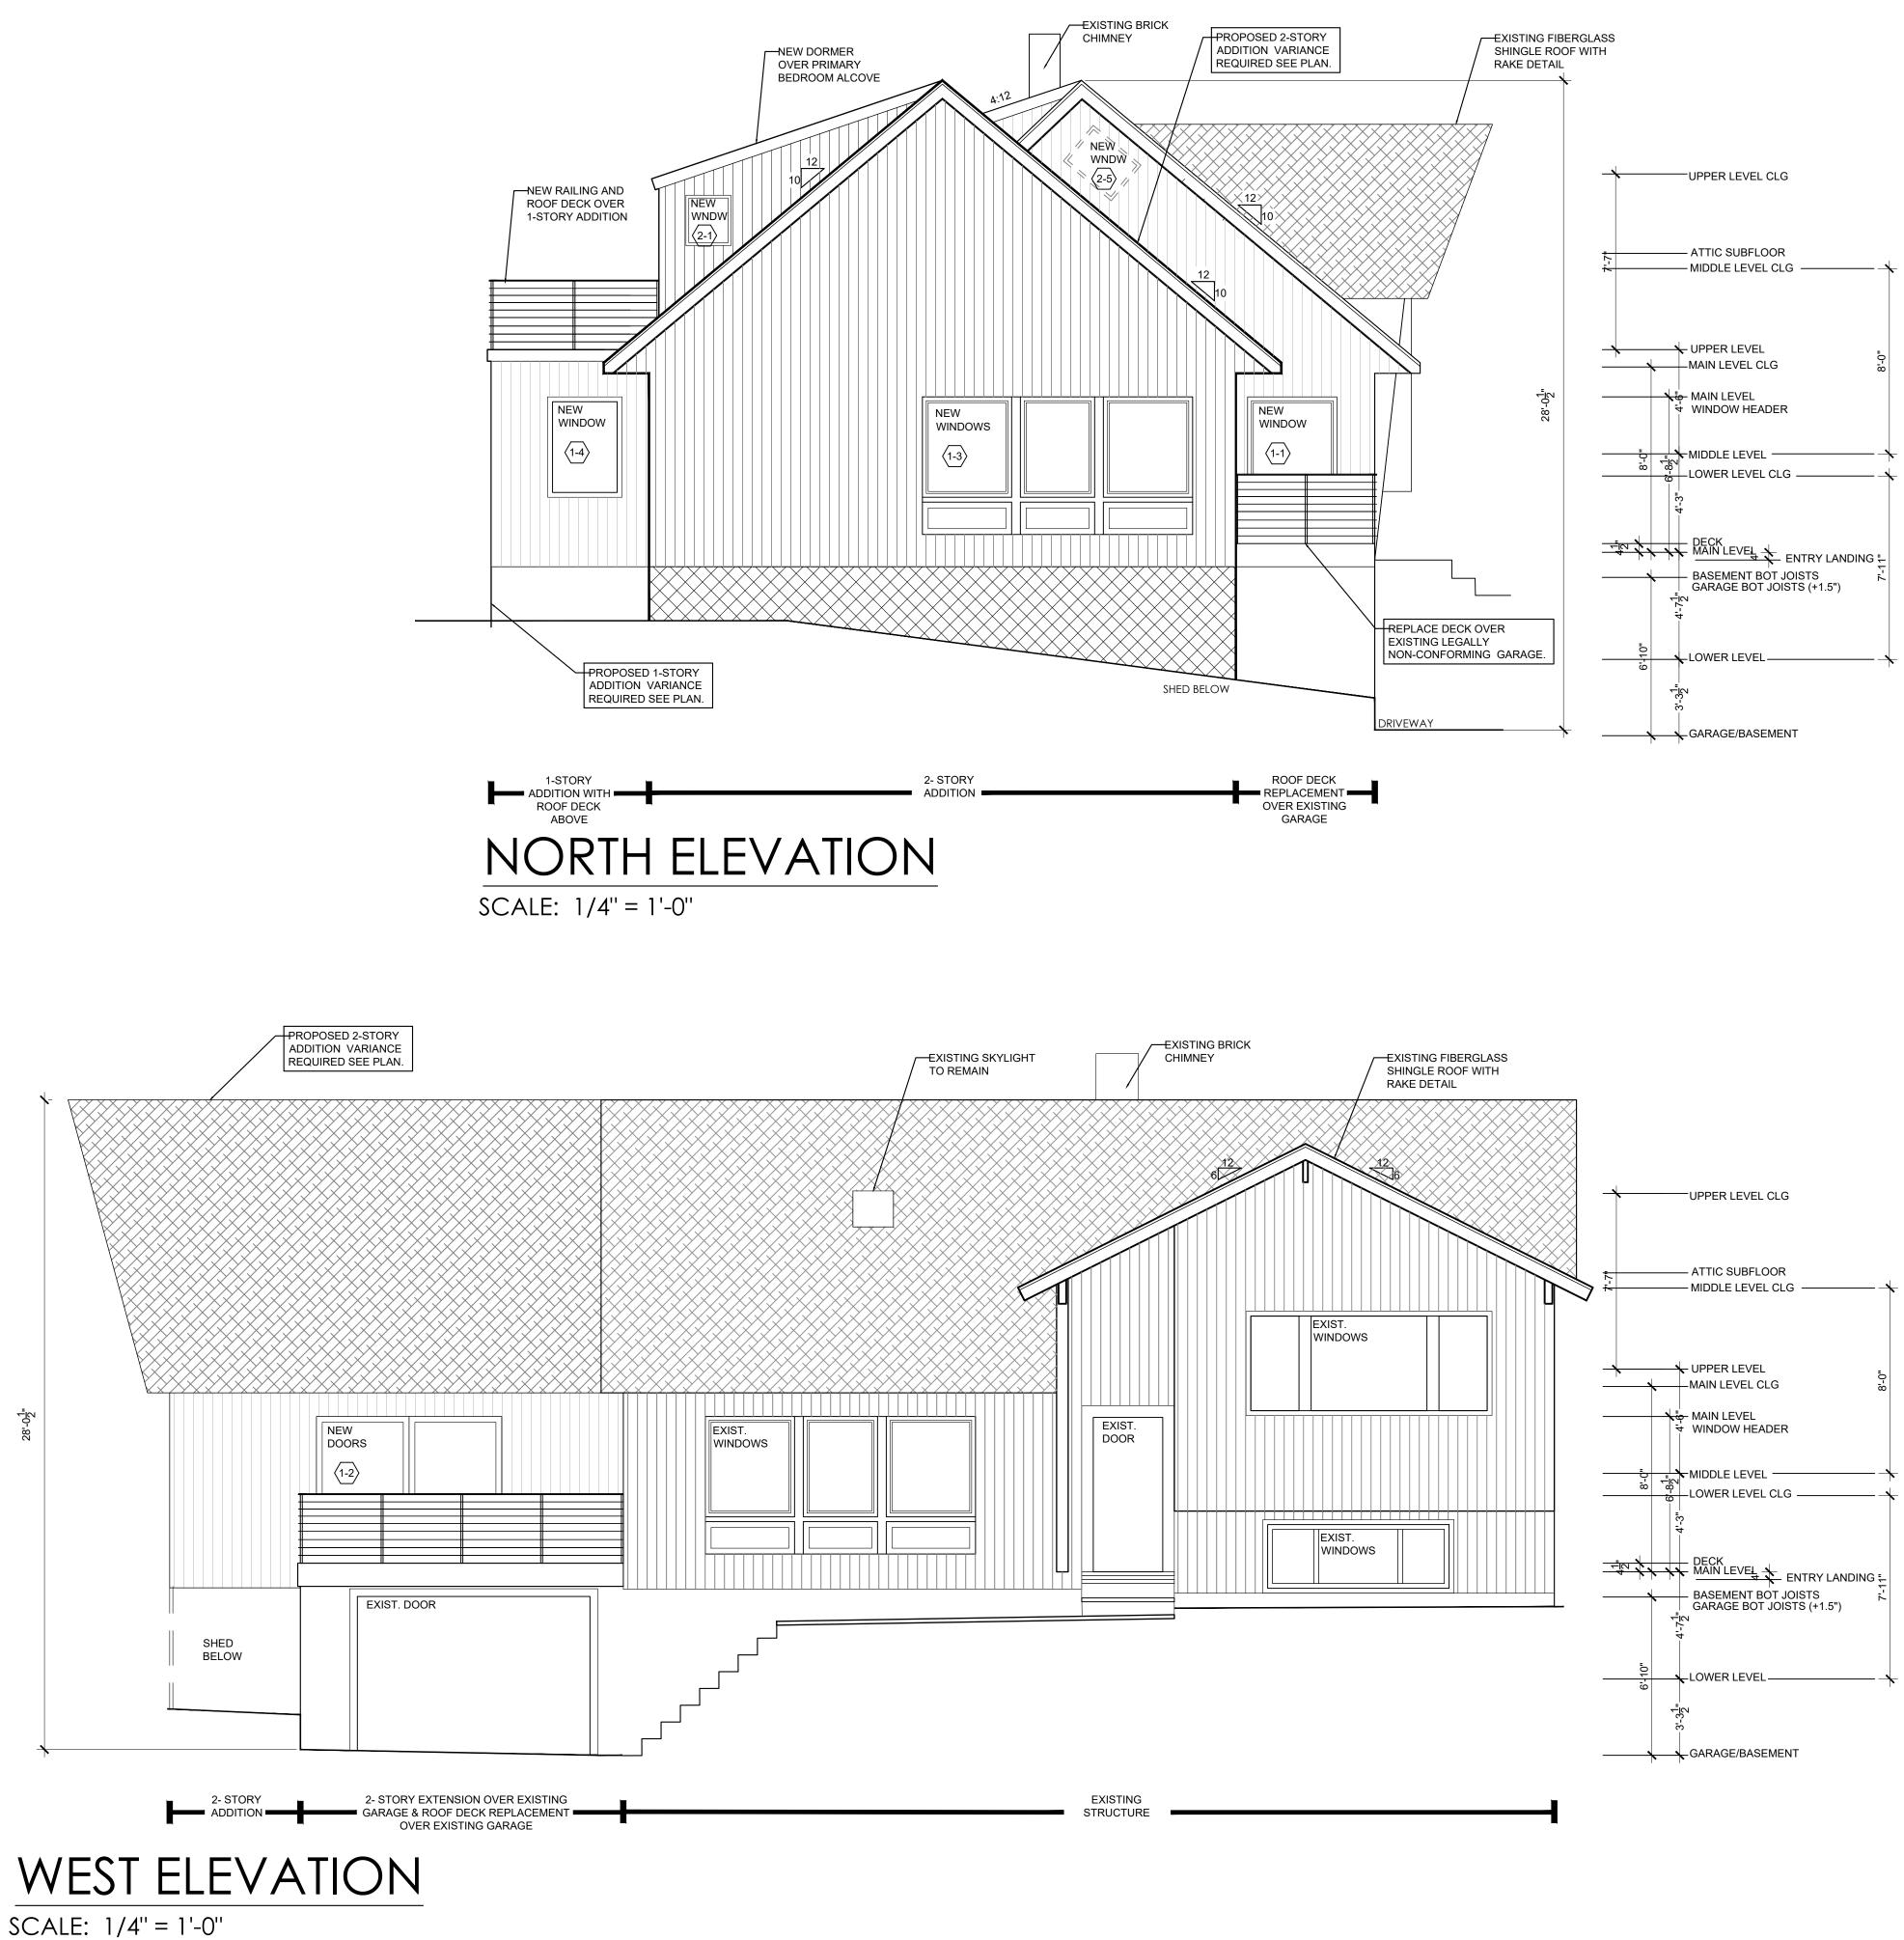
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As Shown Scale Drawing Title PROPOSED ELEVATIONS







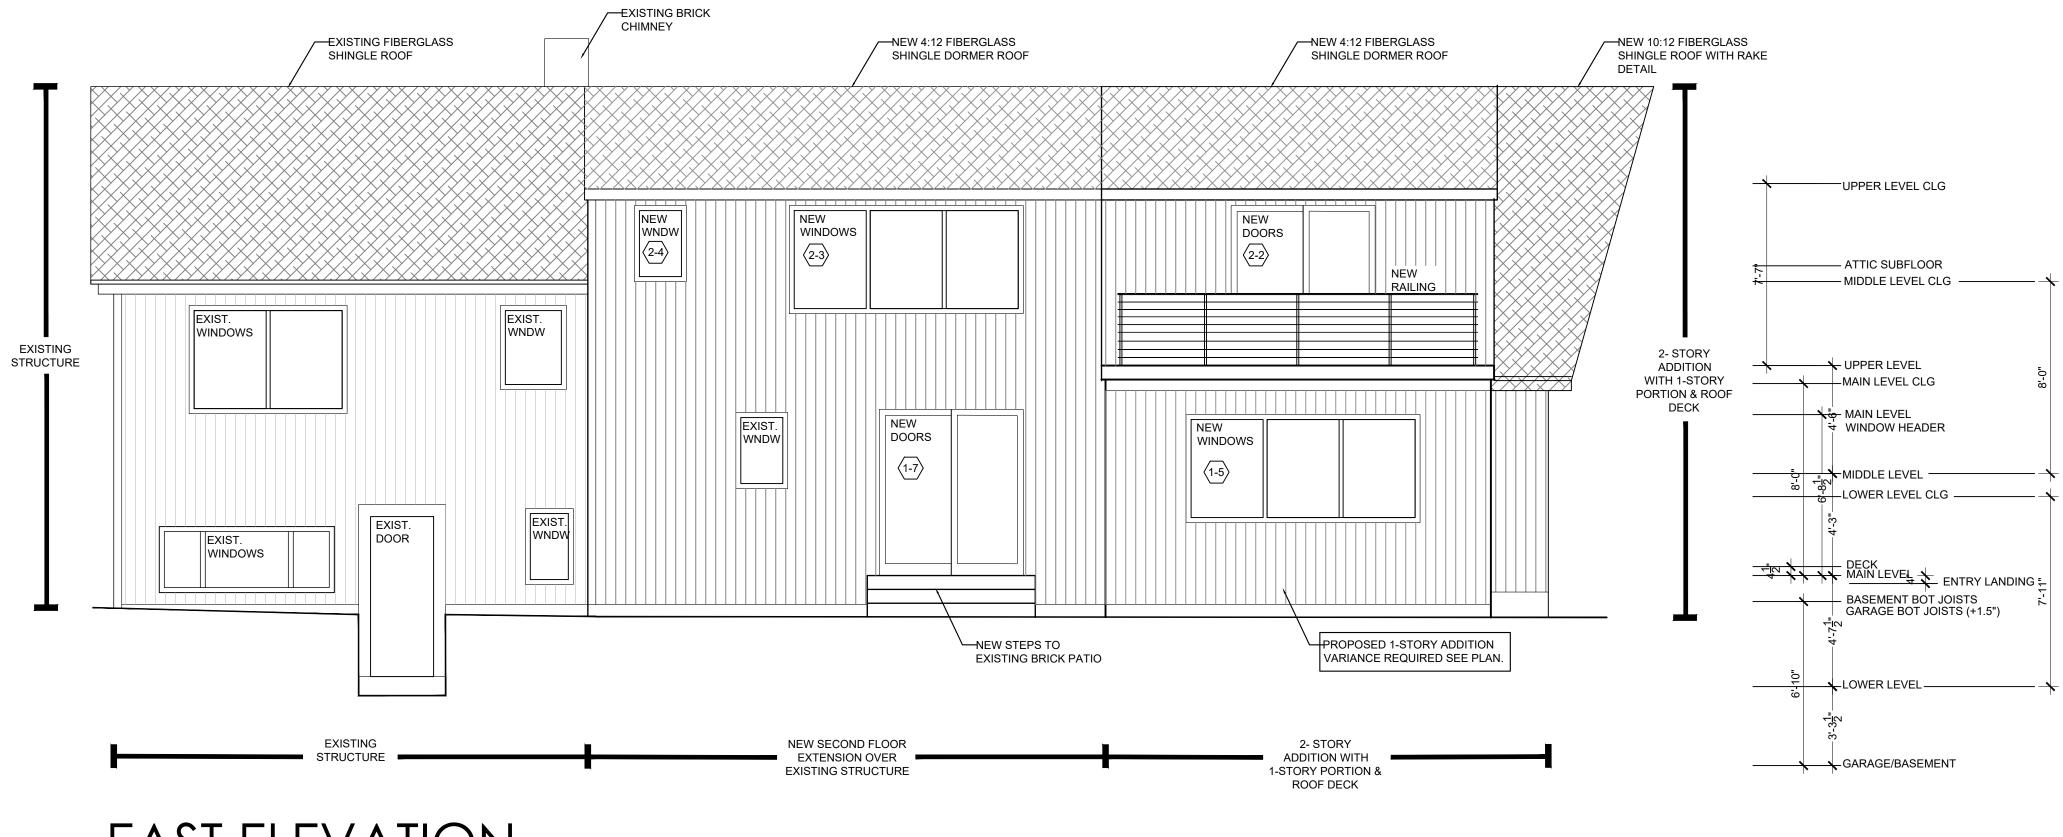

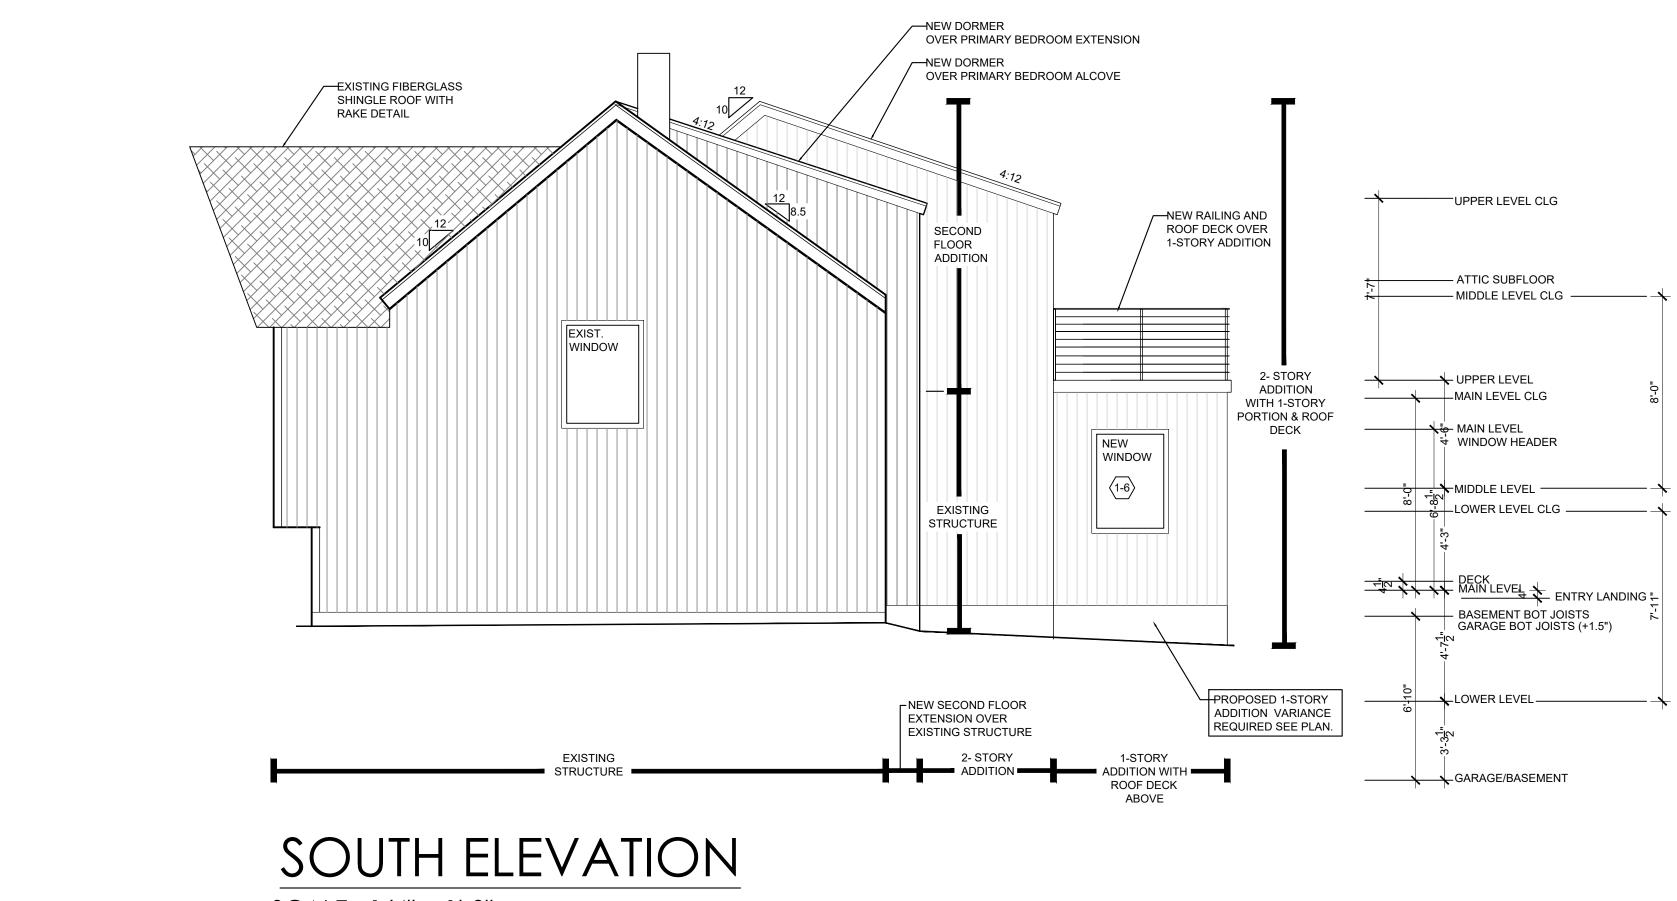SCALE: 1/4" = 1'-0"




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As Shown Scale Drawing Title PROPOSED ELEVATIONS







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Scale As Shown
Drawing Title
DEMOLITION FLOOR PLANS

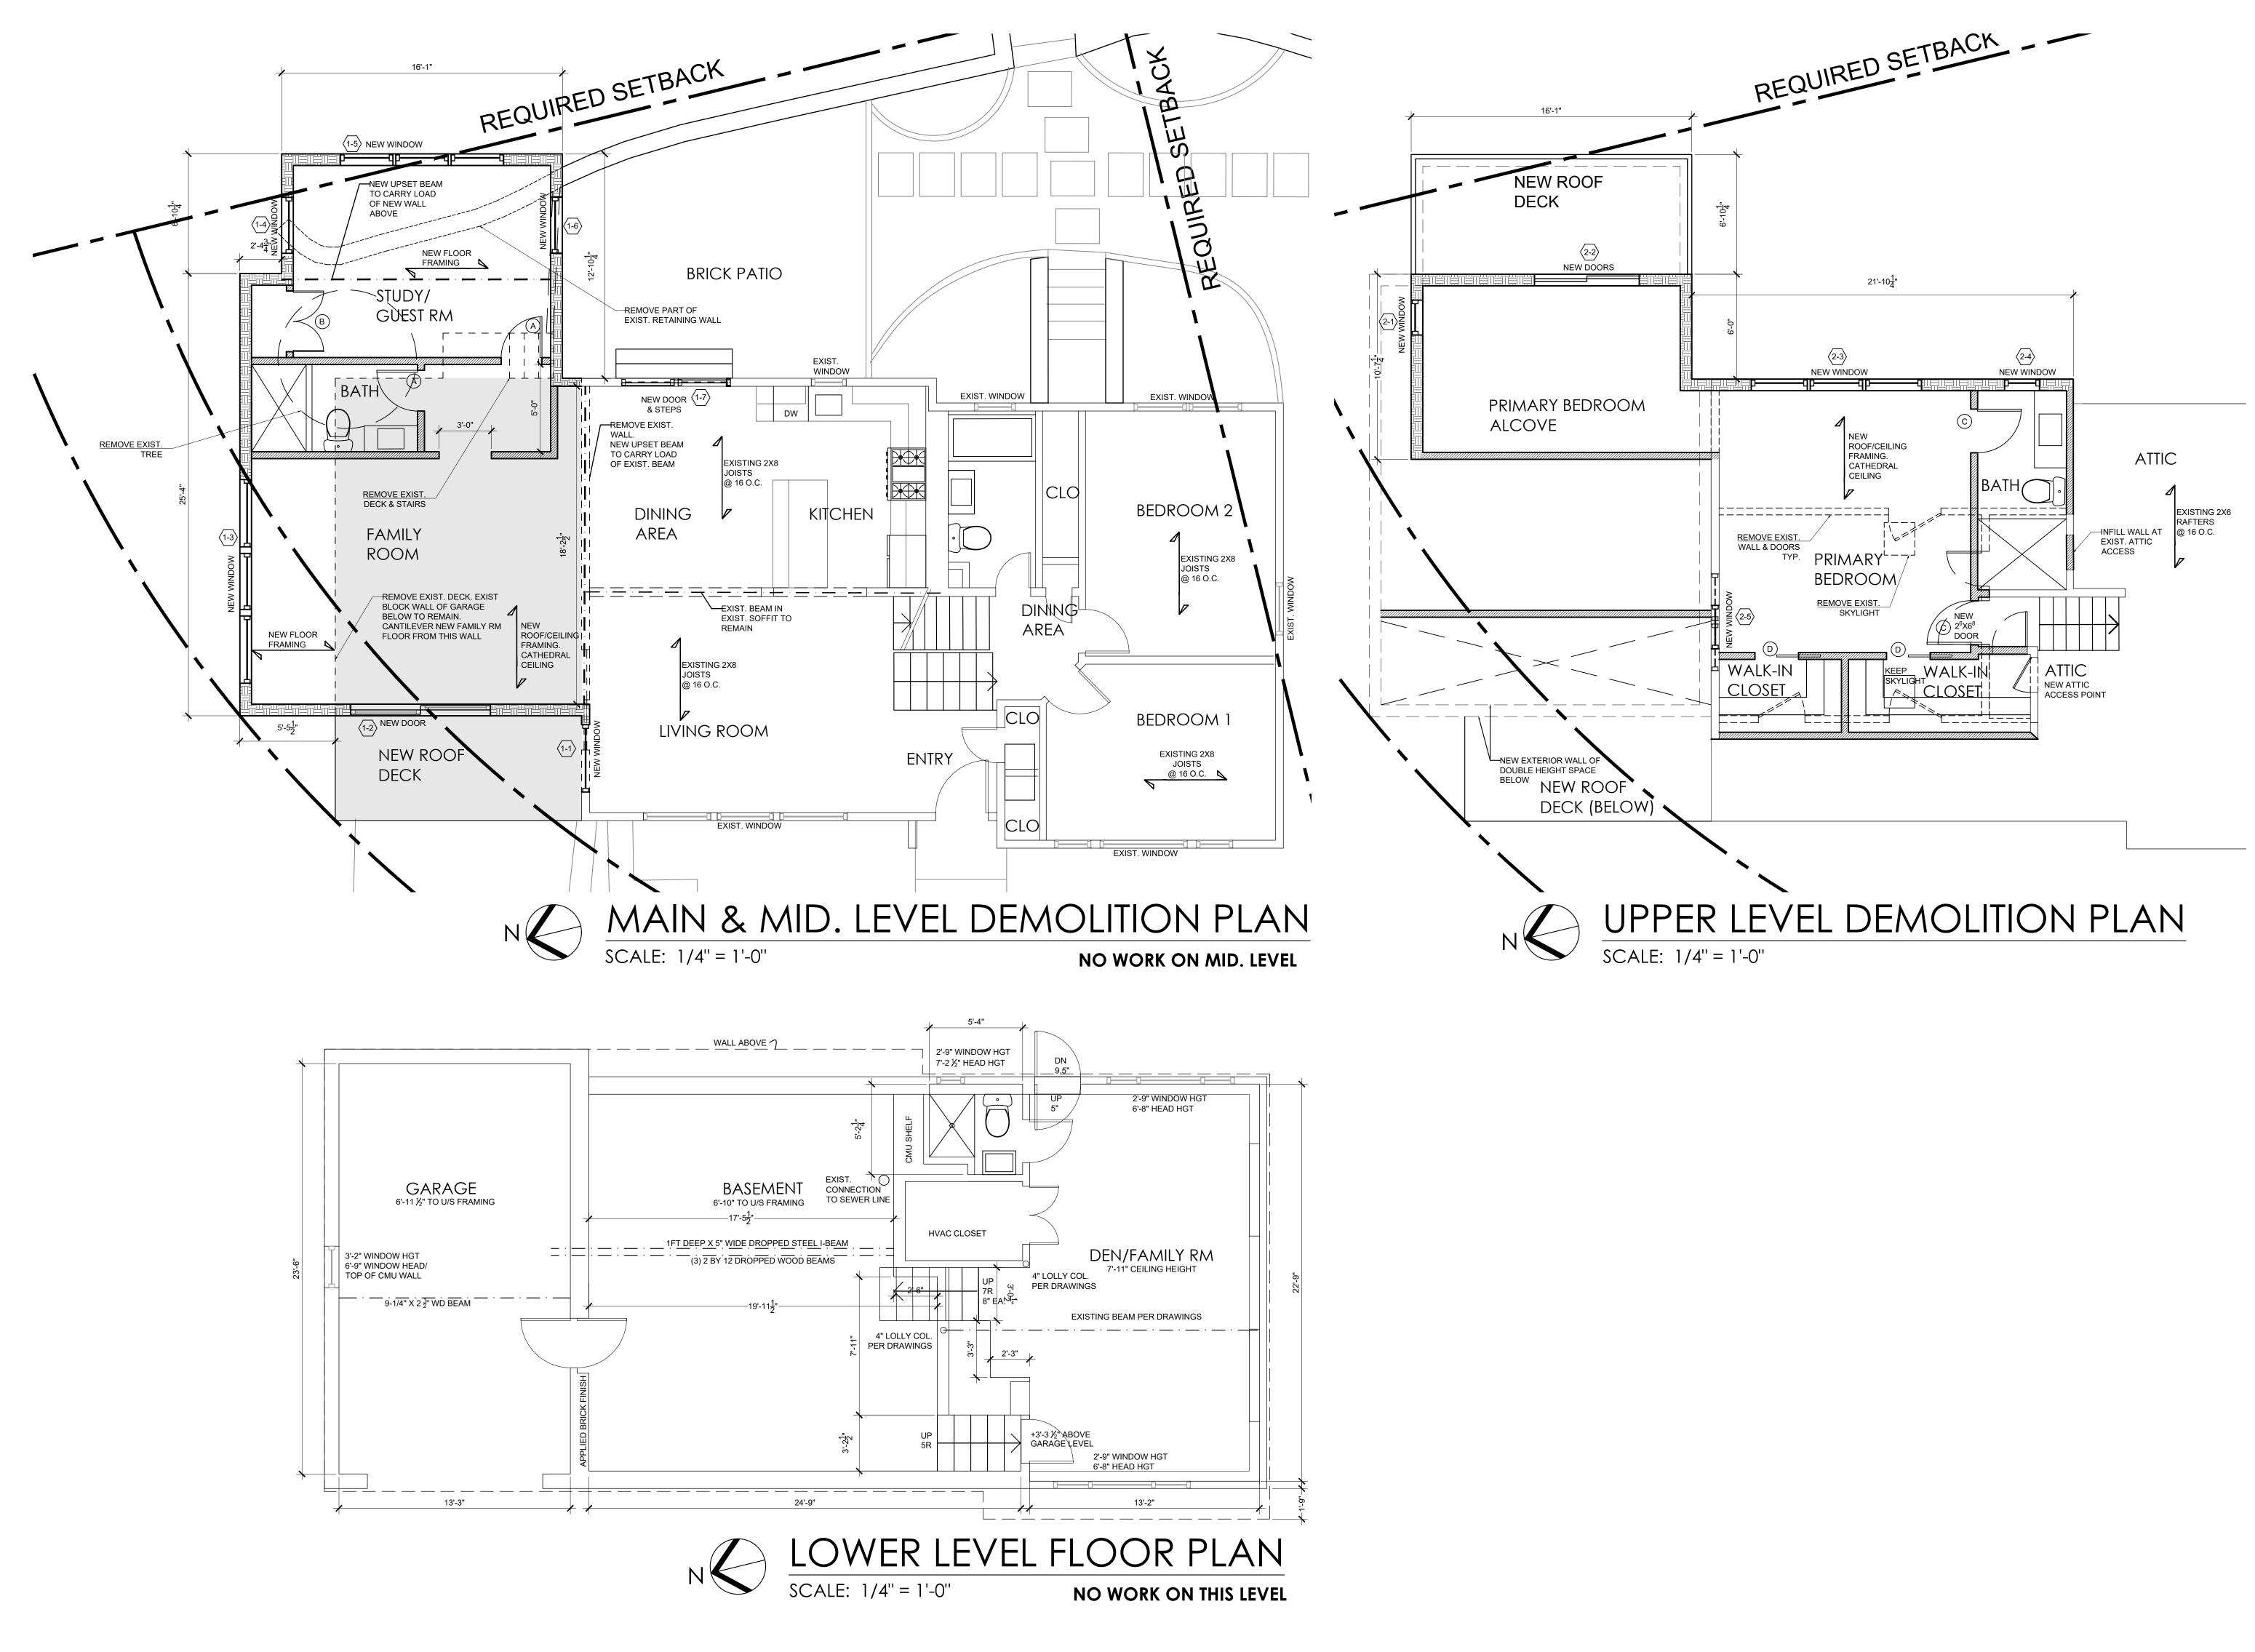