VILLAGE OF HASTINGS-ON-HUDSON

Zoning Board of Appeals
Application and Procedure for Application for
Variance/Interpretation/View Preservation



Case number:	Case number: Date of application: DECEMBER 19, 2019							
Property add	ress: 0 PINECREST PARK	WAY	R. HANAUER, EXECUTOR					
	ts on which the property is loca							
Standing of ap	THAM DESIGN AND CON oplicant if not owner: AGENT BROADWAY, DOBBS FE	FOR OWNER	VT					
1 '	e number: 914-693-5093 . arch329@gmail.com		593-5390					
ZBA action req	uested for (See §295-146B & C:	Use Variance/s; Interpretation;	Area Variance/s; View Preservation (See §295-82)					
List code section	ons & provisions from which the	e variance or interpretation is	requested:					
Section'	Code Provision*	Existing Condition*	Proposed Condition*					
295.68.F.Z.9.2	DEVELOPMENT COVERAGE	35% (4,920 Seff. Max)	4271% (6,012 50 Fr.) 39.99%					
295-82								
*See example	below:							
295-68F.1a	Front Yard Min. 30 ft. deep		19.5 ft					

VILLAGE OF HASTINGS-ON-HUDSON

Zoning Board of Appeals Zoning Analysis



ZONING REQUIREMENTS:

YARD	SETBACKS
(Princip	oal Structure)

	REQUIRED	EXISTING	PROPOSED
FRONT	30 FT.	Aln	30 Fr.
REAR	30 FT.	N/A	30 FT.
SIDE ONE	12 Fr.	Alu	32.3 Fr.
SIDE TWO	18 Ft.	N/A	27.3 FT. (To Dea
TOTAL OF TWO SIDES	30 FT.	N/A	59.6 FT.

YARD SETBACKS (Accessory Structure)

REQUIRED E		EXISTING	PROPOSED
TO PRINCIPAL BLDG.		NA	N/A
REAR	8 Ft.	Alu	N/A
SIDE	8 FT.	N /A	N/A

BUILDING HEIGHT

·	PERMITTED	EXISTING	PROPOSED
STORIES	21/2	N/A	21/2
FEET	35 Ft.	N/A	34.97 FT.

LOT COVERAGE

	PERMITTED	EXISTING	PROPOSED
LOT AREA	10,000 Safor	14.057 Sa.FT.	14,057 50.57.
*BLDG. COVERAGE/ % OF LOT AREA	15% (3,514 Se.fr.)	Ala	16.39% (2,304 Sa.Fr.)
*DEVELOPMENT COVERAGE/	35% (4022 6 5)	15.48% (2,176 So. Fr.)	28.12% (3,953 Sa.Fr.) 42.77% (6,012 Sa.Fr.)
% OF LOT AREA			16.11 10 (6,012 X.17.)
*See Definitions of Building and	d Development Coverage in Section 2	95-5 of the Village code.	27.17

OCCUPANCY AND USE

	PERMITTED	EXISTING	PROPOSED
CURRENT USE**	SINGLE FAMILY	VACAUT LAND	SIUGLE FAMILY

^{**} Single Family, Two Family, Commercial, Mixed Use etc.

VILLAGE OF HASTINGS-ON-HUDSON

Zoning Board of Appeals

<u>Application and Procedure for Application for Variance/Interpretation/View Preservation</u>



List any previous application or appeal filed with The Zoning Board of Appeals for this premises:

Date of Appeal	Purpose of the Appeal	Resolution if any	Date of Action
List pending violation	ons on this property if any:		
· Is there an approve	d site plan for this property?:	(Yes)	(No)
Is there an Accesso	ry Apartment at this property?:	(Yes)	(No)
· Does this property h	nave Boarder's Permit?:	(Yes)	(No)
application. Describe variance is necessar or area) sought. The explain the issue. If Submit a flash drive and a total property survey showing the chotographs, etc. as necessar.	written sheet of paper, state the principal the construction, addition or alteration by and demonstrate how the variance sate criteria for the two types of variances you wish you may also state your argumant of three (3) copies (residential) or eight (8) construction and all other try to describe and support your application) with	that requires the variance. atisfies the criteria for the ty are attached. (If an interprement for how the issue shown opies (commercial), of the applicance of the required fee, to the Office of the	Explain why a pe of variance (use etation is sought, uld be resolved.) ation along with the lrawings, site maps,
	to the date of scheduled meeting of the Zoning	Board of Appeals.	
TATE OF NEW YORK COUNTY OF WESTCHE	ESTER ss.:		
	that all of the above statements and st with this application are true:	tatements contained in all p	apers I have
Sworn to before me this f	3rd Ap	plicant	5
Aleku Si	DERRA SIL NOTARY PUBLIC STATI WESTCHESTER		

Padriac Steinschneider

GOTHAM

Gotham Design & Community Development Ltd. 329 Broadway

Dobbs Ferry, New York 10522

(914) 693-5093 • Fax: (914) 693-5390 Cell (914) 906-4802 • arch329@gmail.com

May 5, 2020

Hastings-on-Hudson Building Department 7 Maple Street Hastings-on-Hudson, New York 10706

Re: 0 Pinecrest Parkway

Dear Mr. Minozzi, Building Inspector:

This letter is to itemize the changes that we have made to the design of the house proposed to be built at 0 Pinecrest Parkway since the April 16 Planning Board meeting, as well as note how we have addressed various concerns. This letter also confirms the documents that have been submitted in support of this application for the May 21, 2020 Planning Board meeting.

- 1. The main volume of the house has been lowered in height by adjusting the split from the entry to the first and second floors. This drops the ridge for the main volume of the house from el.199.92 to el.199.3. This puts this ridge 8.54 feet below the basement floor of the house to the east. It should be noted that this is a significant reduction from the el.208.92 height of the previous design. The elevation of the highest floor in the proposed house is at el.190.74 in the bonus room above the garage. The existing grade elevation of the site on that side of the house is at el.188. The second floor level in the proposed house is at el. 186.5. The first floor level in the proposed house is at el.175.25. The ceiling of the first floor of the house is lower than the paving in the easement.
- 2. The neighbor at 179 Broadway expressed concern that regrading was proposed within the easement that provides access to his property from Pinecrest Parkway. While the Easement Agreement does not restrict the rights of the 0 Pinecrest Parkway property owner to regrade this area, we understand the concern and we have limited the regrading proposed within the easement. It is very minor and does not affect the north half of the easement. We are shifting the 184 contour line approximately 10 feet to the north to facilitate creating a safe entry to the parking courtyard proposed for the new house. This enables the future owner of the 0 Pinecrest Parkway property to park their cars in the courtyard and garage, instead of in the paved easement serving 179 Broadway.
- 3. The owner of 177 Broadway suggested that we eliminate the bonus attic above the garage. While this is a very minor space, eliminating it would result in the house being too inconsequential as viewed from the street. As designed, the wall facing the street ranges from 11 to 13 feet in height and is 22 feet wide. This is just enough for people to be able to suspect that there is a house down the hill. This wall is approximately 80 feet from the west wall of the house at 177 Broadway and the height of its ridge at 201.21 is 6.63 feet below the basement floor of 177 Broadway.

Letter to Building Inspector Charles Minozzi

Re: 0 Pinecrest Parkway

May 5, 2020 Page 2 of 4.

- 4. Hudson Engineering has provided the site engineering for this new design. This includes the stormwater management system that controls rain water shedding across the site. It is as extensive as the previous design, although the disturbed site area has been significantly reduced.
- 5. Hudson Engineering has provided the Slopes Analysis for the revised site plan. The percentage of the steep sloped areas disturbed still requires consideration by the Planning Board, but it is dramatically reduced from the previous design. The SA-1 Slope Analysis Plan indicates that 1,748 square feet of the 4,131 square feet of the site that is sloped between 15% and 25% will be disturbed. This is 42% of those slopes, which exceeds the 35% Code limit. The Slopes Analysis Plan also indicates that 3,064 square feet of the 7,126 square feet of the site that is sloped more than 25% will be disturbed. This is 43% of those slopes, which exceeds the 25% Code limit. This requires a Special Hardship Exception from the Planning Board.
- 6. Aspect 120 has provided the revised landscaping design for this new design. This also is as extensive as it was for the previous design.
- 7. Concern was expressed at the April Planning Board meeting as to where children living in this house would be able to play outside. While there is a nice yard to the west of the house, we have looked at two alternative grading plans that create a relatively level area on the north side of the house at the basement level. Sketch site plans for these options have been provided. These have also been evaluated by Hudson Engineering to confirm the increase in the steep sloped area disturbed. It is our opinion that this increased disturbance in area is deminimus in terms of impacts on the environment, the appearance of the property, slope stability, or stormwater runoff. If one of these alternatives is preferred by the Planning Board, it can become the preferred design.
- 8. Concern was expressed at the April Planning Board meeting that the proposed house with a total of approximately 2,800 square feet of habitable area on the two main floor levels, excluding the garage and the basement, was large for the neighborhood. An analysis of the houses in the neighborhood has been prepared and provided. We contend that the size of the house proposed is fully consistent with the neighborhood, fitting into the average/middle range.
- 9. It is our understanding that we will still need one variance from the Zoning Board of Appeals for the fact that the total site coverage proposed is 39.99%, where 35% is permitted. It should be noted that a significant factor in this coverage is the existing paving in the easement, over which the property owner has limited control. Without considering the paved easement, the total site coverage is 25.93%, which is within the permitted limit. Both of these numbers has been reduced from the numbers that we had for the April meeting. The zoning permits the house itself to occupy 25% of the site and the house proposed has a building coverage of 16.42%.

Letter to Building Inspector Charles Minozzi

Re: 0 Pinecrest Parkway

May 5, 2020 Page 3 of 4.

The following documents have been submitted with this letter for this application:

A. A set of five sheets of drawings prepared by Gotham Design & Community Development Ltd. under the supervision of Laura Wakefield, R.A., dated as submitted to the Planning Board May 5, 2020 including the following:

Sheet CS	"Cover Sheet, Location Maps, Design Criteria Table" dated as revised 4/14/2020.
Sheet SP-1.1	"Site Plan" dated as revised 4/30/2020.
Sheet SP-1.2	"Floor Plans" dated as revised 4/22/2020.
Sheet SP-1.3	"Elevations" dated as revised 4/30/2020.
Sheet SP-1.4	"Building Sections" dated as revised 4/22/2020.

- B. A set of two sheets of drawings prepared by Hudson Engineering & Consulting, P.C. including the following:
 - Sheet C-1 "Stormwater Management and Erosion & Sediment Control Plan" dated as revised 5/1/2020.
 - Sheet C-2 "Site Details" dated as issued 12/20/2019.
- C. Sheet SA-1 "Slope Analysis Plan" prepared by Hudson Engineering & Consulting, P.C. dated as revised 5/1/2020.
- D. Sheet L-1 "Landscaping Plan" prepared by Aspect 120, dated 5/4/2020.
- E. Sheets SP-ALT 1 and SP-ALT 2 prepared by Gotham Design & Community Development Ltd. Dated 4/30/2020 showing alternative grading plans on the north side of the proposed house for a play area.
- F. Sheets SA-alt1 and SA-alt2 prepared by Hudson Engineering & Consulting, P.C. dated as issued 5/1/2020 showing the calculations for the site disturbance to steep sloped areas for the two alternatives creating a play area on the north dise of the house.
- G. The Stormwater Management Plan & Drainage Analysis prepared by Hudson Engineering & Consulting, P.C. dated as revised May 1, 2020.
- H. A Response, dated May 5, 2020, to the Hahn Memorandum dated March 19, 2020 prepared by Gotham Design & Community Development Ltd., Hudson Engineering & Consulting, P.C., and Aspect 120 Landscape Architecture.
- I. A Memorandum and Steep Slope Narrative prepared by Gotham Design & Community Development, Ltd., Hudson Engineering & Consulting, P.C., and Aspect 120 dated May 5, 2020.
- J. A Neighborhood Context Report prepared by Gotham Design & Community Development Ltd. dated May 5, 2020 that documents the size of the houses in the Pinecrest Parkway neighborhood for comparison to the proposed house.


Letter to Building Inspector Charles Minozzi Re: 0 Pinecrest Parkway May 5, 2020 Page 4 of 4.

These documents replace the same that were previously submitted. Other documents were previously submitted that remain in effect, such as the applications and the View Preservation Report.

Thank you for your time and consideration.

Sincerely,

GOTHAM DESIGN & COMMUNITY DEVELOPMENT LTD. Paddy Steinschneider, President As Agent for William Hanauer, Executor

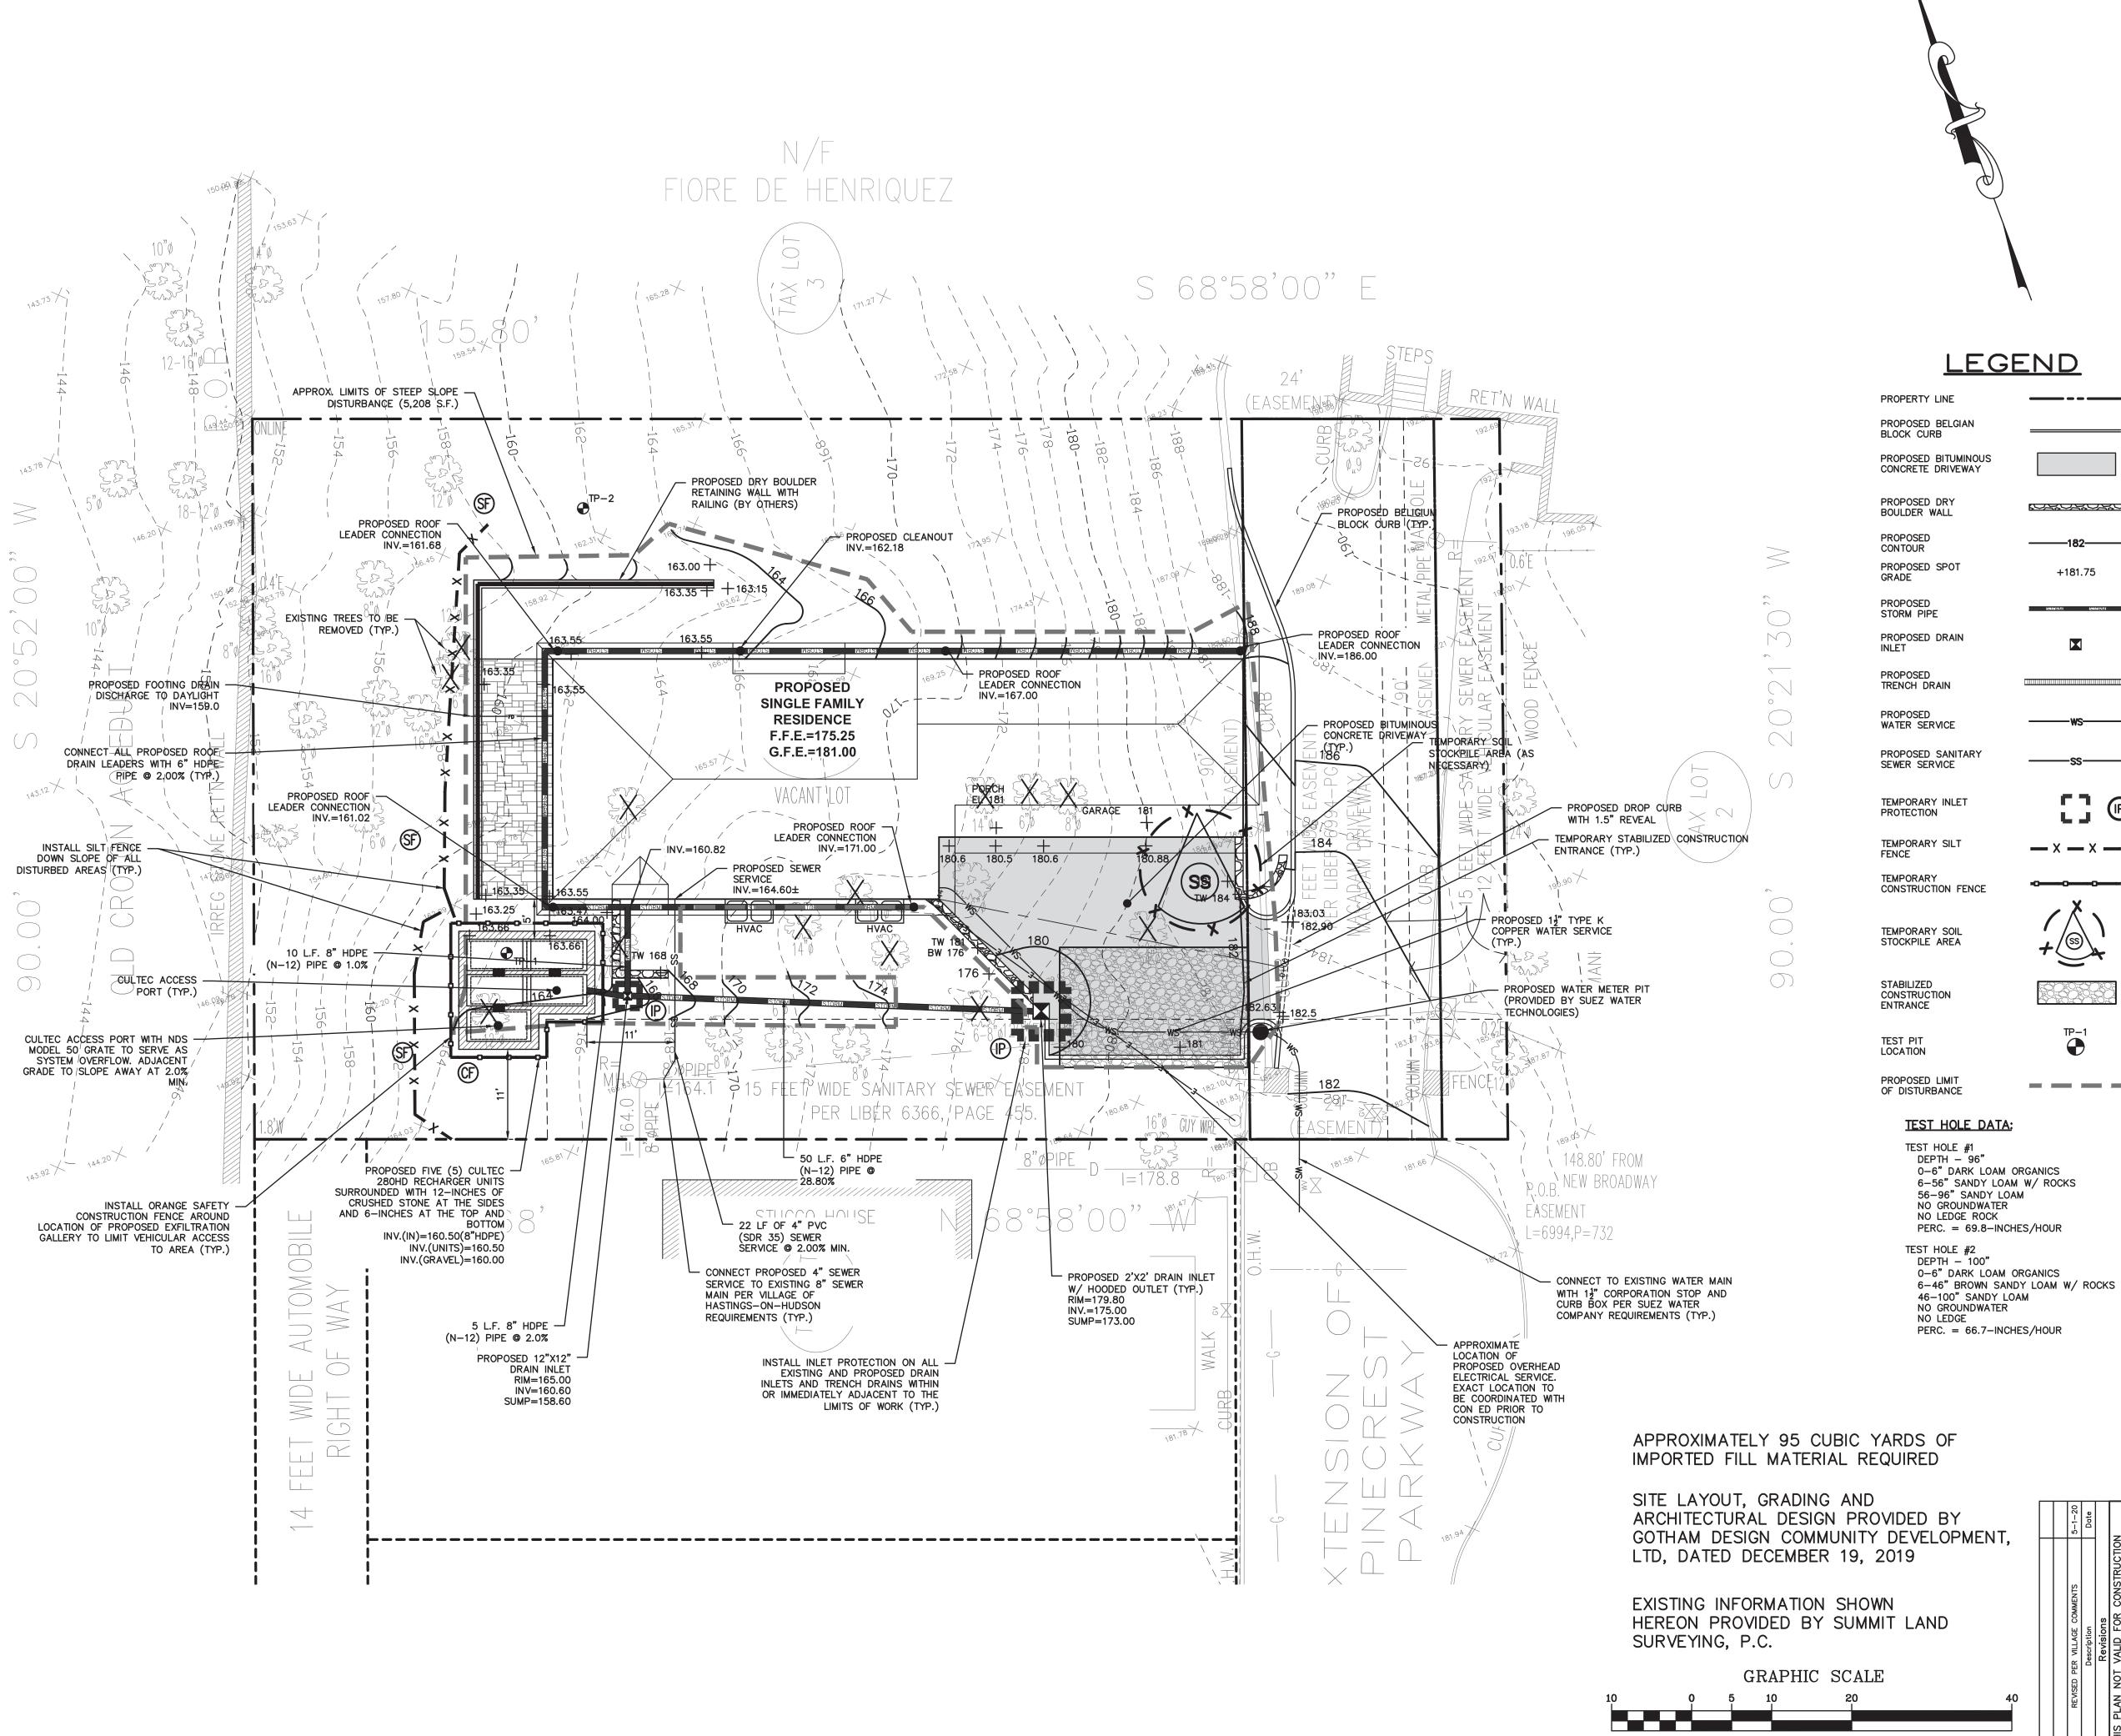

GENERAL NOTES:

LEGEND

-----182-----

+181.75

- 1. THE ENGINEER SHALL NOT BE RESPONSIBLE FOR THE SUPERVISION OF THE CONSTRUCTION. . NO CHANGES SHALL BE MADE TO THESE PLANS EXCEPT AS PER NYS LAW CHAPTER 987. . ALL WORK AND MATERIALS SHALL COMPLY WITH ALL APPLICABLE CODES, INCLUDING BUT NOT LIMITED TO ACI, AISC, ZONING, AND THE NEW YORK STATE BUILDING CODE.
- 4. ALL CONDITIONS, LOCATIONS AND DIMENSIONS SHALL BE FIELD VERIFIED AND THE ENGINEER SHALL BE IMMEDIATELY NOTIFIED OF ANY DISCREPANCIES. 5. ALL CHANGES MADE TO THE PLANS SHALL BE APPROVED BY THE ENGINEER AND ANY SUCH
- CHANGES SHALL BE FILED AS AMENDMENTS TO THE ORIGINAL BUILDING PERMIT. 6. THE CONTRACTOR SHALL SUPERVISE AND DIRECT THE WORK USING HIS BEST SKILL AND ATTENTION. HE SHALL BE SOLELY RESPONSIBLE FOR ALL CONSTRUCTION MEANS, METHODS, TECHNIQUES, SEQUENCES AND PROCEDURES AND FOR COORDINATING ALL PORTIONS OF THE
- WORK UNDER THE CONTRACT. 7. THE CONTRACTOR SHALL BE RESPONSIBLE TO THE OWNER FOR THE ACTS AND OMISSIONS OF HIS EMPLOYEES, SUBCONTRACTORS AND THEIR AGENTS AND EMPLOYEES, AND OTHER PERSONS PERFORMING ANY OF THE WORK UNDER A CONTACT WITH THE CONTRACTOR.
- 8. SAFETY DURING CONSTRUCTION SHALL BE THE RESPONSIBILITY OF THE CONTRACTOR AND SHALL CONFORM TO ALL LOCAL, STATE AND FEDERAL AGENCIES IN EFFECT DURING THE PERIOD OF CONSTRUCTION.
- 9. THE CONTRACTOR AND HIS SUBCONTRACTORS SHALL MAKE APPLICATION TO RECEIVE ALL NECESSARY PERMITS TO PERFORM THE WORK UNDER CONTRACT. THE CONTRACTOR AND HIS SUBCONTRACTORS SHALL BE LICENSED TO DO ALL WORK AS REQUIRED BY THE LOCAL, COUNTY, AND STATE AGENCIES WHICH MAY HAVE JURISDICTION OVER THOSE TRADES, AND SHALL PRESENT THE OWNER WITH COPIES OF ALL LICENSES AND INSURANCE CERTIFICATES.
- 10. FINAL GRADING AROUND THE BUILDING AREA SHALL SLOPE AWAY FROM THE STRUCTURE. 11. ALL WRITTEN DIMENSIONS ON THE DRAWINGS SHALL TAKE PRECEDENCE OVER ANY SCALED DIMENSIONS.
- 12. ADJOINING PUBLIC AND PRIVATE PROPERTY SHALL BE PROTECTED FROM DAMAGE DURING CONSTRUCTION, REMODELING AND DEMOLITION WORK. PROTECTION MUST BE PROVIDED FOR FOOTINGS, FOUNDATIONS, PARTY WALLS, CHIMNEYS, SKYLIGHTS AND ROOFS. PROVISIONS SHALL BE MADE TO CONTROL WATER RUNOFF AND EROSION DURING CONSTRUCTION OR DEMOLITION ACTIVITIES. THE PERSON MAKING OR CAUSING AN EXCAVATION TO BE MADE SHALL PROVIDE WRITTEN NOTICE TO THE OWNERS OF ADJOINING BUILDINGS ADVISING THEM THAT THE EXCAVATION IS TO BE MADE AND THAT THE ADJOINING BUILDING SHOULD BE PROTECTED. SAID NOTIFICATION SHALL BE DELIVERED NOT LESS THAN 10 DAYS PRIOR TO THE SCHEDULED STARTING DATE OF THE EXCAVATION.
- 13. OWNER SHALL INSURE THAT THE INSURANCE PROVIDED BY THE CONTRACTOR HIRED TO PERFORM THE WORK SHALL BE ENDORSED TO NAME HUDSON ENGINEERING & CONSULTING, P.C., AND ANY DIRECTORS, OFFICERS, EMPLOYEES, SUBSIDIARIES, AND AFFILIATES, AS ADDITIONAL INSURED ON ALL POLICIES AND HOLD HARMLESS DOCUMENTS, AND SHALL STIPULATE THAT THIS INSURANCE IS PRIMARY, AND THAT ANY OTHER INSURANCE OR SELF—INSURANCE MAINTAINED BY HUDSON ENGINEERING & CONSULTING, P.C., SHALL BE EXCESS ONLY AND SHALL NOT BE CALLED UPON TO CONTRIBUTE WITH THIS INSURANCE. ADDITIONAL INSURED ENDORSEMENT FORM NUMBER CG2010 1185 UNDER GL. COPIES OF THE
- INSURANCE POLICIES SHALL BE SUBMITTED TO HUDSON ENGINEERING & CONSULTING, P.C., FOR APPROVAL PRIOR TO THE SIGNING OF THE CONTRACT. 14. INDUSTRIAL CODE RULE 753: THE CONTRACTOR SHALL NOTIFY ALL UTILITY COMPANIES 72 HOURS PRIOR TO THE START OF HIS OPERATIONS AND SHALL COMPLY WITH ALL THE LATEST INDUSTRIAL CODE RULE 753 REGULATIONS.

INSTALLATION & MAINTENANCE OF EROSION CONTROL:

NOTIFY APPROPRIATE MUNICIPAL AGENCY HAVING JURISDICTION AT LEAST 5 DAYS PRIOR TO

EROSION CONTROL MEASURES INSTALL ALL EROSION CONTROL MEASURES PRIOR TO START OF CONSTRUCTION. CALL FOR INSPECTION FROM THE APPROPRIATE MUNICIPAL AGENCY HAVING JURISDICTION AT LEAST 2 DAYS

INSPECTION BY MUNICIPALITY MAINTENANCE (TO BE PERFORMED DURING ALL PHASES OF CONSTRUCTION)

AFTER ANY RAIN CAUSING RUNOFF, CONTRACTOR TO INSPECT HAYBALES, ETC. AND REMOVE ANY EXCESSIVE SEDIMENT AND INSPECT STOCKPILES AND CORRECT ANY PROBLEMS WITH SEED INSPECTIONS SHALL BE DOCUMENTED IN WRITING AND SUBMITTED TO THE APPROPRIATE MUNICIPAL AGENCY HAVING JURISDICTION.

REMOVE UNNEEDED SUBGRADE FROM SITE CALL FOR INSPECTION FROM THE APPROPRIATE MUNICIPAL AGENCY HAVING JURISDICTION AT

INSPECTION BY MUNICIPALITY - LANDSCAPING

SPREAD TOPSOIL EVENLY OVER AREAS TO BE SEEDED. HAND RAKE LEVEL. BROADCAST 1.25 LB. BAG OF JONATHAN GREEN "FASTGROW" MIX OR EQUAL OVER AREA TO BE SEEDED. APPLY STRAW MULCH AND WATER WITHIN 2 DAYS OF COMPLETION OF TOPSOILING. CALL FOR INSPECTION FROM THE APPROPRIATE MUNICIPAL AGENCY HAVING JURISDICTION AT LEAST 2 DAYS PRIOR TO FINISH.

INSPECTION BY MUNICIPALITY - FINAL LANDSCAPING

GRASS ESTABLISHED.

LEAST 2 DAYS PRIOR TO FINISH.

PRIOR TO FINISH.

CALL FOR INSPECTION FROM THE APPROPRIATE MUNICIPAL AGENCY HAVING JURISDICTION AT LEAST 2 DAYS PRIOR TO FINISH.

INSPECTION BY MUNICIPALITY - FINAL INSPECTION

ALL FROSION CONTROL MEASURES REMOVED AND GRASS ESTABLISHED. CALL FOR INSPECTION FROM THE APPROPRIATE MUNICIPAL AGENCY HAVING JURISDICTION AT LEAST 2 DAYS PRIOR TO FINISH.

STORMWATER MANAGEMENT FACILITIES MAINTENANCE PROGRAM

THE FOLLOWING MAINTENANCE PLAN HAS BEEN DEVELOPED TO MAINTAIN THE PROPER FUNCTION OF ALL DRAINAGE AND EROSION AND SEDIMENT CONTROL FACILITIES: • MINIMIZE THE USE OF ROAD SALT FOR MAINTENANCE OF DRIVEWAY AREAS.

• DRAINAGE INLETS SHALL BE VACUUM SWEPT TWICE A YEAR, AT THE CONCLUSION OF THE LANDSCAPE SEASON IN THE FALL AND AT THE CONCLUSION OF THE SAND AND DE-ICING SEASON IN THE SPRING. INSPECT EXFILTRATION/ATTENUATION GALLERY FOR SEDIMENT AND REMOVE SAME IF FOUND.


THE PERMANENT MAINTENANCE PROGRAM WILL BE MANAGED BY THE FUTURE HOMEOWNERS UPON COMPLETION OF CONSTRUCTION AND ACCEPTANCE OF THE

- 1. THE BUILDING INSPECTOR OR VILLAGE ENGINEER MAY REQUIRE ADDITIONAL EROSION CONTROL MEASURES IF DEEMED APPROPRIATE TO MITIGATE UNFORESEEN SILTATION AND EROSION OF DISTURBED SOILS.
- 2. THE VILLAGE AND DESIGN ENGINEER MUST BE NOTIFIED UPON INSTALLATION OF INFILTRATION SYSTEM AND PRIOR TO BACKFILL. FAILURE TO NOTIFY AND SCHEDULE INSPECTION PRIOR TO BACKFILL WILL RESULT IN CONTRACTOR EXCAVATING AND UNCOVERING THE SYSTEM AT THEIR COST.
- "AS-BUILT" DRAWINGS OF THE SITE IMPROVEMENTS SHALL BE SUBMITTED TO THE VILLAGE ENGINEER FOR REVIEW PRIOR TO OBTAINING CERTIFICATE OF OCCUPANCY.
- 4. INFILTRATION SYSTEM ACCESS PORTS SHALL BE SHOWN ON THE "AS-BUILT".
- THE INFILTRATION SYSTEM MUST NOT BE CONNECTED UNTIL CONSTRUCTION IS COMPLETE AND THE SITE IS STABILIZED.

PROPOSED SINGLE FAMILY RESIDENCE O PINECREST PARKWAY VILLAGE OF HASTINGS-ON-HUDSON WESTCHESTER COUNTY - NEW YORK

STORMWATER MANAGEMENT AND



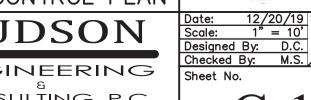

© 2019


ENGINEERING CONSULTING, P.C. 5 Knollwood Road – Suite 201 Elmsford, New York 10523

T: 914-909-0420 F: 914-560-2086


(IN FEET)

1 inch = 10 ft.

ANY ALTERATIONS OR REVISIONS OF THESE PLANS, UNLESS DONE BY OR UNDER THE DIRECTION OF THE NYS LICENSED AND REGISTERED ENGINEER THAT PREPARED THEM, IS A VIOLATION OF THE NYS EDUCATION LAW.

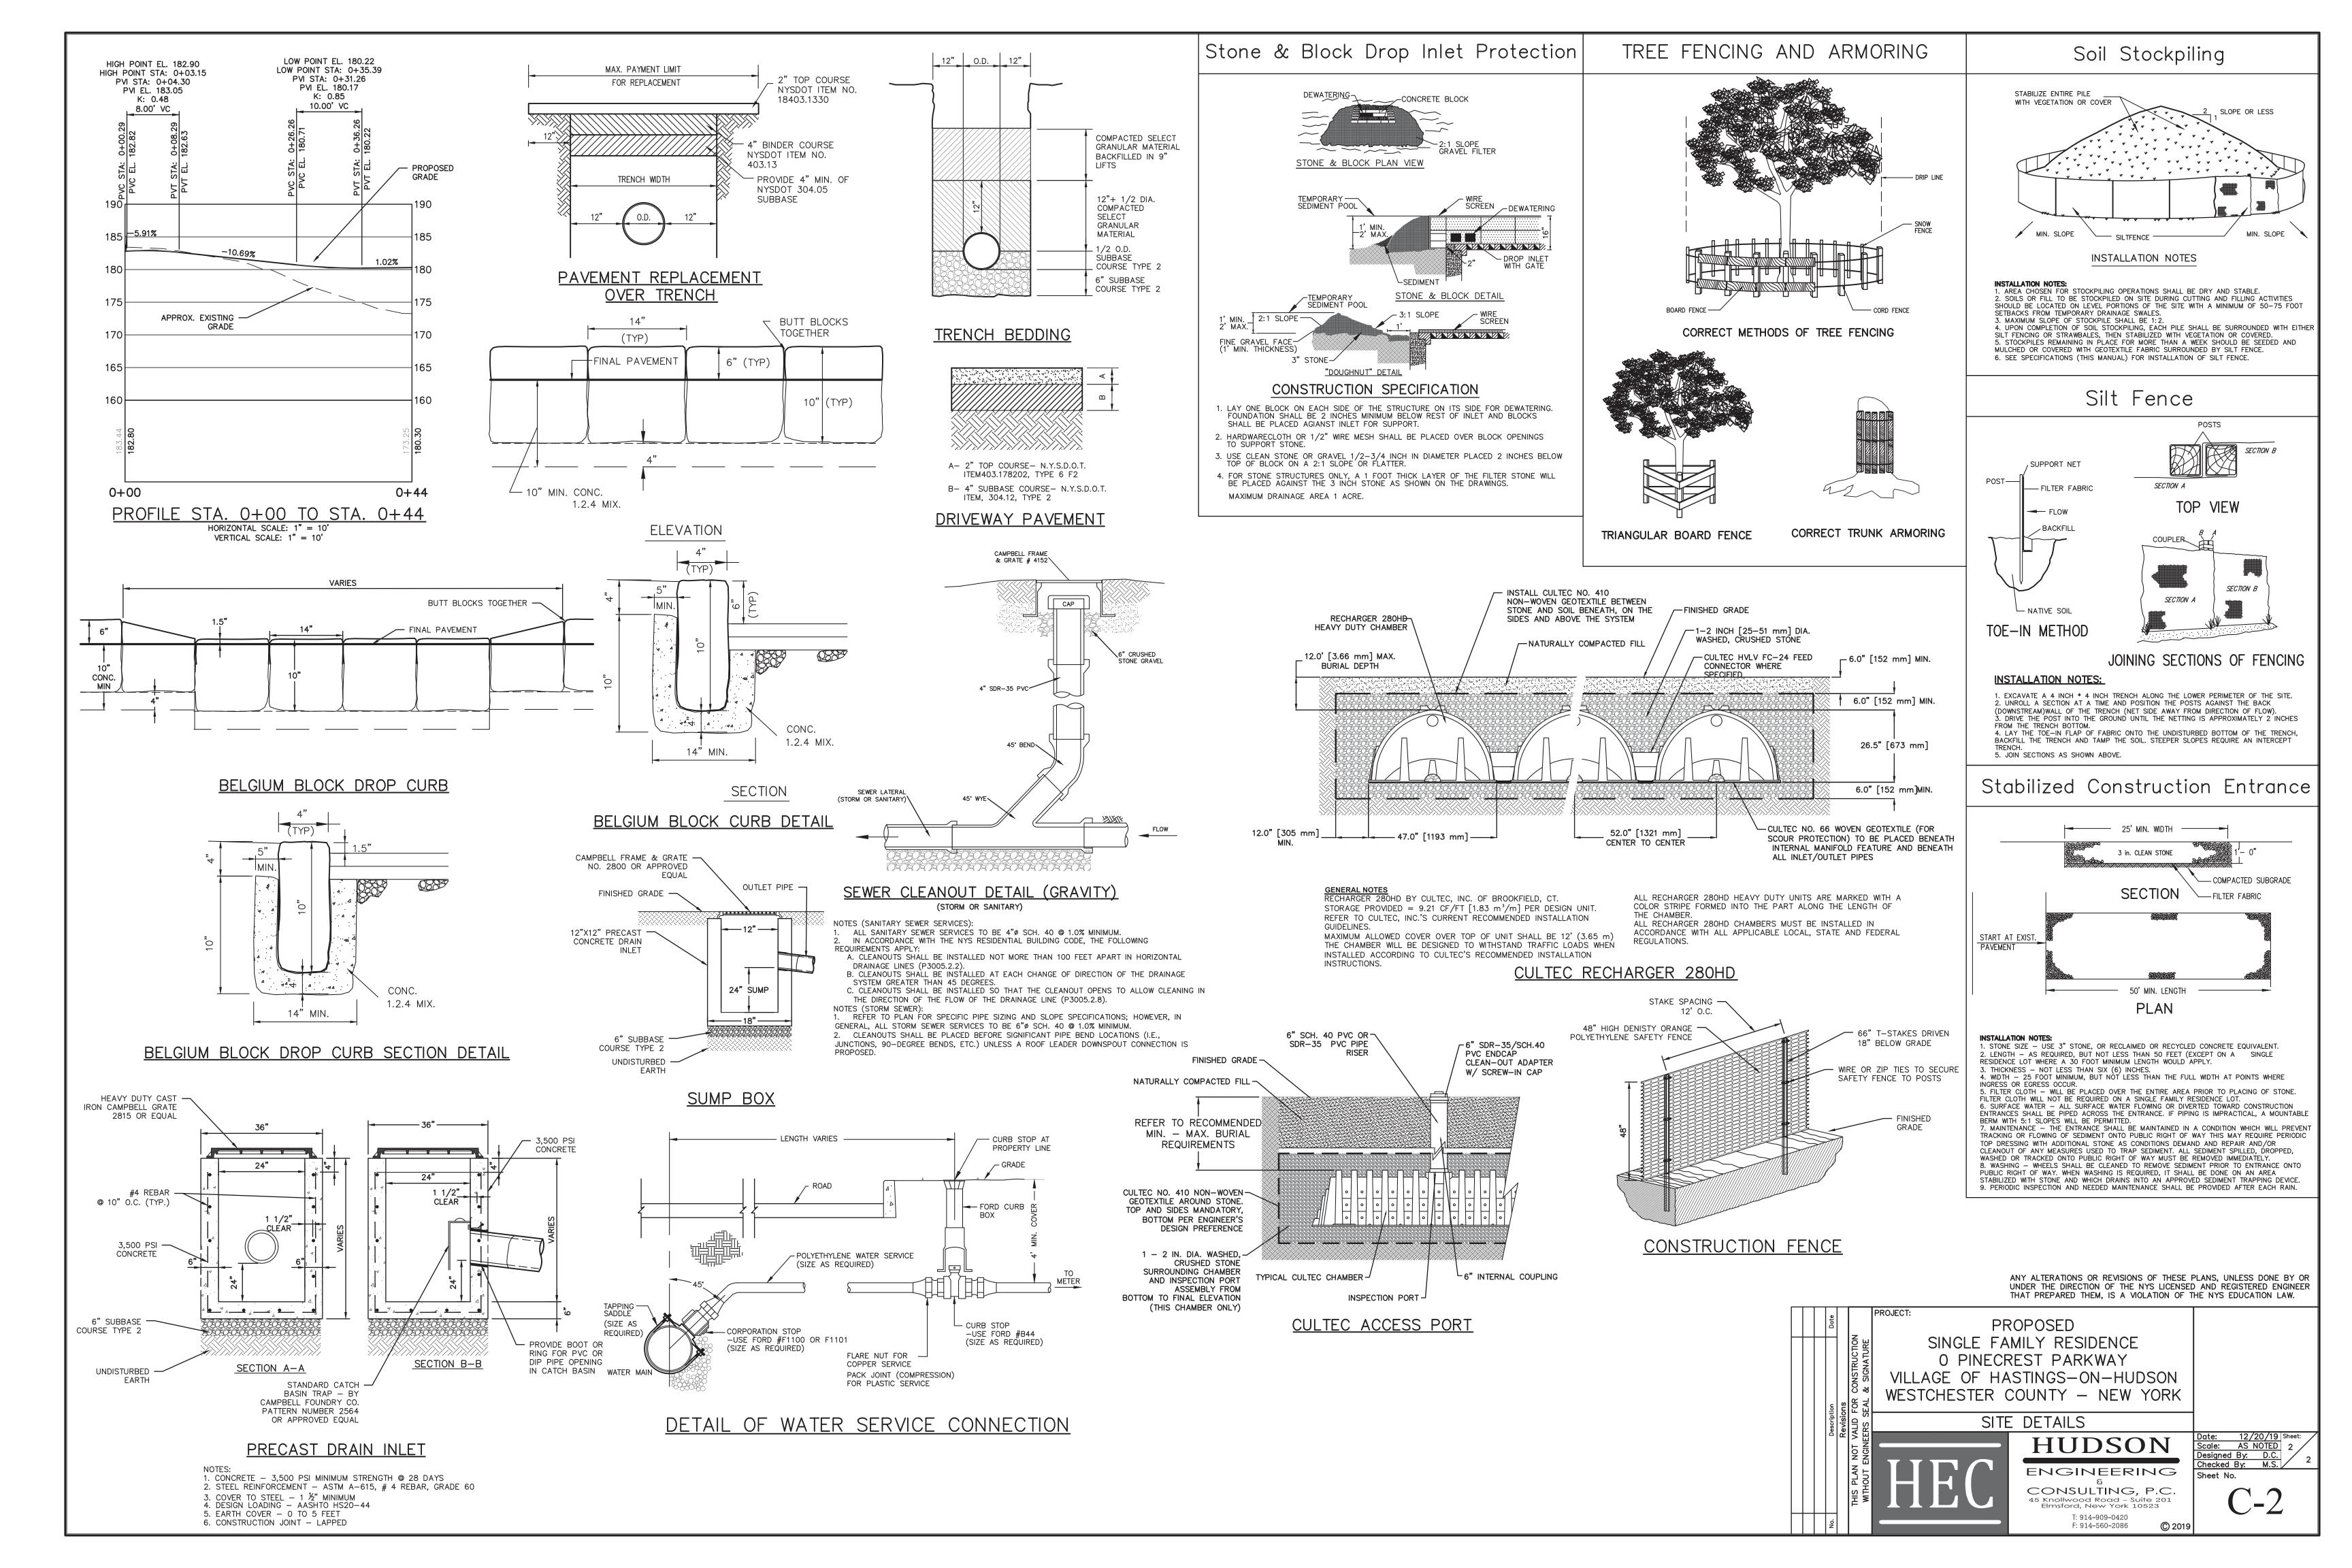



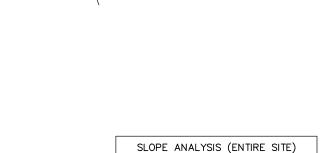

0%

15%

25%

3

SLOPE ANALYSIS (LIMIT OF DISTURBANCE)					
NO.	MIN. SLOPE	MAX. SLOPE	AREA	COLOR	
1	0%	15%	396		
2	15%	25%	1748		
3	25%	Vertical	3064		

NO. MIN. SLOPE MAX. SLOPE AREA COLOR

15%

25%

Vertical

2801

4131

7126

STEEP SLOPE DISTURBANCE							
STEEP SLOPE CATEGORY (%)	TOTAL AREA OF EXISTING STEEP SLOPES ALLOWABLE PERCENT OF DISTRUBANCE PER VILLAGE CODE (%)		ALLOWABLE AREA OF STEEP SLOPE DISTURBANCE (S.F.)	PROPOSED STEEP SLOPE DISTUBANCE		REQUIRED VARIANCE	
	ON-SITE (S.F.)	VILLAGE CODE (%)	DISTORBANCE (3.F.)	S.F.	%	S.F.	%
0-15%	2,801	100%	2,801	396	14%	0	0%
15-25%	4,131	35%	1,446	1,748	42%	302	7%
>25%	7,126	25%	1,782	3,064	43%	1,283	18%



SITE LAYOUT, GRADING AND ARCHITECTURAL DESIGN PROVIDED BY GOTHAM DESIGN COMMUNITY DEVELOPMENT, LTD, DATED DECEMBER 19, 2019

PROPOSED
SINGLE FAMILY RESIDENCE
O PINECREST PARKWAY
VILLAGE OF HASTINGS—ON—HUDSON
WESTCHESTER COUNTY— NEW YORK

SLOPE ANALYSIS PLAN

HUDSON

ENGINEERING

8

CONSULTING, P.C.

45 Knollwood Road - Suite 201


Elmsford, New York 10523

1.914-580-2086

© 201

SA-1



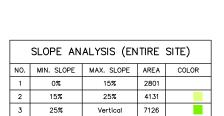

SLOPE ANALYSIS (LIMIT OF DISTURBANCE)					
NO.	MIN. SLOPE	MAX. SLOPE	AREA	COLOR	
1	0%	15%	445		
2	15%	25%	1927		
3	25%	Vertical	3332		

STEEP SLOPE DISTURBANCE								
STEEP SLOPE CATEGORY (%)	TOTAL AREA OF EXISTING STEEP SLOPES	ALLOWABLE PERCENT OF DISTRUBANCE PER VILLAGE CODE (%)	ALLOWABLE AREA OF STEEP SLOPE DISTURBANCE (S.F.)	SLO	ED STEEP OPE BANCE	REQUIRED VARIANCE		
	ON-SITE (S.F.)	VILLAGE CODE (%)	DISTURBANCE (3.F.)	S.F.	%	S.F.	%	
0-15%	2,801	100%	2,801	445	16%	0	0%	
15-25%	4,131	35%	1,446	1,927	47%	481	12%	
>25%	7,126	25%	1,782	3,332	47%	1,551	22%	




PROPOSED
SINGLE FAMILY RESIDENCE
O PINECREST PARKWAY
VILLAGE OF HASTINGS—ON—HUDSON
WESTCHESTER COUNTY — NEW YORK SLOPE ANALYSIS PLAN ALT 1









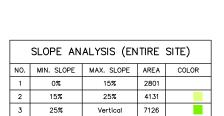

5	SLOPE ANALYSIS (LIMIT OF DISTURBANCE)						
NO.	MIN. SLOPE	MAX. SLOPE	AREA	COLOR			
1	0%	15%	447				
2	15%	25%	2178				
3	25%	Vertical	3810				

STEEP SLOPE DISTURBANCE									
STEEP SLOPE CATEGORY (%)	TOTAL AREA OF EXISTING STEEP SLOPES	ALLOWABLE PERCENT OF DISTRUBANCE PER VILLAGE CODE (%)	UBANCE PER OF STEEP SLOPE		ED STEEP OPE BANCE	REQUIRED VARIANCE			
	ON-SITE (S.F.)	VILLAGE CODE (78)	DISTORDANCE (S.F.)	S.F.	%	S.F.	%		
0-15%	2,801	100%	2,801	447	16%	0	0%		
15-25%	4,131	35%	1,446	2,178	53%	732	18%		
>25%	7,126	25%	1,782	3,810	53%	2,029	28%		



SITE LAYOUT, GRADING AND ARCHITECTURAL DESIGN PROVIDED BY GOTHAM DESIGN COMMUNITY DEVELOPMENT, LTD, DATED DECEMBER 19, 2019

PROPOSED
SINGLE FAMILY RESIDENCE
O PINECREST PARKWAY
VILLAGE OF HASTINGS—ON—HUDSON
WESTCHESTER COUNTY — NEW YORK SLOPE ANALYSIS PLAN ALT 2



HUDSON ENGINEERING

& CONSULTING, P.C.

48 Knollwood Road - Suite 201


Elmsford, New York 10523


T. 914-990-402

F. 914-580-2088

© 201



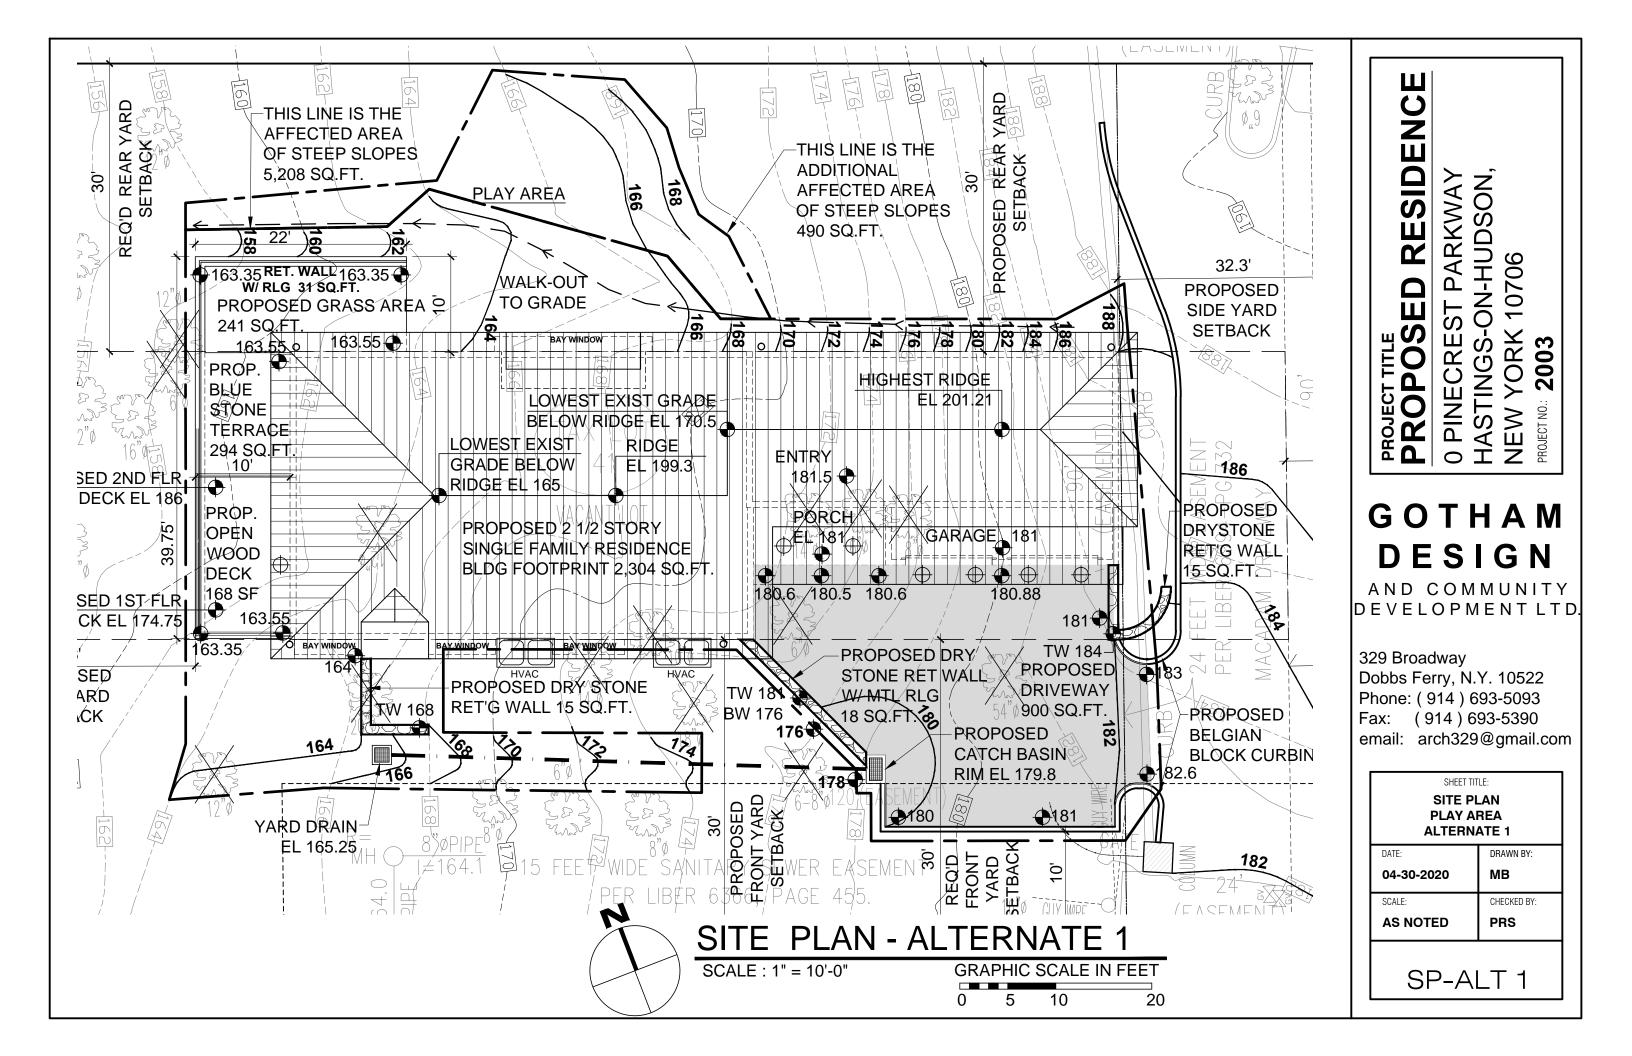

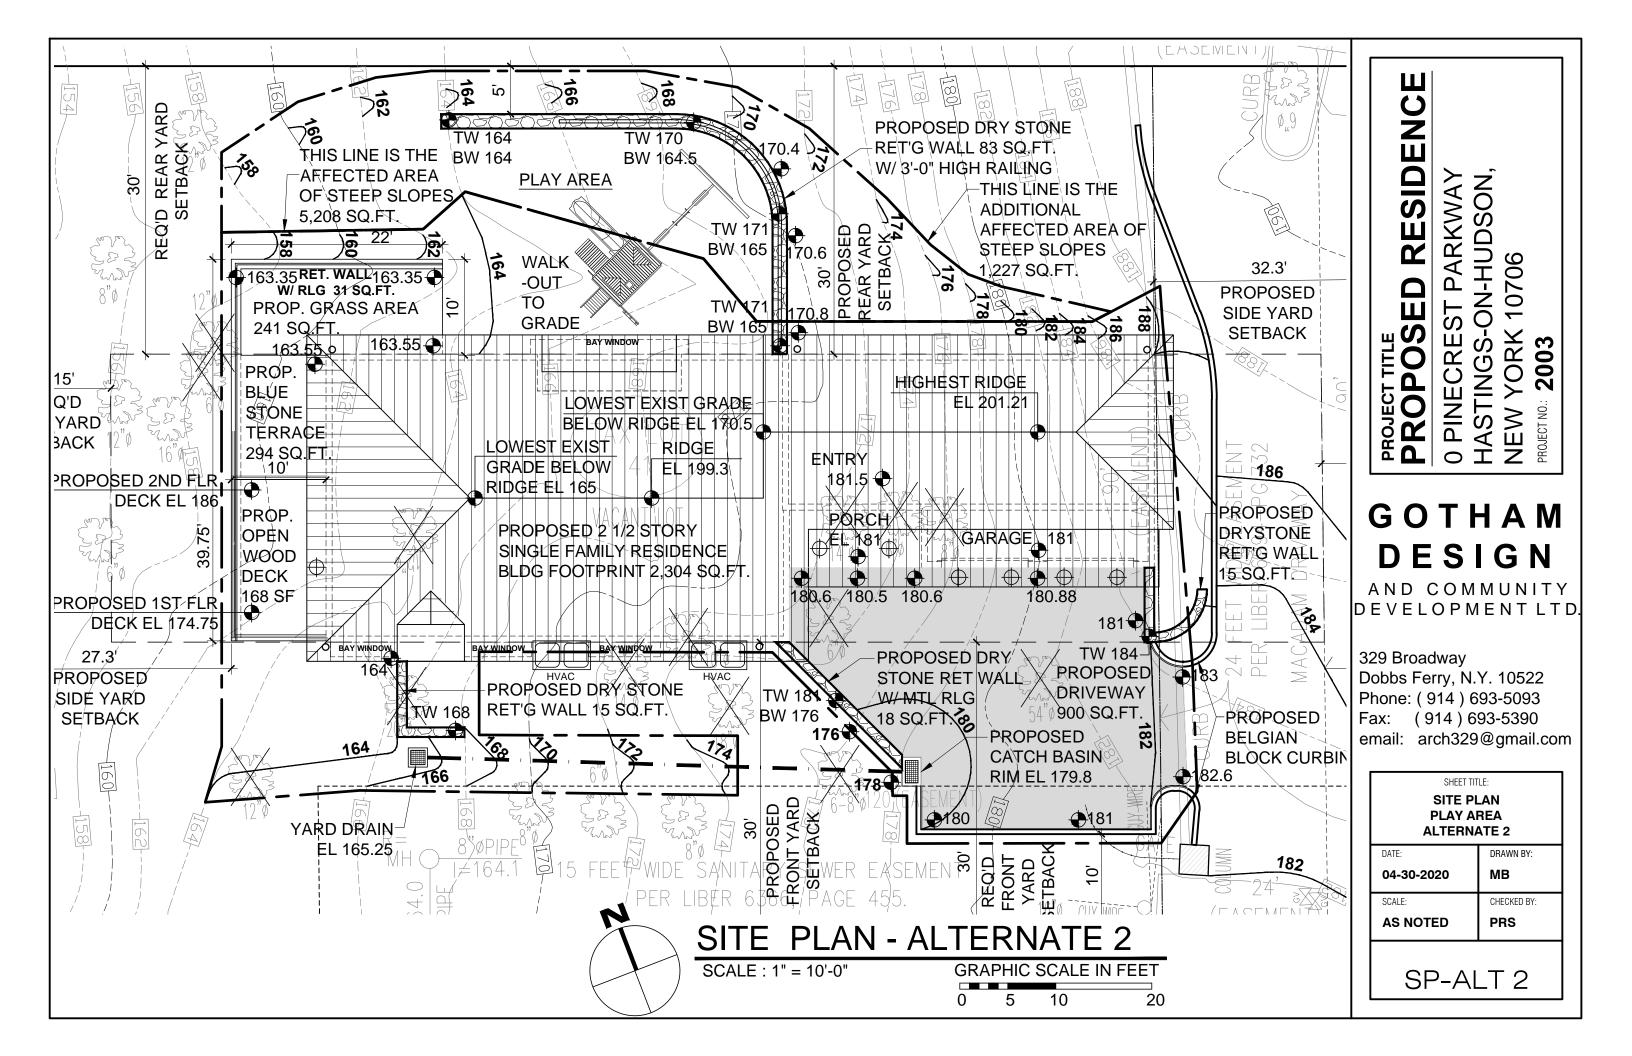

Hastings-on-Hudson

SITE LOCATION MAP NOT TO SCALE

Village of Hastings on Hudson Building Department 7 Maple Ave. Hastings on Hudso, NY 10706 (914) 478-3400 ext. 613

				CLIMAT	TIC AND GEOGR	RAPHIC DES	SIGN CRITI	ERIA (Effect	ive 10/3/20	016)			
Location:	Village of Hasti	ngs on Hudson										Zip Code:	10706
		Wind E)esign		Subject to Damage From		-						
Ground Snow Load	Speed (mph)	Topo Effects	Special Wind Region	Wind-borne Debris Zone	Seismic Design Category (RCNY Only)	Weathering	Frost Line Depth	Termite	Climate Zone	Ice Barrier Underlayment Regd	Flood Hazards	Air Freezing Index	Mean Annual Temp
30	*Special Wind Region	NO	Yes	NO	С	Severe	42"	Moderate to Heavy	4A	YES	**FIRM COMMUNITY-PANEL MAP# 36119C0261F EFFECTIVE DATE, 9-28-2007	2000	51.6

* 115 MPH to 120 MPH, The special wind region should serve as a warning to design professionals in evaluating wind loading conditions. Wind speeds higher than the derived values taken from Section 1609 of the IBC and Figure R301.2(4)A of the IRC are likely to occur and should be considered in the design.


** State if applicable. For Flood Hazards the Design Professional shall state if they are applicable, Y/N. Verify with FIRM Maps. Maps are evailable on the FIMA web site http://www.floodmap.floodsimple.com/


		1	NSULATION AND	D FENESTRA	TION REQUI	REMENTS	BY COMP	ONENT		
CLIMATE ZONE	FENESTRATION U-FACTOR	SKYLIGHT U-FACTOR	GLAZED FENSTRATION SHGC	CEILING R-VALUE	WOOD FRAME WALL R-VALUE	MASS WALL R-VALUE	FLOOR R-VALUE	BASEMENT WALL R-VALUE	SLAB R-VALUE & DEPTH	CRAWL SPACE WALL R-VALUE
		TABLE R4	02.1.2 INSULATION	N AND FENEST	RATION REQUI	REMENTS B	Y COMPONE	NT		
4A	0.35	0.55	0.4	49	20 or 13+5	8/13	19	10/13	10, 2 FT	10/13
			TABL	E R402.1.4 EQL	JIVALENT U-FA	CTORS		W		
4A	0.35	0.55		0.026	0.06	0.098	0.047	0.047	0.059	0.065

PROPOSED RESIDENCE

0 PINECREST PARKWAY

HASTINGS - ON - HUDSON, N. Y. 10706

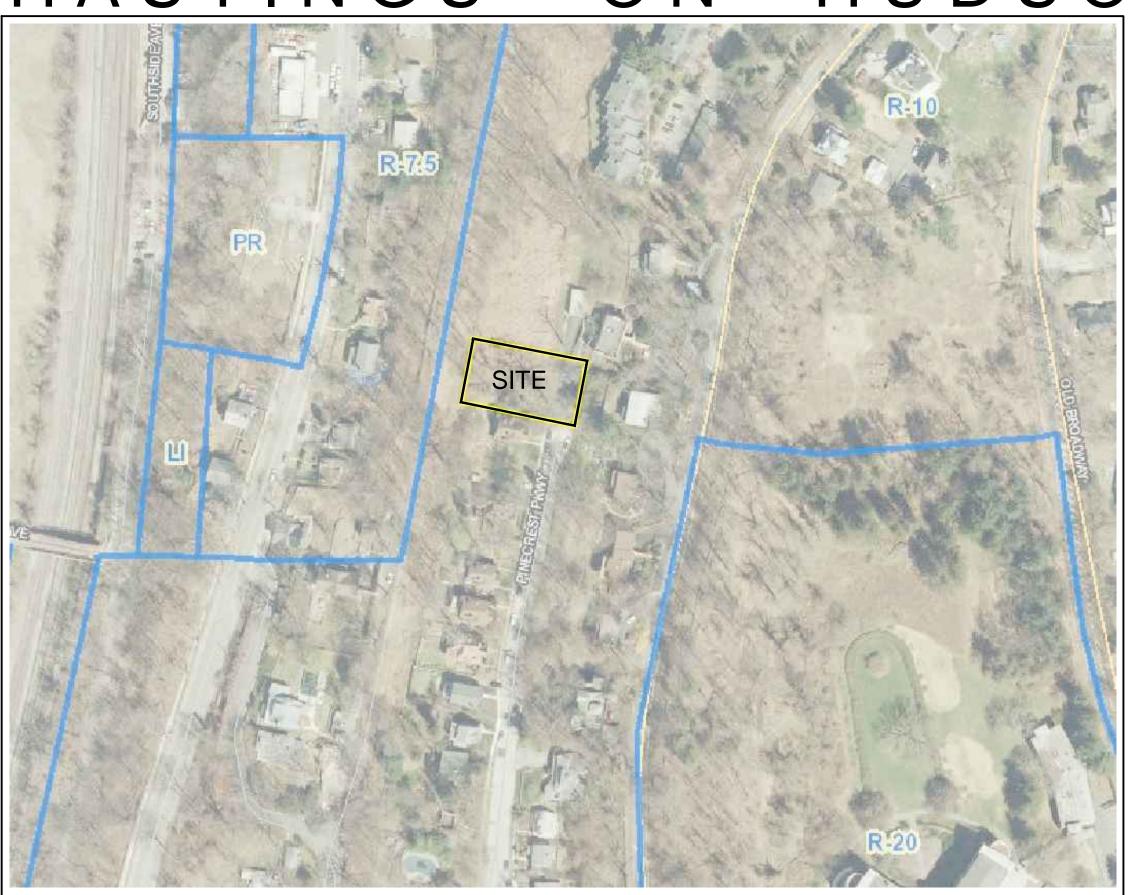


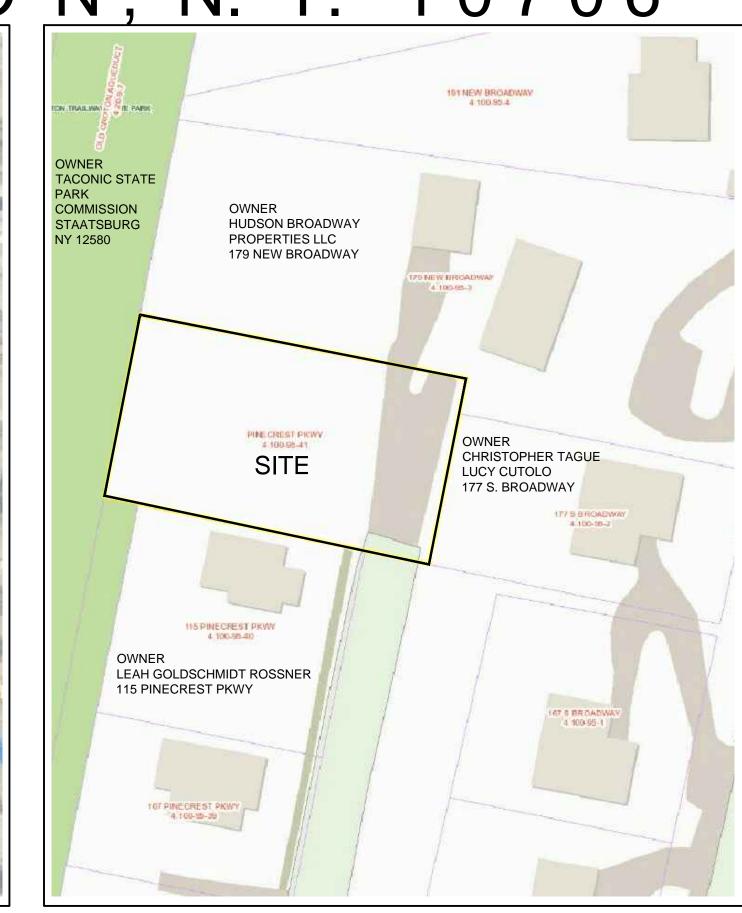





LIST	OF DRAWINGS	SUBMITTED TO PLANNING BOARD AND ZONING BOARD 03-05-2020	SUBMITTED TO ZONING BOARD 04-16-2020	SUBMITTED TO PLANNING BOARD 05-05-2020
No	SHEET TITLE	ISSUE DATE OR LAST REVISED	ISSUE DATE OR LAST REVISED	ISSUE DATE OR LAST REVISED
CS	COVER SHEET ,LOCATION MAPS, DESIGN CRITERIA TABLE	03-05-2020	04-16-2020	05-05-2020
SP-1.1	SITE PLAN	03-05-2020	04-14-2020	04-30-2020
SP-1.2	FLOOR PLANS 1/8" = 1'-0" SCALE	03-05-2020	03-19-2020	04-22-2020
SP-1.3	ELEVATIONS 1/8" = 1'-0" SCALE	03-05-2020	03-19-2020	04-30-2020
SP-1.4	BUILDING SECTIONS, SITE SECTION 1/8" = 1'-0" SCALE	03-05-2020	03-19-2020	04-22-2020

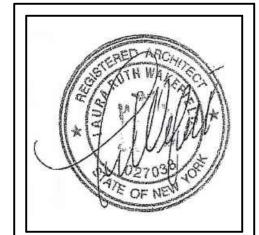

LAURA WAKEFIELD

ARCHITECT
329 BROADWAY
DOBBS FERRY, NY 10522
TEL: 914 693 6165
N.Y.S STATE LICENSE
No. 27038

JEW YORK 10706

POSED RESIDENC CREST PARKWAY NGS-ON-HUDSON, NEW

GOTHAM DESIGN

AND COMMUNITY DEVELOPMENT LTD.

329 Broadway
Dobbs Ferry, N.Y. 10522
Phone: (914) 693-5093
Fax: (914) 693-5390
email: arch329@gmail.com

ISSUED / REVISIONS
SUBMITTED TO 03-05-2020
PLANNING BOARD AND
ZONING BOARD
REVISED 03-19-2020

REVISED 03-19-2020
SHEETS SP-1 THRU SP-4
REVISED 04-14-2020
SHEET SP-1
SUBMITTED TO 04-16-2020
ZONING BOARD

SUBMITTED TO 05-05-2020 PLANNING BOARD

HEET TITLE:

COVER SHEET


TE: DRAWN BY:

 03-05-2020
 MB

 SCALE:
 CHECKED BY:

 AS NOTED
 PRS

CS

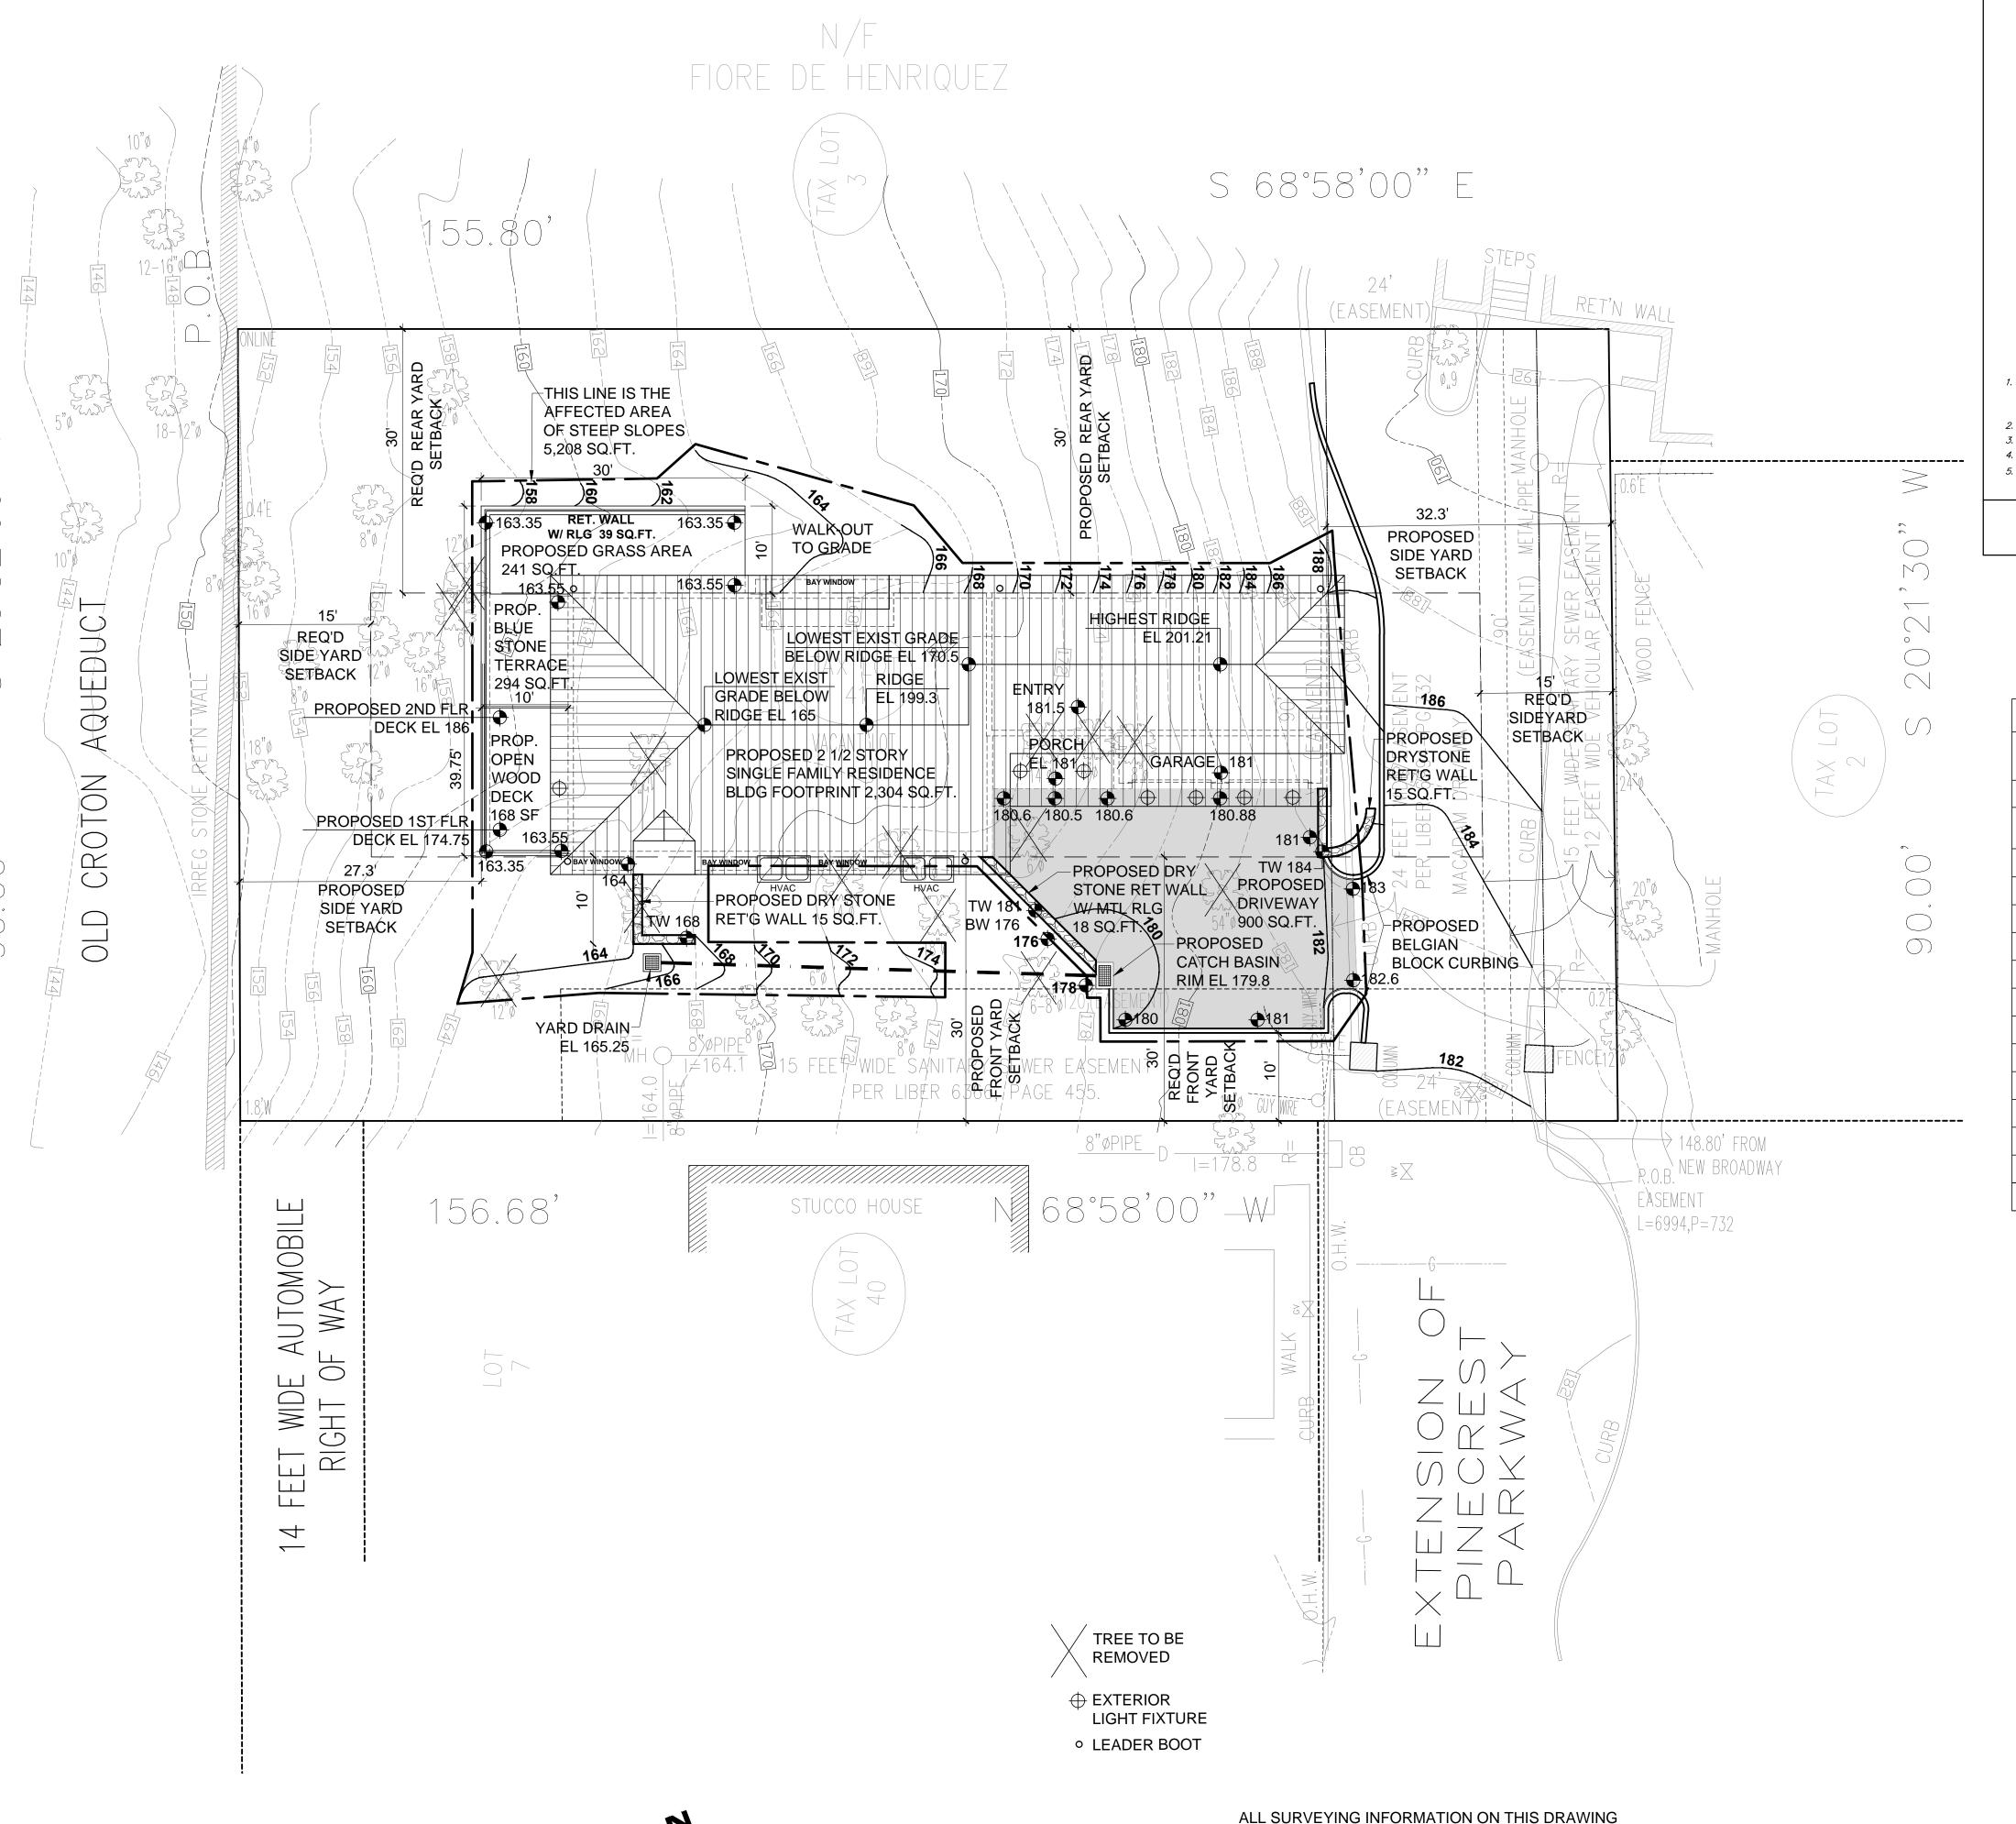


SITE PLAN

GRAPHIC SCALE IN FEET

0 5 10

SCALE : 1" = 10'-0"

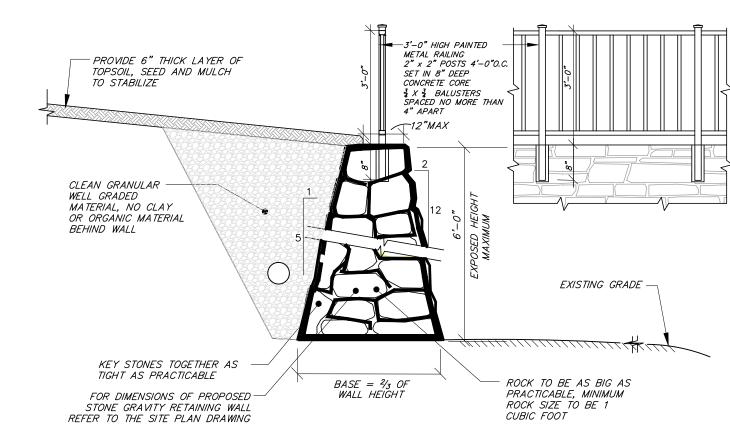


NOTES:

- 1. CONTRACTOR TO CONSTRUCT AND STABILIZE WALL AT BASE. CONTRACTOR SHALL BE RESPONSIBLE TO VERIFY THE EXISTING CONDITION
 OF SOIL UNDER PROPOSED WALL (FOUNDATION CONDITION). MINIMUM CONDITION SHALL CORRESPOND TO COMPACTED SAND WITHOUT
 ORGANICS, CLAY OR ANY OTHER UNSUITABLE MATERIAL. IF THIS CONDITION IS NOT ACHIEVED ON SITE CONTRACTOR MUST CONTACT
- DESIGN ENGINEER PRIOR TO STARTING WORK. 2. EXISTING ON—SITE ROUGH CUT STONE MATERIAL TO BE UTILIZED FOR WALL CONSTRUCTION.
- 3. CONTRACTOR TO PLACE STONE ON EXPOSED FACE WITH CARE TO DEVELOP AN AESTHETICALLY PLEASING WALL.
 4. MINIMUM ROCK SIZE SHALL BE 1 CUBIC FOOT, STONES TO BE PLACED AS TIGHT AS POSSIBLE.
- 5. WALL SHALL BEAR ON SOIL WITH 3 TON CAPACITY SOIL MINIMUM. CONTRACTOR SHALL BE RESPONSIBLE FOR TESTING SOIL.

DRY BOULDER RETAINING WALL WITH RAILING (TYPICAL SECTION)

PROPERTY LOCATION: 0 PINECREST PARKWAY HASTING OWNER: ESTATE OF ELISABETH F. DEROW, WILLIAM HANA			TAX ID: 4.100-95 E OSSINING, NY 10562	-41
ZONING DISTRICT R-10				
REQUIREMENT	UNITS	REQUIRED/ ALLOWED	PROPOSED	VARIANCI REQUEST
MINIMUM STREET FRONTAGE	FEET	70	25	
MINIMUM NET LOT AREA	SQ.FT.	10,000	14,057	
MINIMUM LOT WIDTH	FEET	100	155.8	
BUILDING COVERAGE	%	25	16.42	
DEVELOPMENT COVERAGE WITHOUT PAVED EASEMENT	%	35	25.93	
DEVELOPMENT COVERAGE WITH PAVED EASEMENT	%	35	39.99	YES
MINIMUM FRONT YARD SETBACK	FEET	30	30	
MINIMUM REAR YARD SETBACK	FEET	30	30	
MINIMUM SIDE YARD SETBACK EACH	FEET	12	27.3	
MINIMUM SIDE YARD SETBACK BOTH	FEET	30	59.6	
STORIES	NUMBER	2.5	2.5	
MAXIMUM HEIGHT	FEET	35	34.3	
OFF STREET PARKING	NUMBER	2	2	

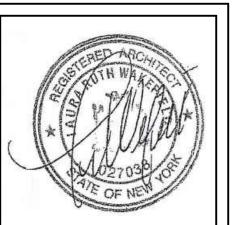

LAURA WAKEFIELD

ARCHITECT 329 BROADWAY DOBBS FERRY, NY 10522 TEL: 914 693 6165 N.Y.S STATE LICENSE No. 27038

SIDENCE
WAY
SON, NEW YORK 10706

0 PINECREST PARKWAY HASTINGS-ON-HUDSON, NI

R

PROPOS

GOTHAM DESIGN

AND COMMUNITY DEVELOPMENT LTD.

329 Broadway
Dobbs Ferry, N.Y. 10522
Phone: (914) 693-5093
Fax: (914) 693-5390
email: arch329@gmail.com

ISSUED / REVISIONS
SUBMITTED TO 03-05-2020
PLANNING BOARD AND
ZONING BOARD

ADDED RETAINING WALL AT

REVISED

CORNER OF GARAGE
RELOCATED HVAC EQUIPT
RELOCATED EXTERIOR LIGHTS
REVISED 04-14-202

REVISED 04-14-202 LOCATION OF CONTOURS 184 AND 186 IN EASEMENT

REVISED 04-22-2020 LOWERED HEIGHT OF BUILDING REVISED 04-30-2020 COORDINATED DRAWINGS WITH HUDSON ENGINEERING

SHEET TITLE:

SITE PLAN

DATE: DRAWN BY:

03-05-2020 MB


SCALE: CHECKED BY:


AS NOTED PRS


SP-1


ALL SURVEYING INFORMATION ON THIS DRAWING IS TAKEN FROM A SURVEY DATED OCTOBER 04, 2019 REVISED DECEMBER 4, 2019 PREPARED BY: SUMMIT LAND SURVEYING P.C.

21 DRAKE LANE
WHITE PLAINS NY 10607
TEL 914 629 - 7758

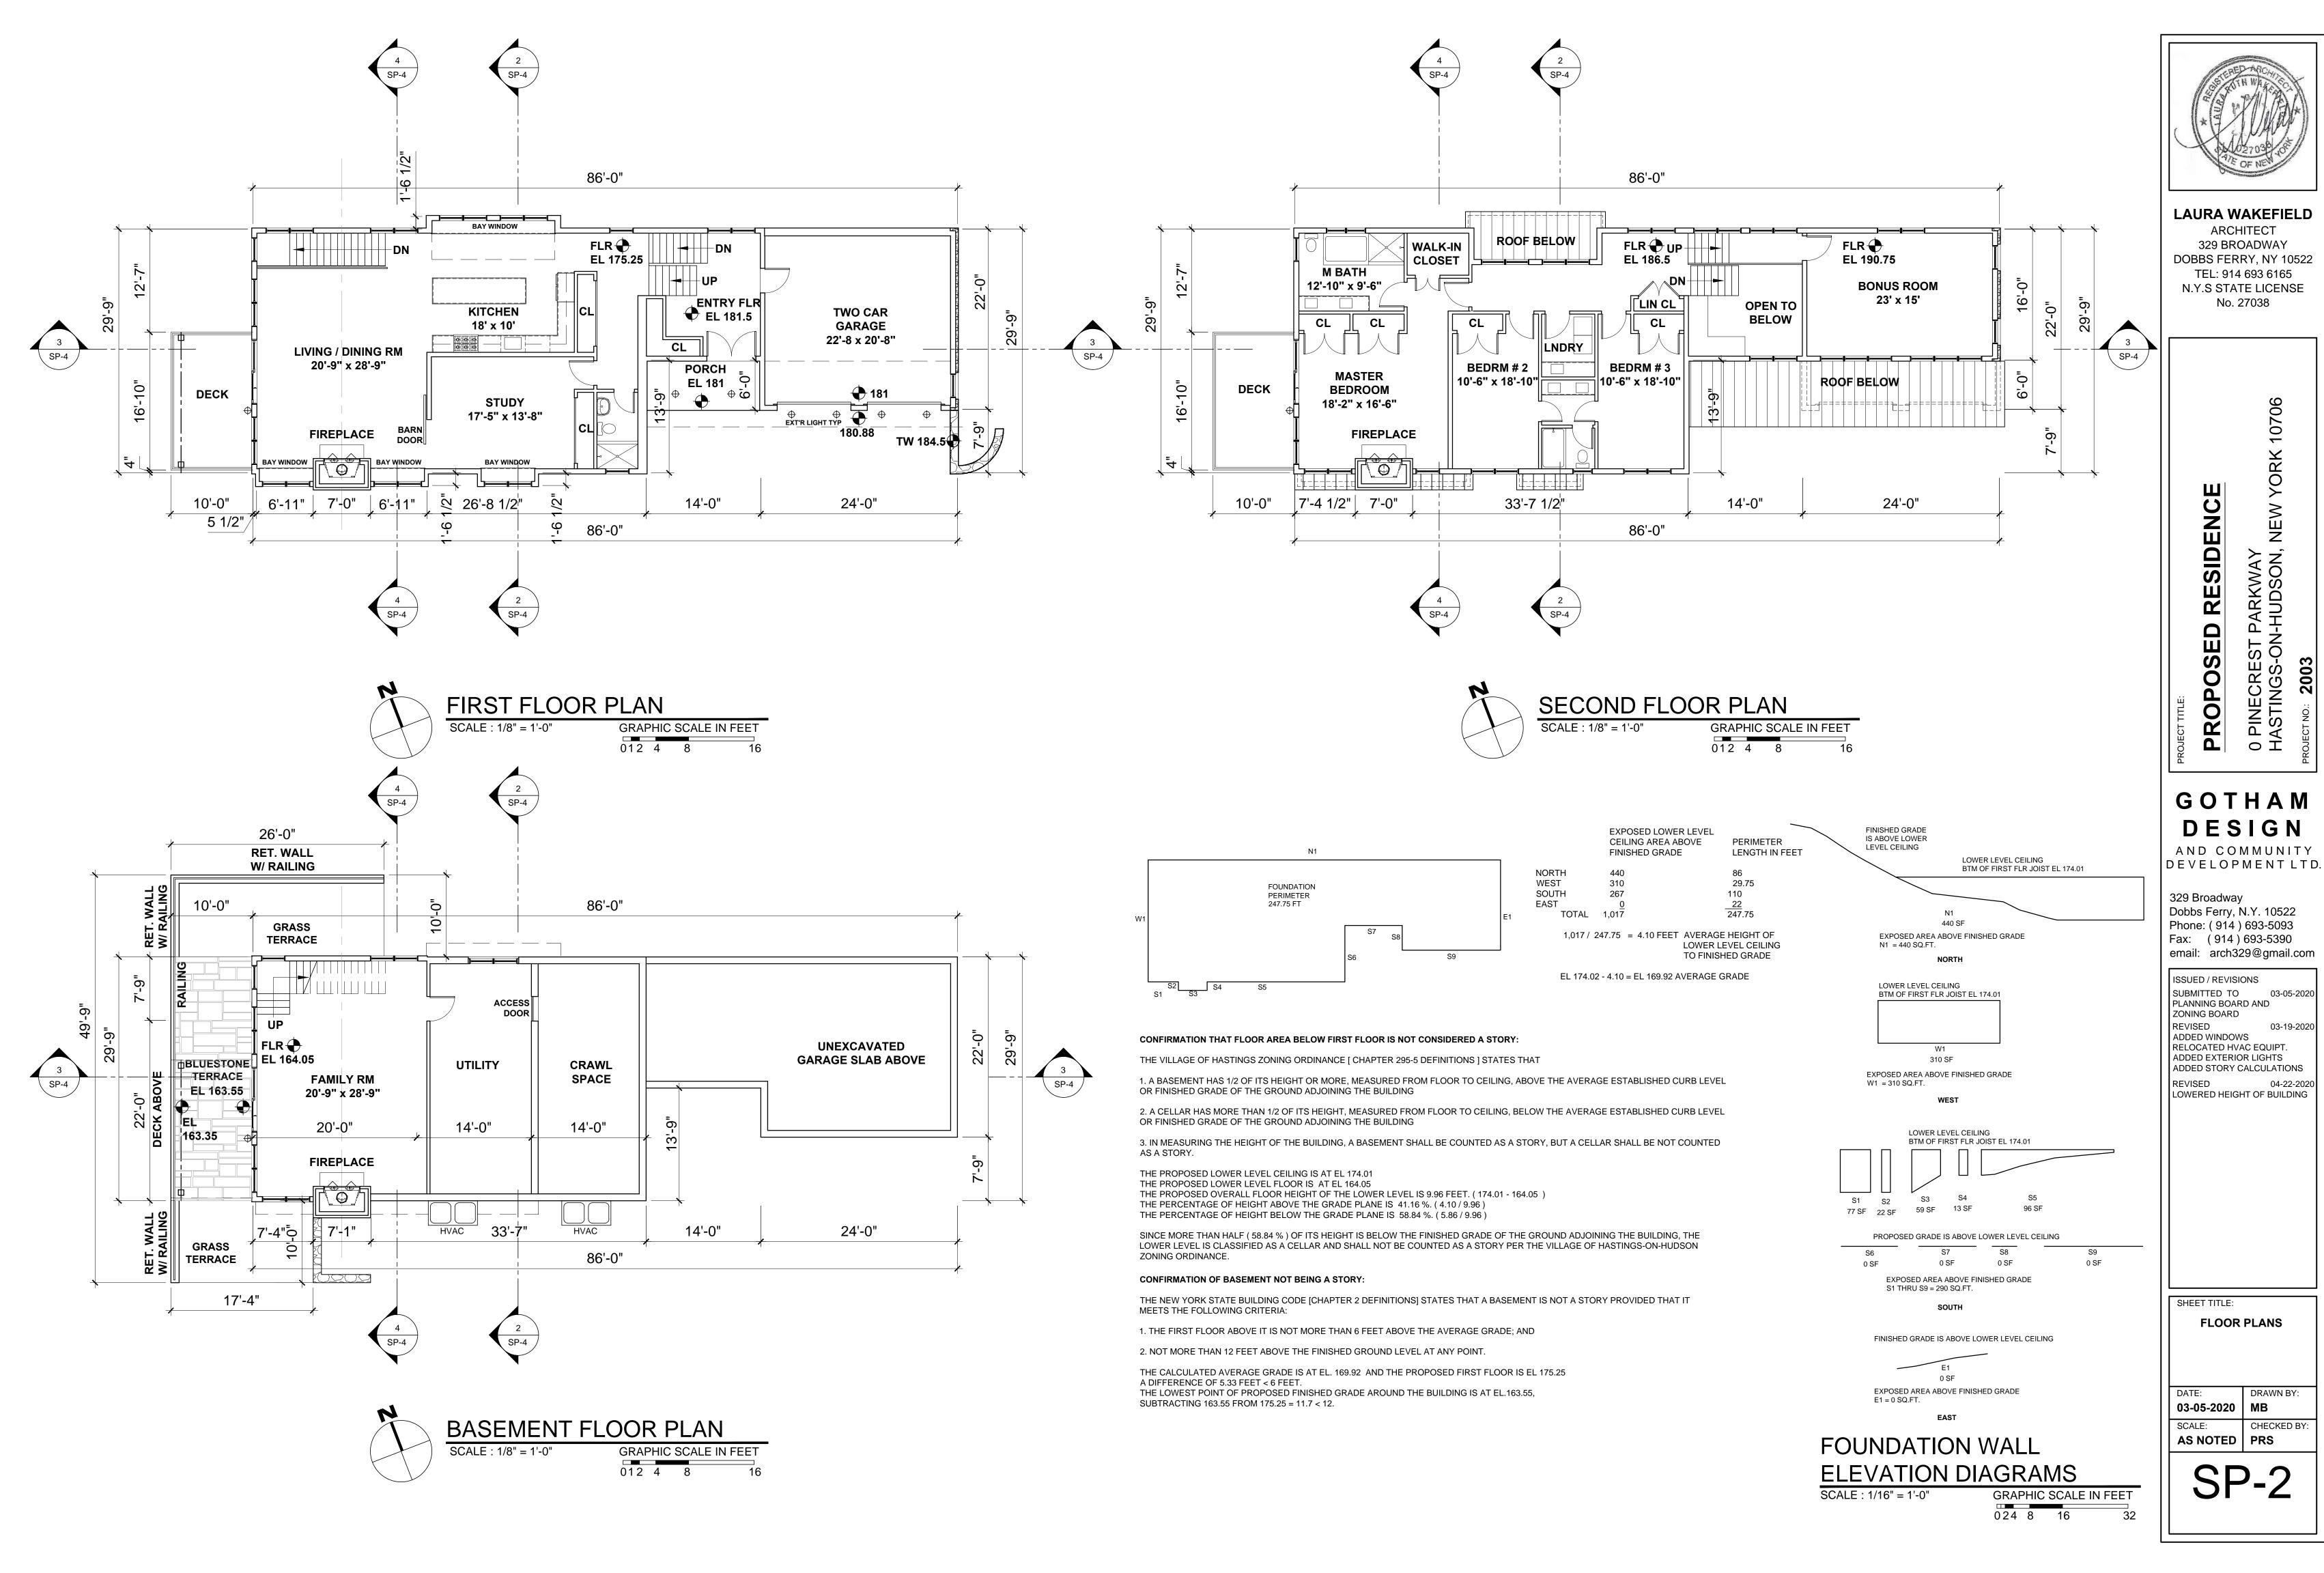

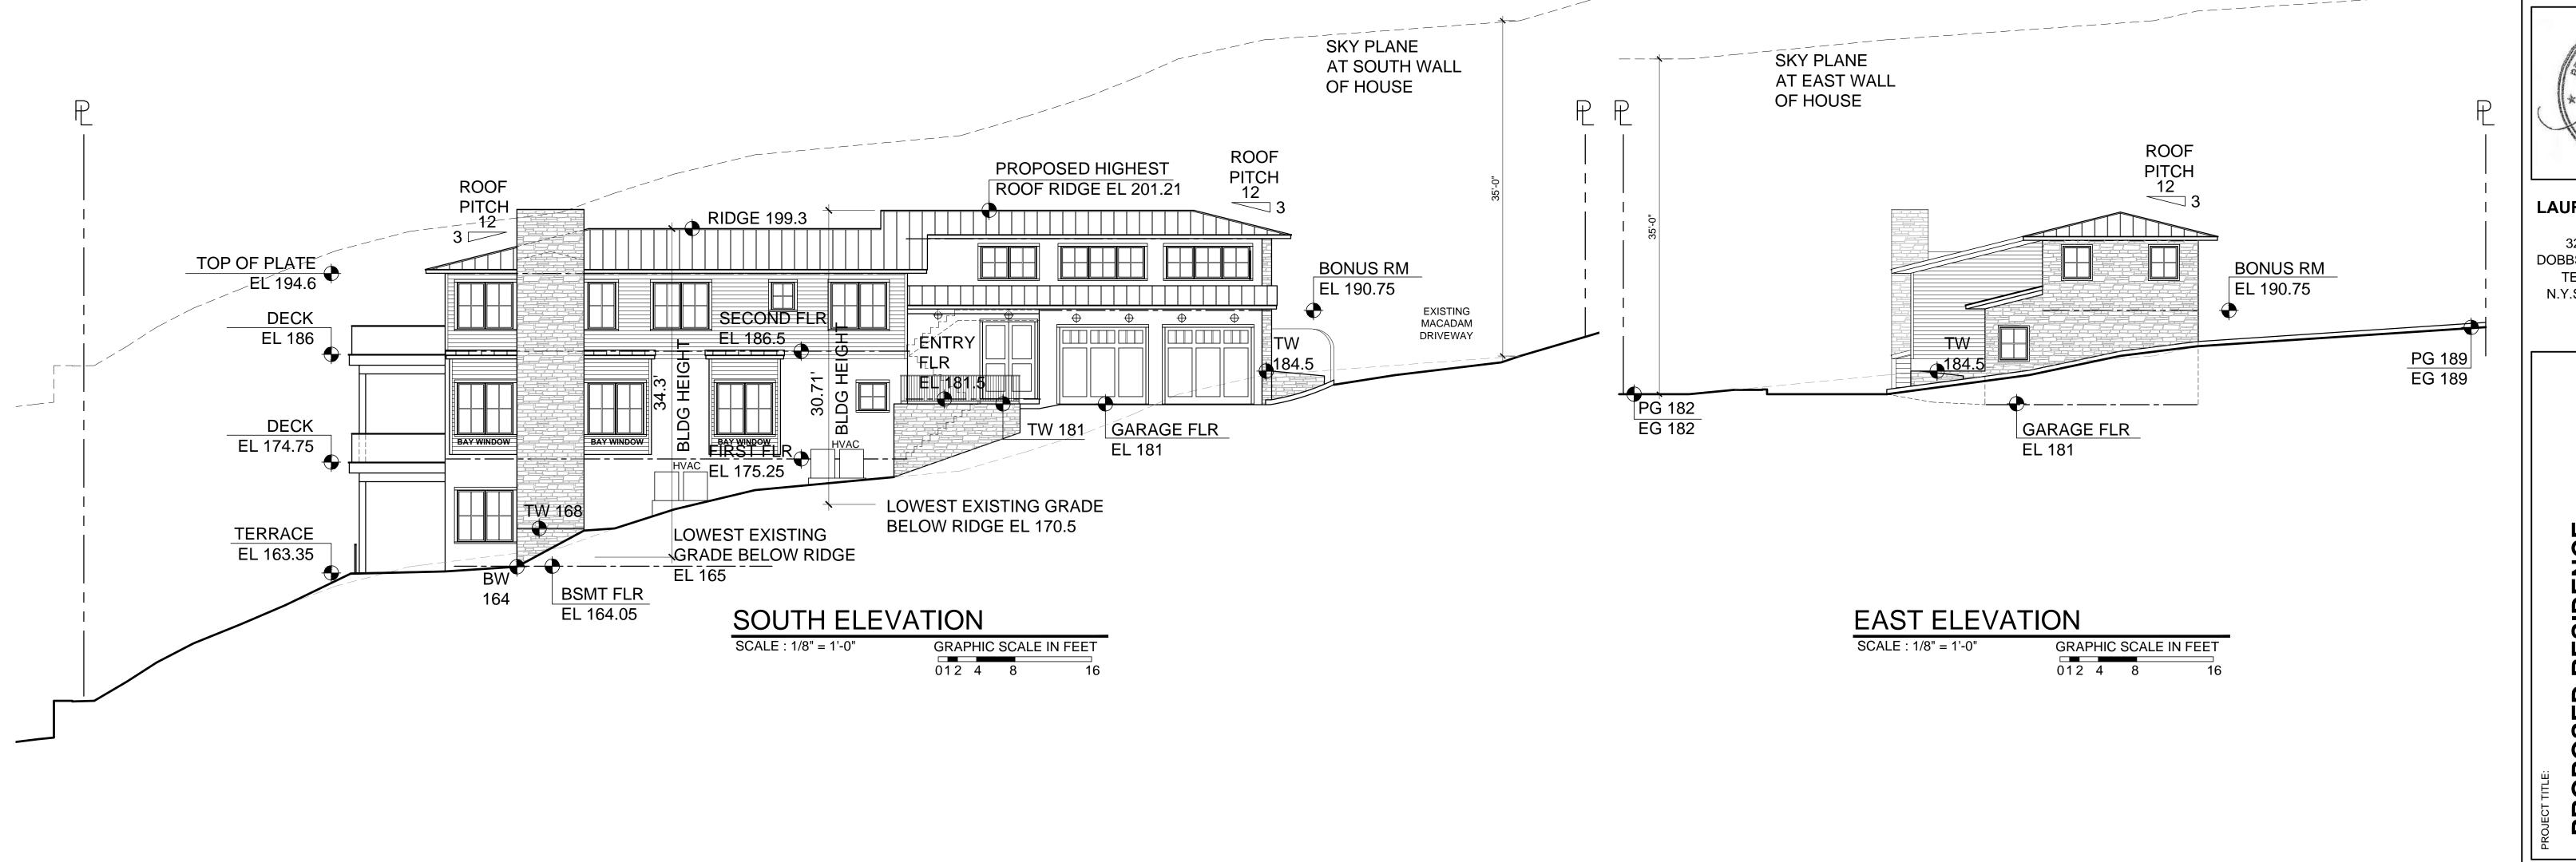

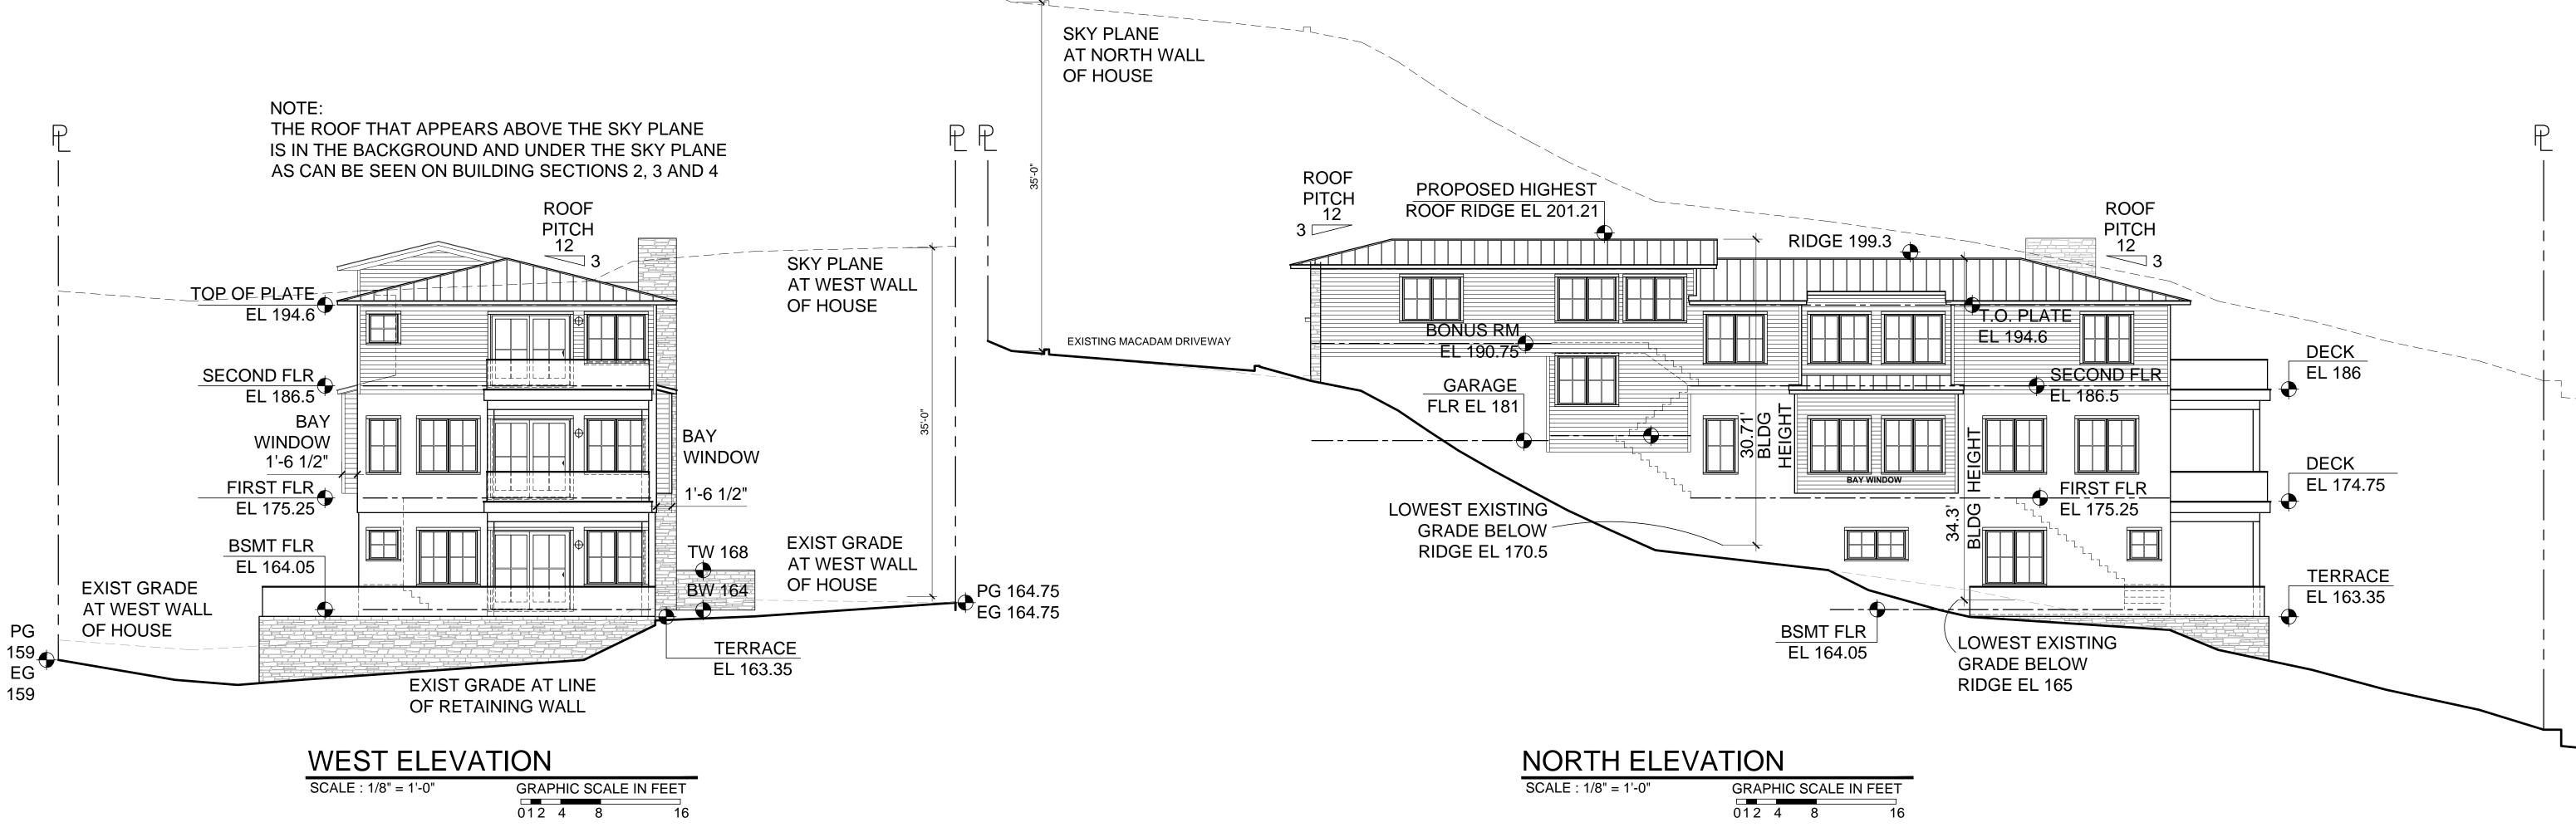

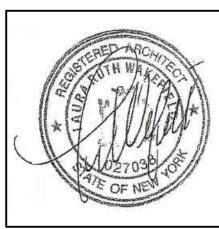

LAURA WAKEFIELD ARCHITECT

ARCHITECT
329 BROADWAY
DOBBS FERRY, NY 10522
TEL: 914 693 6165
N.Y.S STATE LICENSE
No. 27038

PROPOSED RESIDENCE

0 PINECREST PARKWAY

HASTINGS-ON-HUDSON, NEW YORK 10706

GOTHAM DESIGN

AND COMMUNITY DEVELOPMENT LTD.

329 Broadway Dobbs Ferry, N.Y. 10522 Phone: (914) 693-5093 Fax: (914) 693-5390

email: arch329@gmail.com

ISSUED / REVISIONS
SUBMITTED TO 03-05-2020
PLANNING BOARD AND
ZONING BOARD

REVISED 03-19-2020
ADDED SIDING
ADDED INFORMATION
ADDED RET'G WALL AT GARAGE
ON SOUTH & EAST ELEVATIONS
ADDED EXTERIOR LIGHTS
ADDED HVAC EQUIPT


REVISED 04-22-2020 LOWERED HEIGHT OF BUILDING ADDED SIDING

REVISED 04-30-2020 COORDINATED DRAWINGS WITH HUDSON ENGINEERING

ELEVATIONS

DATE:	DRAWN BY:
03-05-2020	MB
SCALE:	CHECKED BY:


SP-3

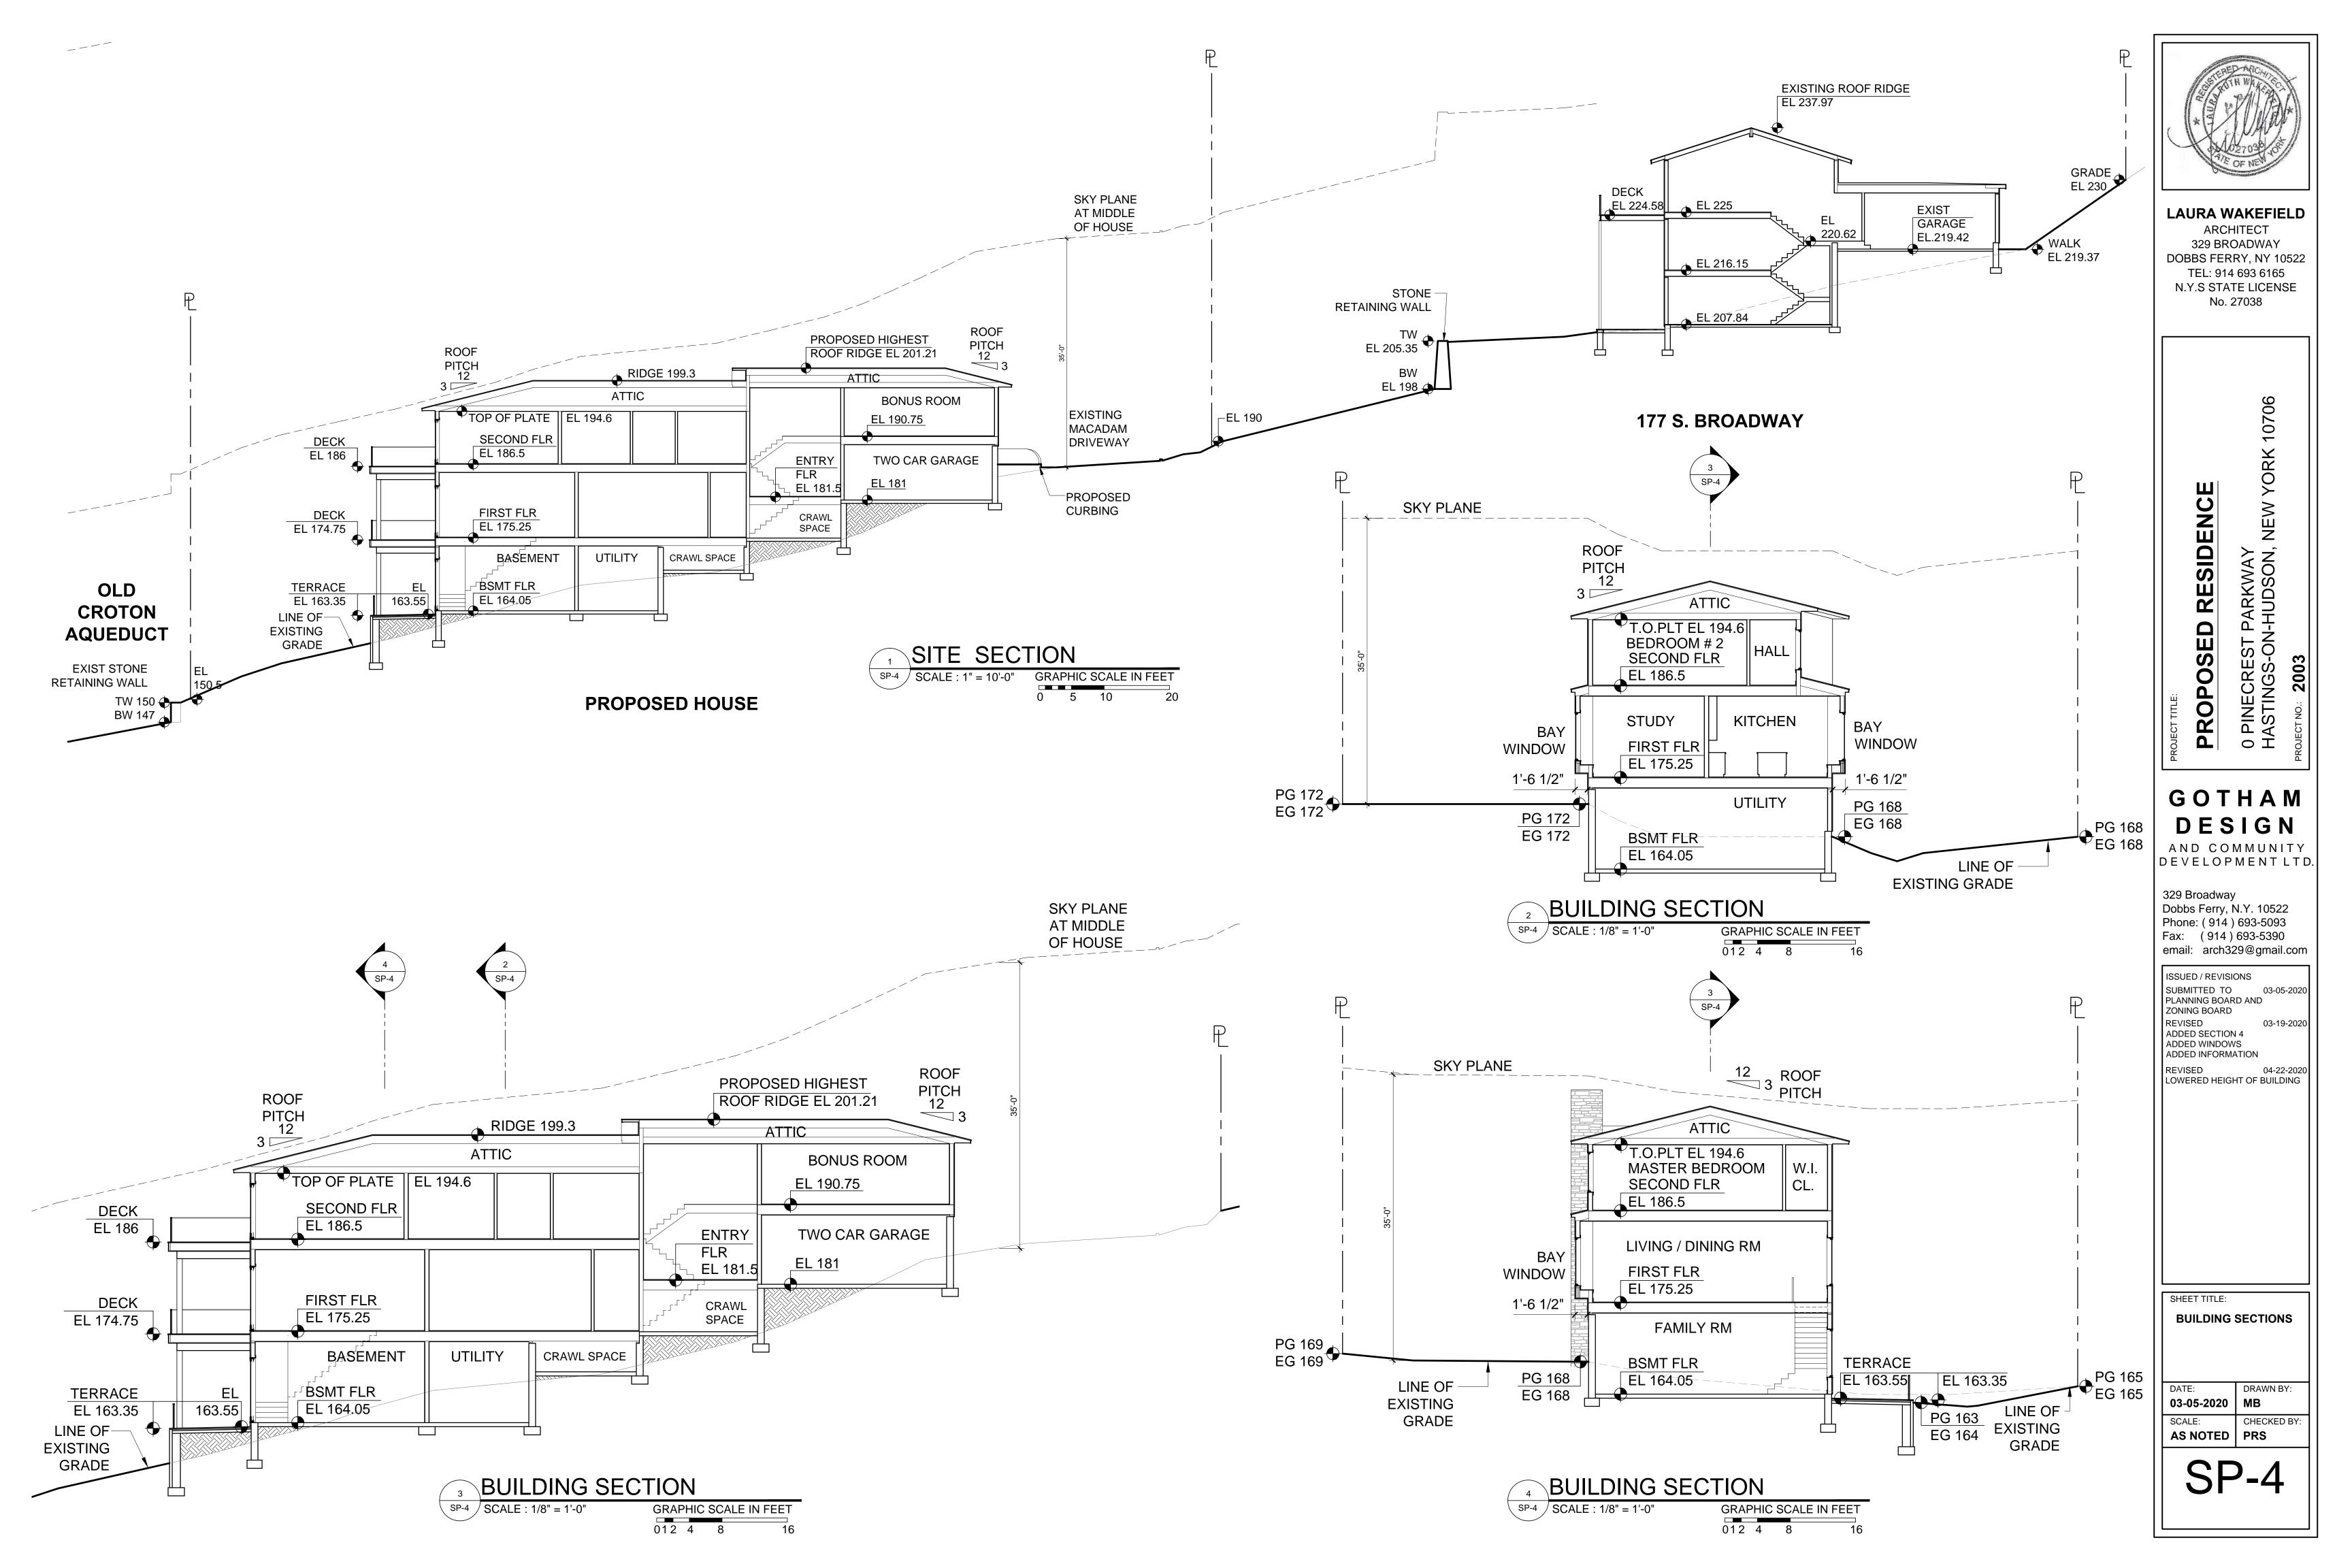


KIMBERRESIDENCE

PINECREST PARKWAY

HASTINGS - ON - HUDSO N, N. Y. 10706

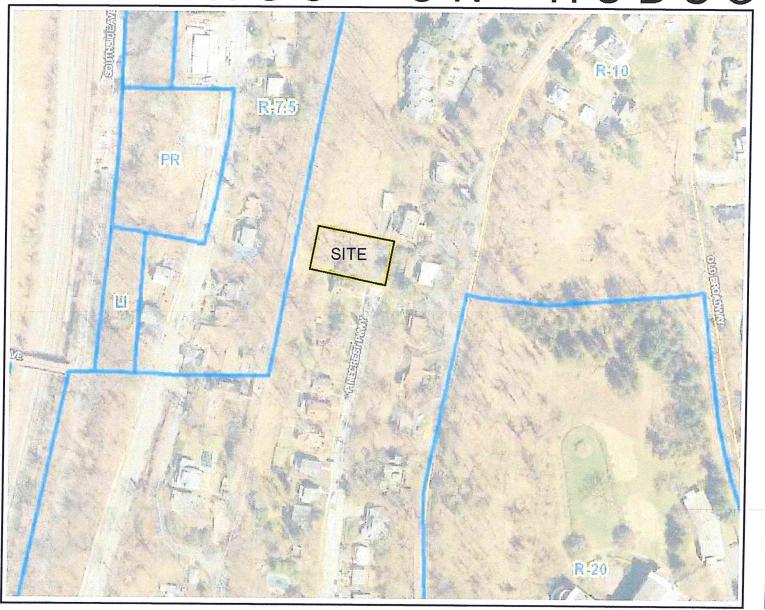

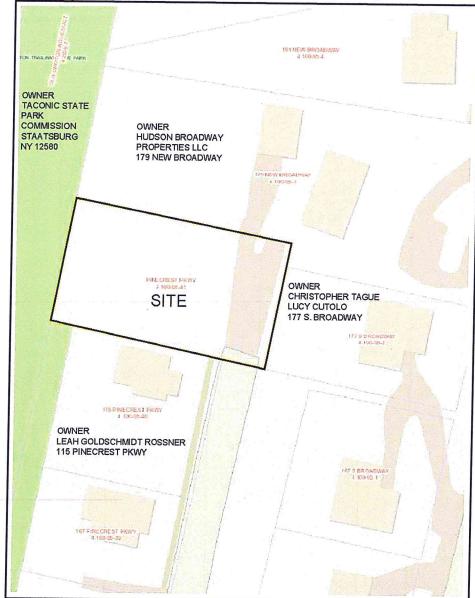





RESIDENCE

HASTINGS-ON-HUDSON PINECREST PARKWAY 10706

GOTHAM DESIGN

AND COMMUNITY DEVELOPMENT LTD.

329 Broadway Dobbs Ferry, N.Y. 10522 Phone: (914) 693-5093 Fax: (914) 693-5390 email: arch329@gmail.com

ISSUED / REVISIONS SUBMITTED TO 1 PLANNING BOARD AND 12-19-2019 **ZONING BOARD**

SHEET TITLE:

VIEW PRESERVATION STUDY

12-19-2019 | AS NOTED

SCALE:

COVER SHEET



KIMBER RESIDENCE PINECREST PARKWAY HASTINGS-ON-HUDSON, NEW YORK 10706 PROJECT NO: 1906

GOTHAM DESIGN

PROJECT TITLE:

AND COMMUNITY DEVELOPMENT LTD.

329 Broadway
Dobbs Ferry, N.Y. 10522
Phone: (914) 693-5093
Fax: (914) 693-5390
email: arch329@gmail.com

ISSUED / REVISIONS SUBMITTED TO 12-19-2019 PLANNING BOARD AND ZONING BOARD

SHEET TITLE:

VIEW PRESERVATION
STUDY

DATE: SCALE:
12-19-2019 AS NOTED

VP-1

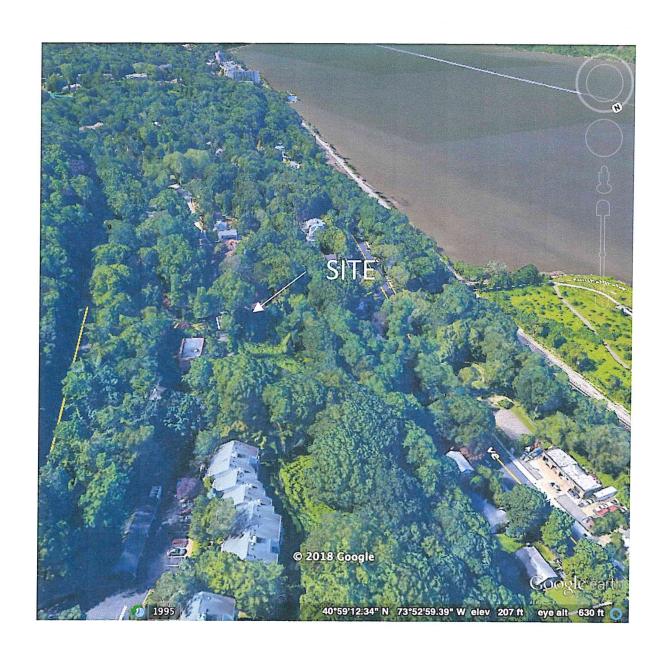


Photo 1 – Ariel View of Site from North

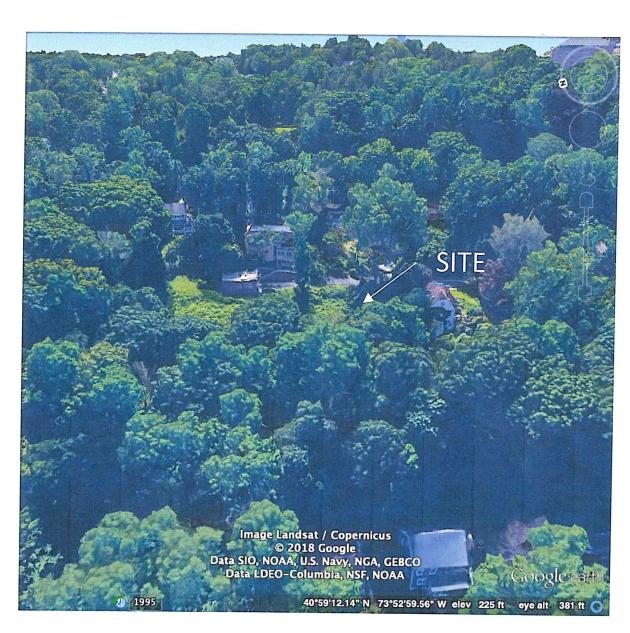


Photo 2 – Ariel View of Site from West

PINECREST PARKWAY

GOTHAM DESIGN

AND COMMUNITY DEVELOPMENT LTD.

329 Broadway Dobbs Ferry, N.Y. 10522 Phone: (914) 693-5093 Fax: (914) 693-5390 email: arch329@gmail.com

ISSUED / REVISIONS SUBMITTED TO PLANNING BOARD AND ZONING BOARD 12-19-2019

SHEET TITLE:

VIEW PRESERVATION STUDY

DATE:

SCALE: 12-19-2019 | AS NOTED

Photo 3 – Context Panoramic from South





Photo 5 – Context Panoramic from North

Photo 4 – Context Panoramic from West





Photo 6 – Context Panoramic from East

ESIDENCE

PARKWAY NN-HUDSON,

GOTHAM DESIGN

AND COMMUNITY DEVELOPMENT LTD.

329 Broadway Dobbs Ferry, N.Y. 10522 Phone: (914) 693-5093 Fax: (914) 693-5390 email: arch329@gmail.com


ISSUED / REVISIONS SUBMITTED TO PLANNING BOARD AND ZONING BOARD 12-19-2019

SHEET TITLE:

VIEW PRESERVATION STUDY

DATE: 12-19-2019 | AS NOTED

SCALE:

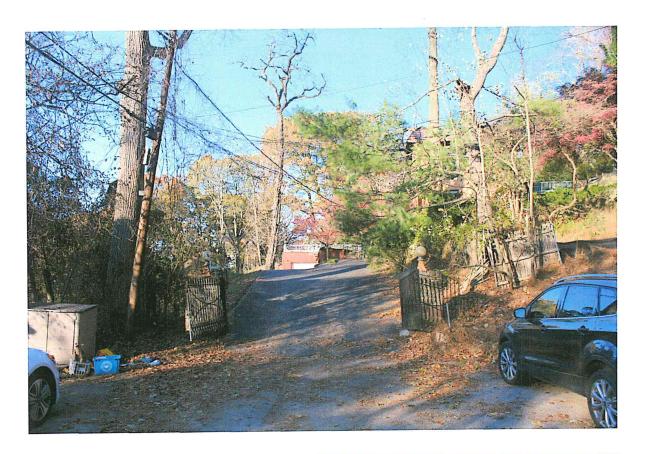

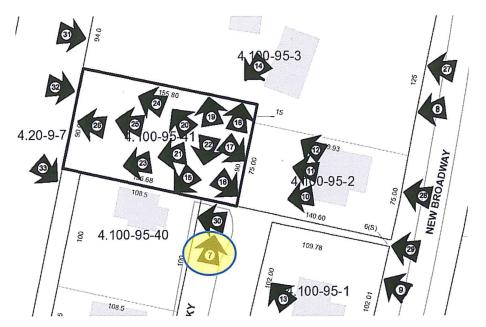


Photo 7
View from Pinecrest
Before

Photo 7
View from Pinecrest
After

The driveway to 179 Broadway in the easement that traverses the subject property dominates the view of the site from Pinecrest Parkway. The proposed house has been positioned so that the primary volume aligns with the other houses along the west side of the Parkway respecting the context of the street. Trees are proposed to be planted to the east of the proposed house to screen the house from the street. The proposed house becomes part of the view from the Parkway, but it does not adversely affect public views to the River.

KIMBER RESIDENCE PINECREST PARKWAY HASTINGS-ON-HUDSON, NEW YORK 10706 PROJECT NO: 1906

GOTHAM DESIGN

AND COMMUNITY DEVELOPMENT LTD

329 Broadway
Dobbs Ferry, N.Y. 10522
Phone: (914) 693-5093
Fax: (914) 693-5390
email: arch329@gmail.com

ISSUED / REVISIONS
SUBMITTED TO 12-19-2019
PLANNING BOARD AND
ZONING BOARD

SHEET TITLE:

VIEW PRESERVATION
STUDY

DATE: SCALE:
12-19-2019 AS NOTED

VP-4





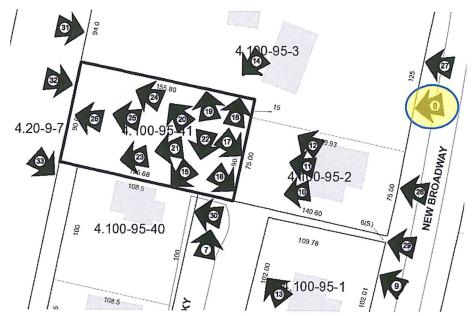


Photo 8
View from Broadway
Before

The view of the site between these two houses on Broadway is limited and substantially screened by existing plantings. These plantings will be augmented by plantings proposed on the subject property. The height of the house is such that it is below the eye level view to the River and does not adversely affect that view. affect public views to the River.

Photo 8
View from Broadway
After

KIMBER RESIDENCE PINECREST PARKWAY HASTINGS-ON-HUDSON, NEW YORK 10706 PROJECT NO: 1906

GOTHAM DESIGN

AND COMMUNITY DEVELOPMENT LTD.

329 Broadway
Dobbs Ferry, N.Y. 10522
Phone: (914) 693-5093
Fax: (914) 693-5390
email: arch329@gmail.com


ISSUED / REVISIONS
SUBMITTED TO 12-19-2019
PLANNING BOARD AND
ZONING BOARD

SHEET TITLE:

VIEW PRESERVATION
STUDY

DATE: SCALE:
12-19-2019 AS NOTED

VP - 5

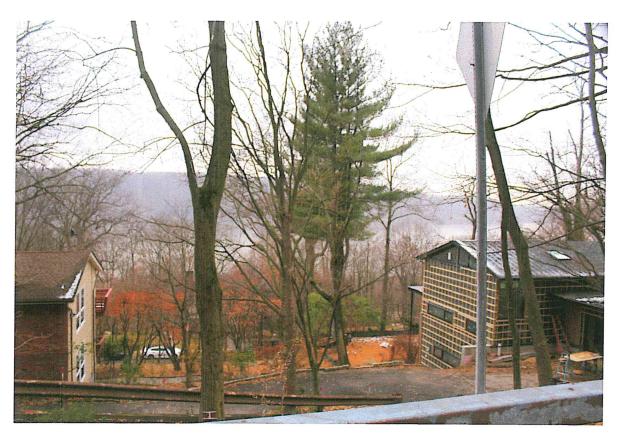



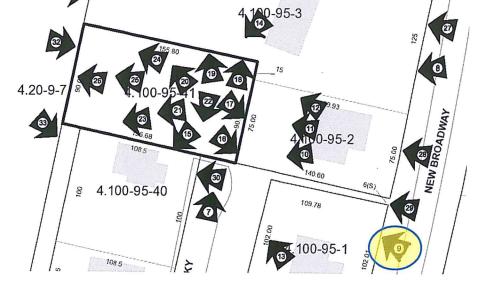


Photo 9
View from Pinecrest
Before

Similar to View 8, the view of the site between these two houses on Broadway is also limited and substantially screened by existing plantings. These plantings will be augmented by plantings proposed on the subject property. The height of the house positions the ridge below the tree line along the Aqueduct to the west of the site. The ridge of the proposed house is at elevation 209.29, whereas the basement elevation of 177 Broadway is 207.84. While the proposed house will be visible from 177 Broadway, it will block views of the trees on the subject property and not of the River.

Photo 9
View from Pinecrest
After

KIMBER RESIDENCE PINECREST PARKWAY HASTINGS-ON-HUDSON, NEW YORK 10706

GOTHAM DESIGN

AND COMMUNITY DEVELOPMENT LTD.

329 Broadway
Dobbs Ferry, N.Y. 10522
Phone: (914) 693-5093
Fax: (914) 693-5390
email: arch329@gmail.com


ISSUED / REVISIONS SUBMITTED TO 12-19-2019 PLANNING BOARD AND ZONING BOARD

SHEET TITLE:

VIEW PRESERVATION
STUDY

DATE: SCALE:
12-19-2019 AS NOTED

VP - 6

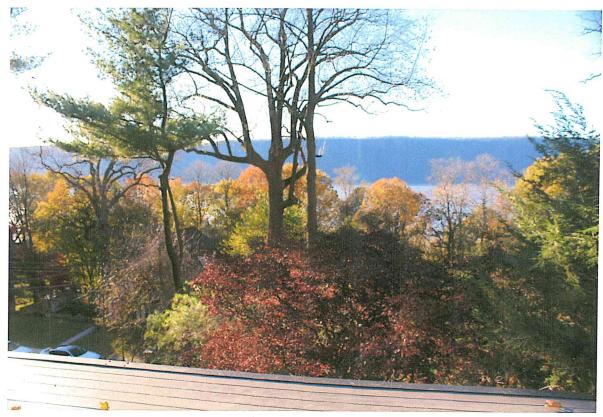




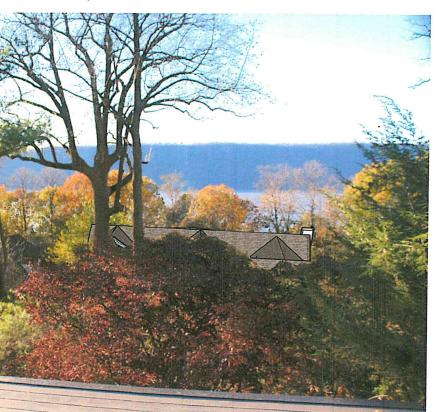


Photo 10
View from 177
Looking Southwest
After

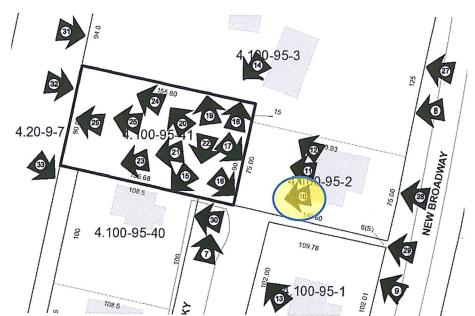

GOTHAM
DESIGN
AND COMMUNITY
DEVELOPMENT LTD

SIDENCE

PARKWAY

329 Broadway
Dobbs Ferry, N.Y. 10522
Phone: (914) 693-5093
Fax: (914) 693-5390
email: arch329@gmail.com

ISSUED / REVISIONS SUBMITTED TO 12-19-2019 PLANNING BOARD AND ZONING BOARD

SHEET TITLE:

VIEW PRESERVATION
STUDY

DATE: SCALE:
12-19-2019 AS NOTED

VP-7

The house located at 177 Broadway is on the steep
That starts at Broadway and continues down to the
Aqueduct. The proposed house will be built on-line
between 177 and the view to the River. The steep
slope factors into preventing the view being blocked.
The first floor of the proposed house is at elevation
182.4, whereas the first floor of 177 Broadway is at
elevation 216.15, a difference of 33.75 feet. Perhaps
more indicative of the significance is that the ridge
of the proposed house is less than 2 feet higher than
the elevations of the 177 basement floor. The proposed
house will not block any views of the Hudson River for


the residents at 177.



Photo 11 View from 177 Looking West Before



Photo 11 View from 177 Looking West After

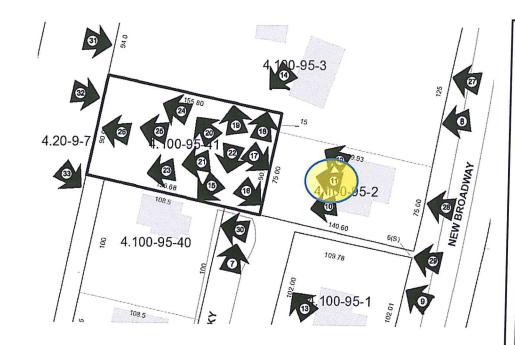

This photo shows the view towards the subject parcel at the 177 basement level. In addition to the significant difference in elevation height between the two homes, it should also be noted that the existing planting also screens the view towards the river. The construction of the proposed house will require several existing trees on the subject property to be removed. This will open up views for the existing houses to the east of the proposed. New trees are proposed, but they have specifically been selected to be the type that will top out at around 35 feet, obviating blocking views to the River.

KIMBER RESIDENCE PINECREST PARKWAY HASTINGS-ON-HUDSON, JEW YORK 10706 ROJECTNO: 1906

GOTHAM DESIGN

AND COMMUNITY DEVELOPMENT LTD.

329 Broadway
Dobbs Ferry, N.Y. 10522
Phone: (914) 693-5093
Fax: (914) 693-5390
email: arch329@gmail.com


ISSUED / REVISIONS
SUBMITTED TO 12-19-20
PLANNING BOARD AND
ZONING BOARD

SHEET TITLE:

VIEW PRESERVATION
STUDY

DATE: SCALE:
12-19-2019 AS NOTED

VP - 8

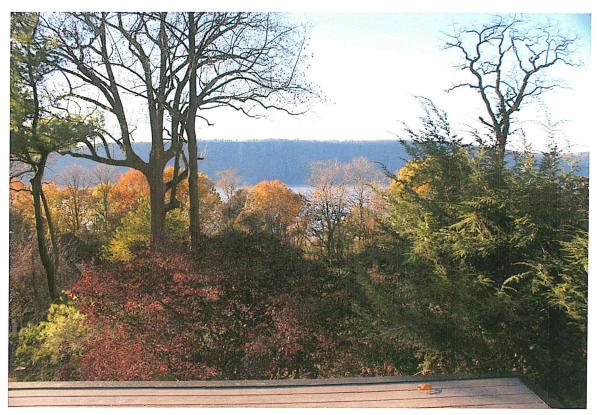

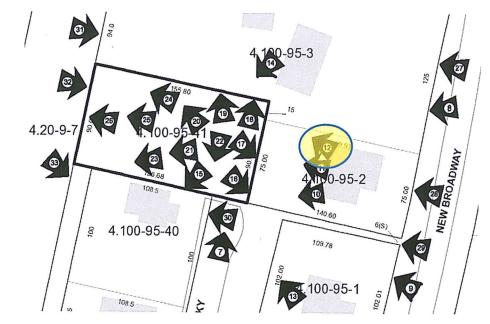


Photo 12 View from 177 Looking Northwest Before

This is the view from the upper deck at 177 Broadway facing west towards the River. The elevation of this deck is at 225 feet, which is almost 16 feet above the ridge of the proposed house. Note that the successive rows of trees between this house and the River creates extensive screening to the view of the River. The row of trees along the Aqueduct forms a backdrop to the proposed house with the canopy of the trees above the height of the house.

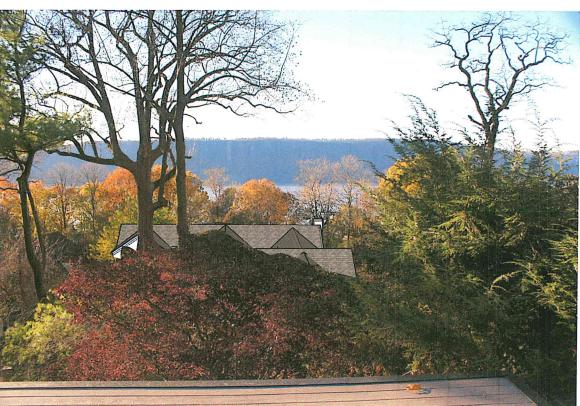


Photo 12 View from 177 Looking Northwest After

KIMBER RESIDENCE PINECREST PARKWAY HASTINGS-ON-HUDSON, NEW YORK 10706

GOTHAM DESIGN

AND COMMUNITY DEVELOPMENT LTD.

329 Broadway
Dobbs Ferry, N.Y. 10522
Phone: (914) 693-5093
Fax: (914) 693-5390
email: arch329@gmail.com

ISSUED / REVISIONS
SUBMITTED TO 12-19-2019
PLANNING BOARD AND
ZONING BOARD

	SHEET TITLE:	
	VIEW PRES	
ı	DATE:	SCALE:
	12-19-2019	AS NOTED

VP-9



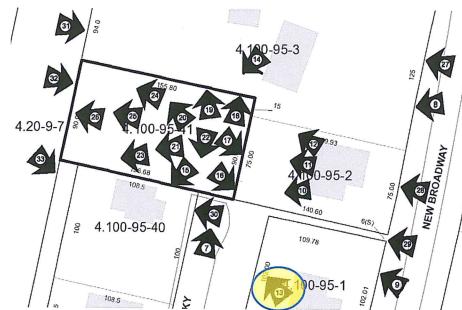


Photo 13
View from 167 Deck
Looking Northwest
Before

This is the view from the deck at 167 Broadway looking across the site to the Northwest towards the River. 179 has a fabulous direct view to the River looking West between the houses on Pinecrest Parkway. Note the existing house at 115 Pinecrest. The proposed House effectively aligns with 115 and the ridge elevation of the proposed house is approximately 6 feet higher then the ridge elevation of 115. 167 is built on the slope up to Broadway, placing it significantly higher that the proposed house.



Photo 13
View from 167 Deck
Looking Northwest
After

KIMBER RESIDENC PINECREST PARKWAY HASTINGS-ON-HUDSON, NEW YORK 10706

GOTHAM DESIGN

AND COMMUNITY DEVELOPMENT LTD.

329 Broadway
Dobbs Ferry, N.Y. 10522
Phone: (914) 693-5093
Fax: (914) 693-5390
email: arch329@gmail.com


ISSUED / REVISIONS
SUBMITTED TO 12-19-2019
PLANNING BOARD AND
ZONING BOARD

SHEET TITLE:	
VIEW PRES	
DATE:	SCALE:
12-19-2019	AS NOTED

VP - 10



Photo 14
View from 167 Deck
Looking Northwest
Before

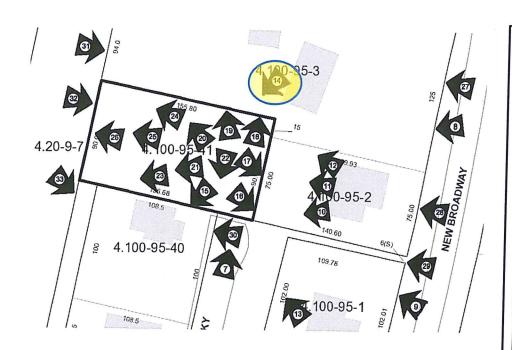

This is the view from the deck at 179 Broadway looking Across the site to the Southwest towards the River. 179 has a fabulous direct view to the River looking West.



Photo 14
View from 167 Deck
Looking Northwest
After

KIMBER RESIDENCE PINECREST PARKWAY HASTINGS-ON-HUDSON, NEW YORK 10706

GOTHAM DESIGN

AND COMMUNITY DEVELOPMENT LTD.

329 Broadway
Dobbs Ferry, N.Y. 10522
Phone: (914) 693-5093
Fax: (914) 693-5390
email: arch329@gmail.com

ISSUED / REVISIONS
SUBMITTED TO 12-19-2019
PLANNING BOARD AND
ZONING BOARD

SHEET TITLE:

VIEW PRESERVATION
STUDY

DATE: SCALE:
12-19-2019 AS NOTED

VP - 11

Photo 15 – View from Site to 115 Pinecrest Parkway





Photo 17 – View from Site to 177 Broadway

Photo 16 – View from Site to 167 Pinecrest Parkway





Photo 18 – View from Site to 179 Broadway

GOTHAM DESIGN

AND COMMUNITY DEVELOPMENT LTD.

329 Broadway Dobbs Ferry, N.Y. 10522 Phone: (914) 693-5093 Fax: (914)693-5390 email: arch329@gmail.com

ISSUED / REVISIONS SUBMITTED TO PLANNING BOARD AND ZONING BOARD

SHEET TITLE:

VIEW PRESERVATION STUDY

SCALE: 12-19-2019 | AS NOTED

Photo 19 - View from Site to the North

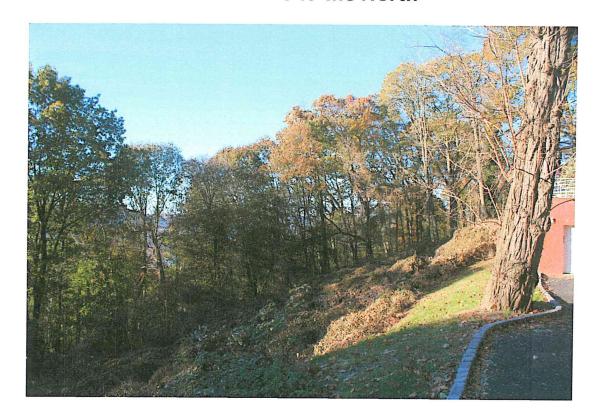




Photo 21 – View from Site to Southwest

Photo 20 – View from Site to Northwest





Photo 22 - View from Site to South

GOTHAM DESIGN

AND COMMUNITY DEVELOPMENT LTD.

329 Broadway Dobbs Ferry, N.Y. 10522 Phone: (914) 693-5093 Fax: (914) 693-5390 email: arch329@gmail.com

ISSUED / REVISIONS SUBMITTED TO PLANNING BOARD AND ZONING BOARD 12-19-2019

SHEET TITLE:

VIEW PRESERVATION STUDY

DATE: 12-19-2019 | AS NOTED

SCALE:

Photo 23 – View from Site to the Southwest



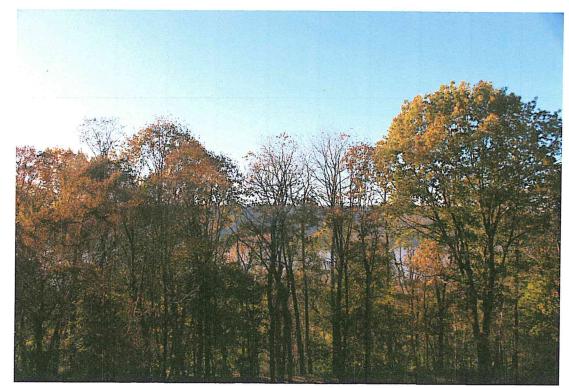


Photo 25 – View from Site to West

Photo 24 – View from Site to Northwest





Photo 26 – View from Site to Aqueduct

GOTHAM DESIGN

AND COMMUNITY DEVELOPMENT LTD.

329 Broadway Dobbs Ferry, N.Y. 10522 Phone: (914) 693-5093 Fax: (914) 693-5390 email: arch329@gmail.com

ISSUED / REVISIONS SUBMITTED TO PLANNING BOARD AND ZONING BOARD 12-19-2019


SHEET TITLE:

VIEW PRESERVATION STUDY

DATE: 12-19-2019 | AS NOTED

SCALE:

Photo 27 – View from Broadway to 179

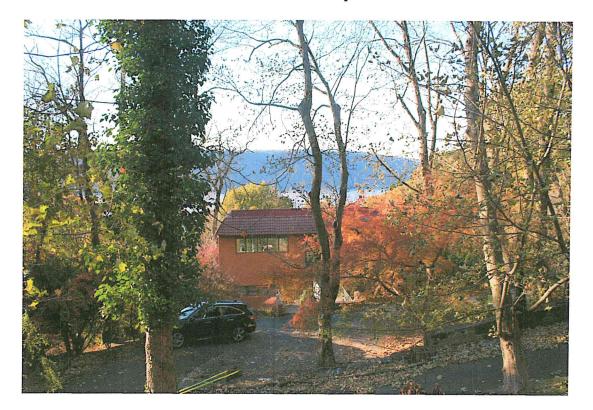

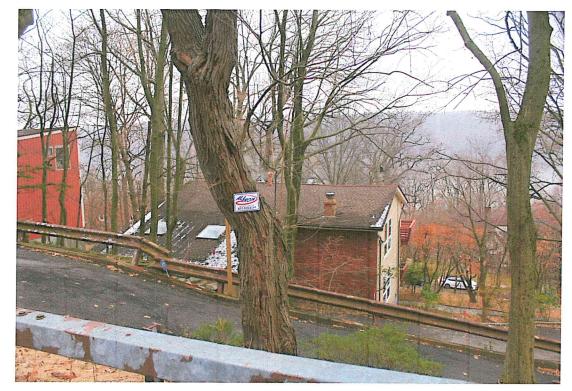


Photo 29 – View from Broadway to 167

Photo 28 – View from Broadway to 177

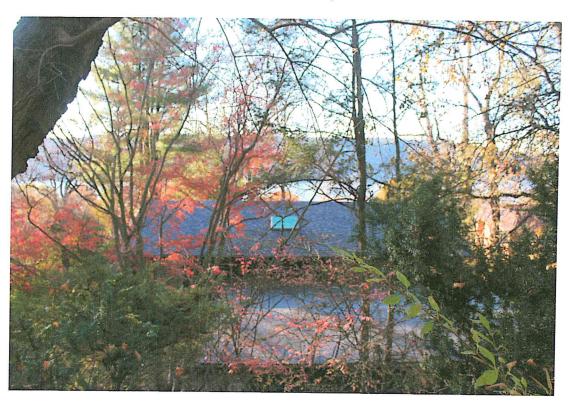




Photo 30 – View from Pinecrest Parkway to 115

ESIDENCE PARKWAY NN-HUDSON,

GOTHAM DESIGN

AND COMMUNITY DEVELOPMENT LTD.

329 Broadway Dobbs Ferry, N.Y. 10522 Phone: (914) 693-5093 Fax: (914)693-5390 email: arch329@gmail.com

ISSUED / REVISIONS SUBMITTED TO PLANNING BOARD AND ZONING BOARD 12-19-2019

SHEET TITLE:

VIEW PRESERVATION STUDY

DATE:

SCALE: 12-19-2019 | AS NOTED

Photo 31 – View of 179 from Aqueduct





Photo 33 – View to 167 from Aqueduct

Photo 32 – View of Site from Aqueduct

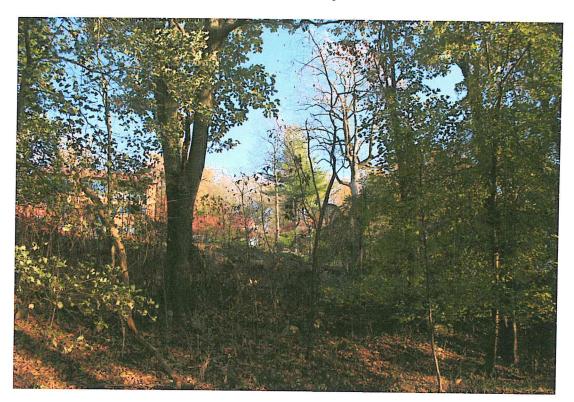




Photo 34 – View of Aqueduct Below Site

GOTHAM DESIGN

AND COMMUNITY DEVELOPMENT LTD.

329 Broadway Dobbs Ferry, N.Y. 10522 Phone: (914) 693-5093 Fax: (914) 693-5390 email: arch329@gmail.com

ISSUED / REVISIONS SUBMITTED TO PLANNING BOARD AND ZONING BOARD 12-19-2019

SHEET TITLE:

VIEW PRESERVATION STUDY


DATE:

SCALE: 12-19-2019 AS NOTED

VP - 16

Hudson River

Aqueduct

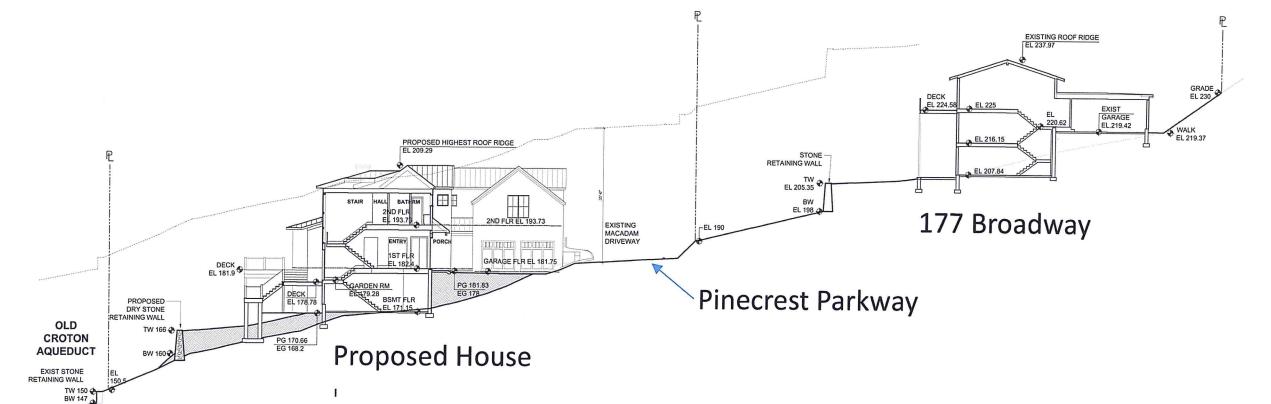

The highest point of the roof of the proposed house is at elevation 209.29, whereas the basement floor of the existing house at 177 Broadway is at elevation 207.84. The first floor of the proposed house has been set at the lowest level practical to be on the same floor level as the garage. Dropping the floor of the proposed house further would increase the slope of the driveway to an unacceptably steep pitch. While effort has been made to keep the proposed house low in the topography, key to the selection of this building lot was the opportunity to enjoy river views. The effort has been to fairly balance the interests of the neighbors and the applicant.

KIMBER RESIDENCE PINECREST PARKWAY HASTINGS-ON-HUDSON, NEW YORK 10706 PROJECT NO: 1906

GOTHAM DESIGN

AND COMMUNITY DEVELOPMENT LTD

329 Broadway
Dobbs Ferry, N.Y. 10522
Phone: (914) 693-5093
Fax: (914) 693-5390
email: arch329@gmail.com

ISSUED / REVISIONS SUBMITTED TO 12-19-2019 PLANNING BOARD AND ZONING BOARD

SHEET TITLE:

VIEW PRESERVATION
STUDY

DATE: SCALE:
12-19-2019 AS NOTED