55 ROSEDALE AVE, HASTINGS ON HUDSON, NY 10706

June 10, 2021

Planning Board Village of Hastings on Hudson 7 Maple Avenue Hastings on Hudson, NY 10706

Members of the Planning Board:

RE: Proposed Alterations at 65 Hillside Avenue (Tax ID 4.80-62-20)

Please find attached revised drawings showing the following minor changes and clarifications that had been requested during our previous May meeting:

- 1. Foundation pier detail for the deck and rear second means of egress.
- 2. Pervious paving detail.
- 3. In lieu of a trench drain and to address the ponding of water at the end of the driveway, we are proposing to replace the entire existing concrete slab with pervious paving.

Please note, the Architectural Review Board reviewed this project during the June 07 meeting and voted to approve this project.


Thank you for your time and consideration of the proposed alterations.


Sincerely,


Adelina Castro, RA

CC: Donna Polizio, Owner

Enclosed: Drawings T-1.0, T-2.0, SP-1.0, A-1.0, A-2.0, and LP-1.0

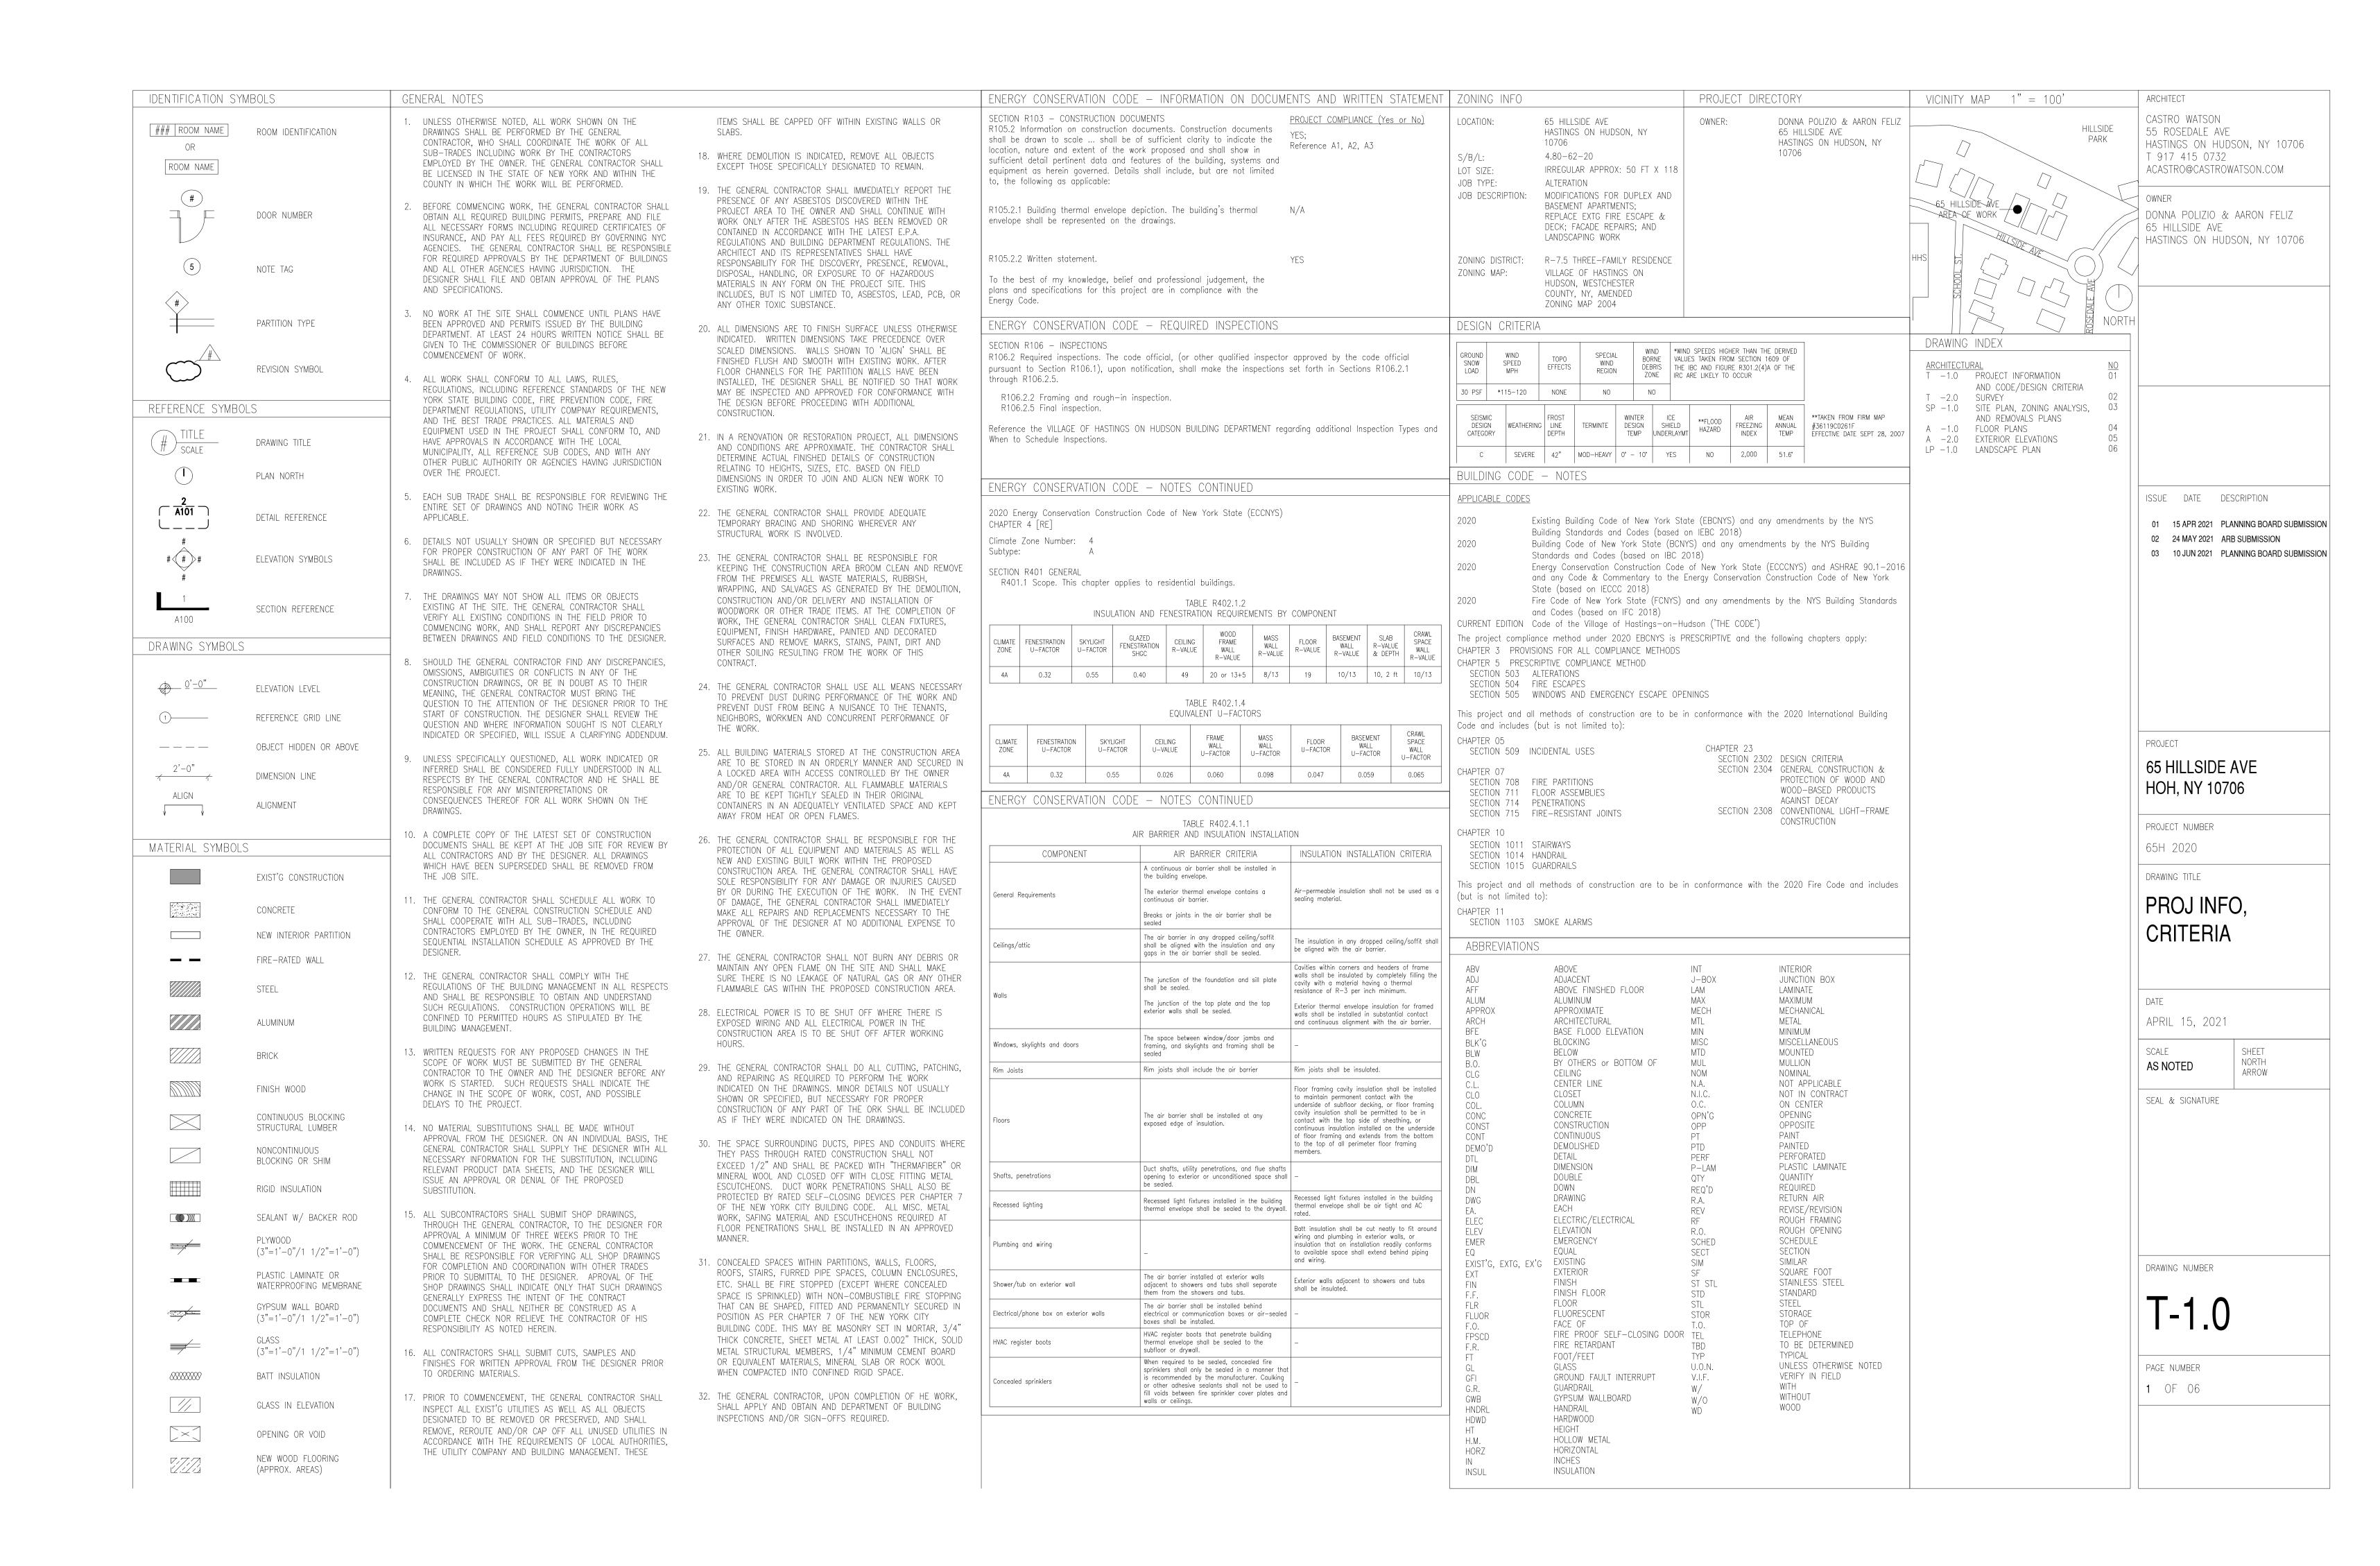

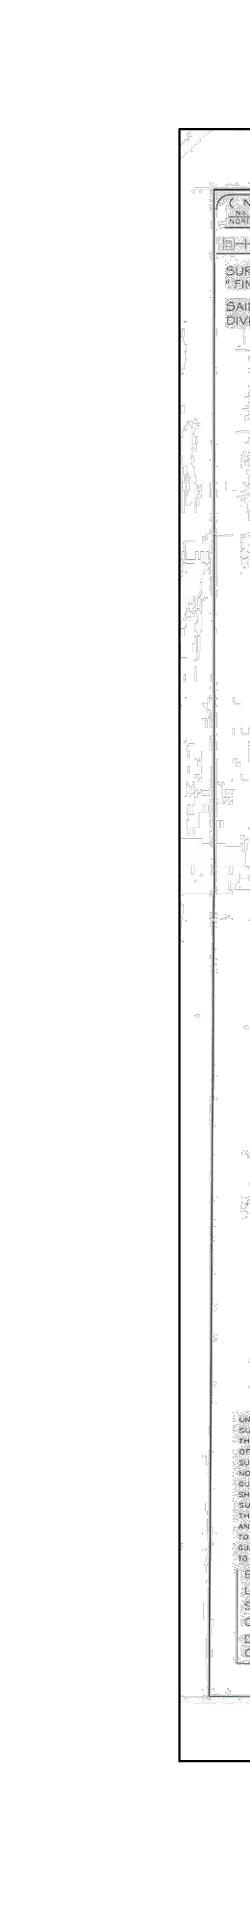

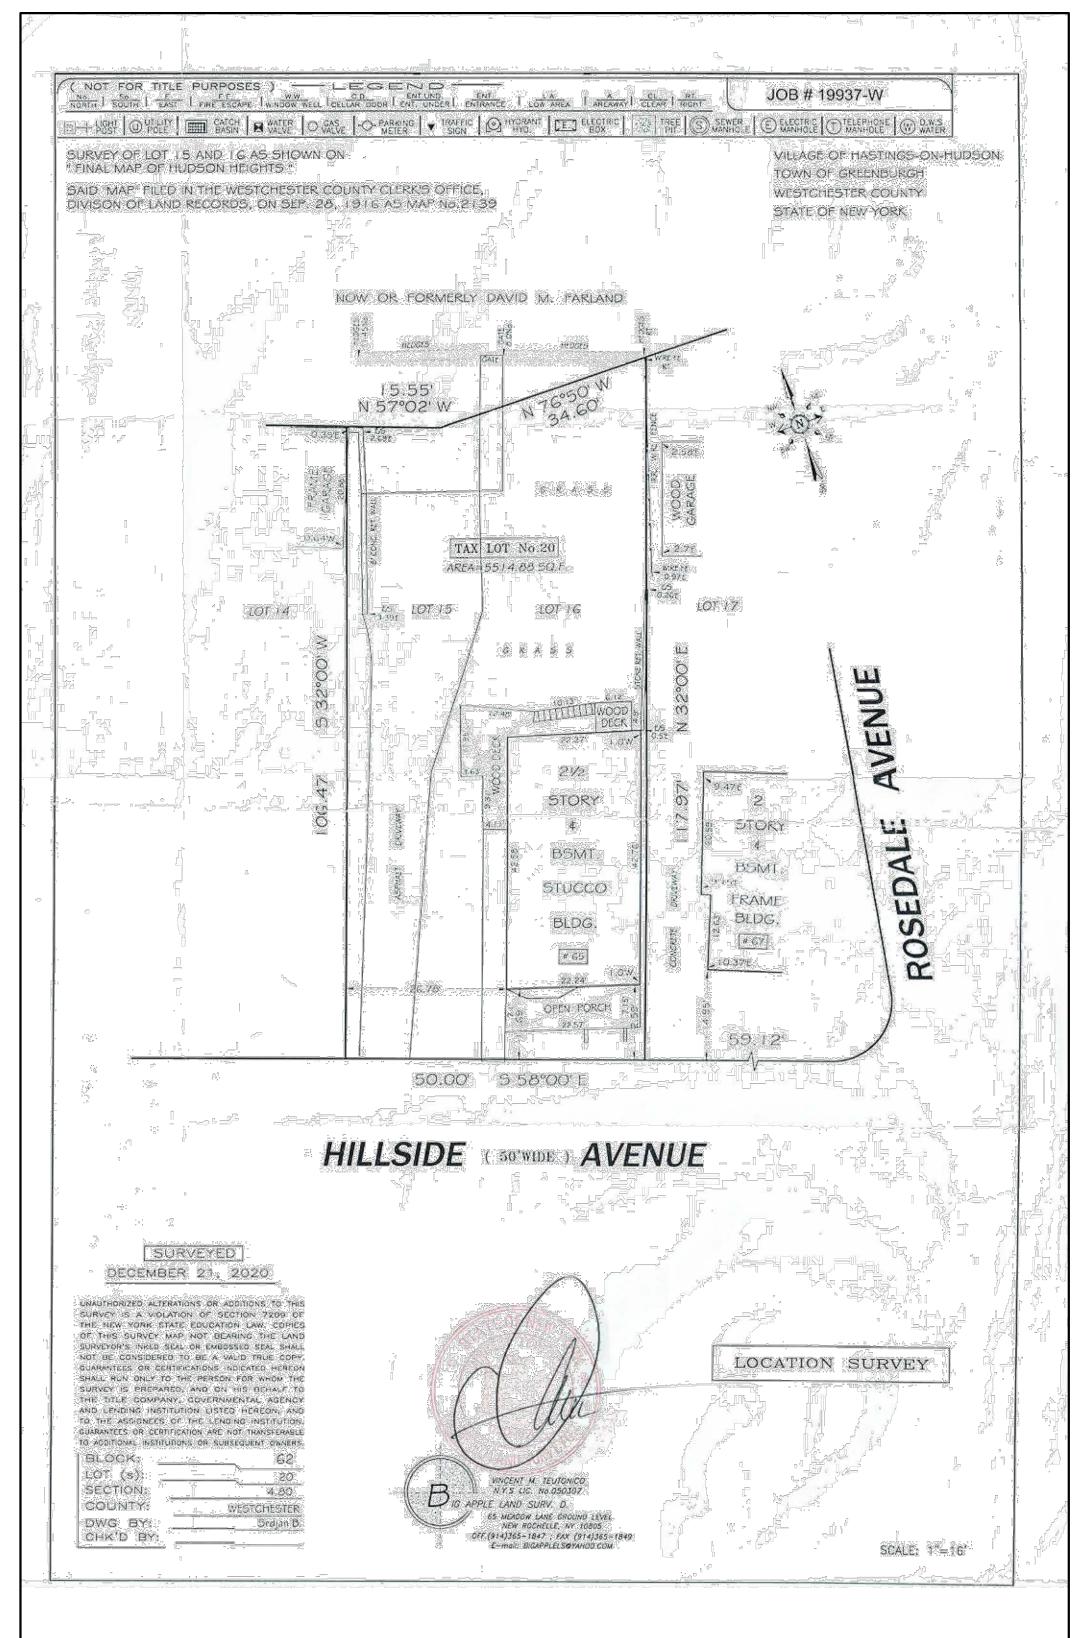

ARCHITECT

CASTRO WATSON 55 ROSEDALE AVE HASTINGS ON HUDSON, NY 10706 T 917 415 0732

ACASTRO@CASTROWATSON.COM

DONNA POLIZIO & AARON FELIZ 65 HILLSIDE AVE HASTINGS ON HUDSON, NY 10706

ISSUE DATE DESCRIPTION

01 15 APR 2021 PLANNING BOARD SUBMISSION 02 24 MAY 2021 ARB SUBMISSION

03 10 JUN 2021 PLANNING BOARD SUBMISSION

PROJECT

65 HILLSIDE AVE HOH, NY 10706

PROJECT NUMBER 65H 2020

DRAWING TITLE

SURVEY

DATE

APRIL 15, 2021

SCALE AS NOTED SHEET NORTH ARROW

SEAL & SIGNATURE

DRAWING NUMBER

T-2.0

PAGE NUMBER

**2** OF 06

REMOVALS LEGEND


---- TO BE REMOVED



## GENERAL REMOVALS NOTES

NORTH

- 1. ALL BUILDING/ STRUCTURAL COMPONENTS [COLUMNS, BEAMS, SLABS, ENVELOPE WINDOWS & DOORS, ETC.] TO REMAIN, UNLESS OTHERWISE NOTED.
- 2. EXISTING FIREPROOFING TO REMAIN AT STRUCTURAL COMPONENTS. 3. CHANNELING OR CORE DRILLING OF BUILDING STRUCTURE IS NOT PERMITTED, UNLESS
- OTHERWISE NOTED. 4. EXISTING GAS, PLUMBING, ELECTRICAL LINE VOLTAGE, COMMUNICATION LOW VOLTAGE
- RISERS ARE NOT TO BE TOUCHED OR DISTURBED IN ANY WAY, UNLESS OTHERWISE
- 4. EXISTING RADIATORS, HEATING, AND AIR CONDITIONING AND ASSOCIATED PIPING ARE NOT

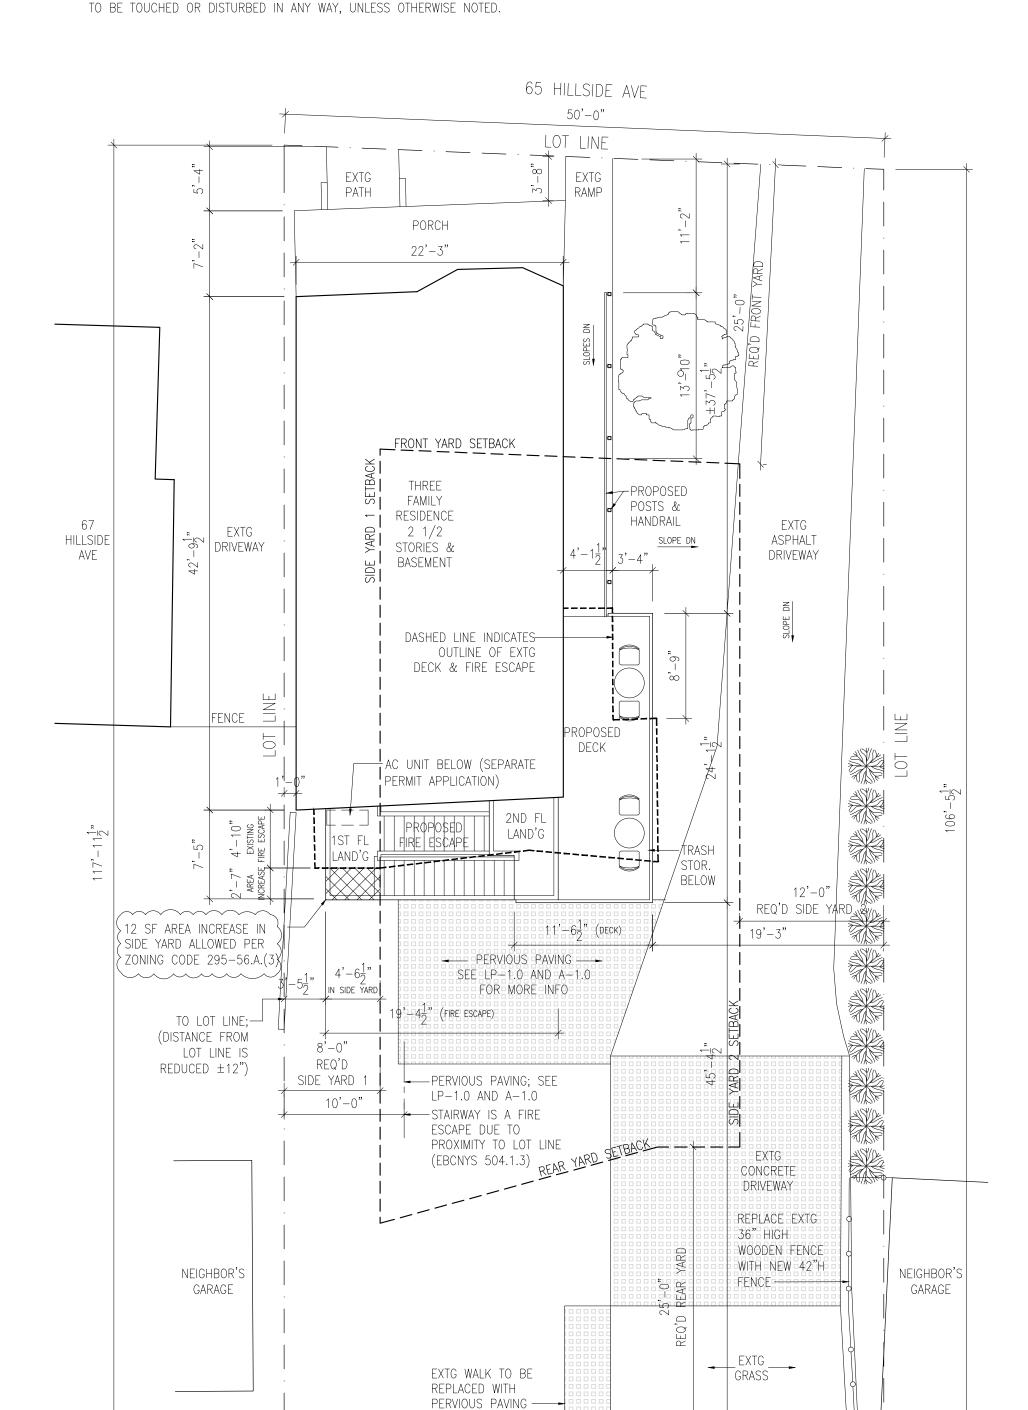

15'-6"

KEY PLAN	ZONING ANALYSIS	THREE-FAMILY	ZONE R-7.5 TA	X PARCEL (SECTION	N/BLOCK/LOT): 4.80-62-2
HILLSIDE PARK					
(V5) / / ×	REQUIRED YARDS	CODE CITATION	REQUIRED	EXISTING	PROPOSED
V3) NORTH	MINIMUM LOT WIDTH	295-69.E	75 FT	50 FT	50 FT
	LOT AREA	295-69.E	7,500 SF	5,515 SF	5,515 SF
HILLSIDE AVE	FRONT YARD	295-69.F(1)(a)	25 FT	3.7 FT	3.7 FT
	REAR YARD	295-69.F(1)(b)	25 FT	47.7 FT	45.4 FT
HILLSIDE AVE	SUM SIDE YARDS	295-69.F(1)(c)	20 FT	20 FT	20.25 FT
SIDE AVE	SIDE YARD 1	295-69.F(1)(c)	8 FT	1 FT	1 FT
	SIDE YARD 2	295-69.F(1)(c)	12 FT	19 FT	19.25 FT
	HEIGHT	295-69.F(1)(d)	2.5 STORIES FT	35 FT	35 FT
			35 FT	avg.	avg.



VIEW 1: HILLSIDE AVE (TOWARDS CHEMKA POOL)

EXTG

EXTG FIRE

ESCAPE

16'-2"

EXTERIORS REMOVALS PLAN 1/8"=1'-0"

PORCH

DECK

12'-5<u>1</u>"



COMPLIANT

NO

YES

NOTES

NO CHANGE

NO CHANGE

NO CHANGE

DECREASE

NO CHANGE

NO CHANGE

NO CHANGE

NO CHANGE

VIEW 2: WEST FACADE FROM HILLSIDE AVE

—OUTLINE OF EXISTING

-REMOVE EXISTING HANDRAIL

-EXISTING CONCRETE

WALK TO REMAIN

——EDGE OF EXTG

ASPHALT DRIVEWAY

-REMOVE EXTG LOW

—PORCH: REMOVE EXTG

-REMOVE ENTIRE EXTG

MASONRY RUBBLE BELOW

WOOD DECK AND

-REMOVE ENTIRE EXISTING WOOD FIRE

ESCAPE

SUBSTRATE, AND JOISTS

STONE PLANTER

FLOOR FINISH,

GUARDRAIL

-REMOVE EXISTING

BUILDING




TOTAL BLDG & STRUCTURES

VIEW 3: EXTG FIRE ESCAPE/DECK




VIEW 6: FRONT FACADE

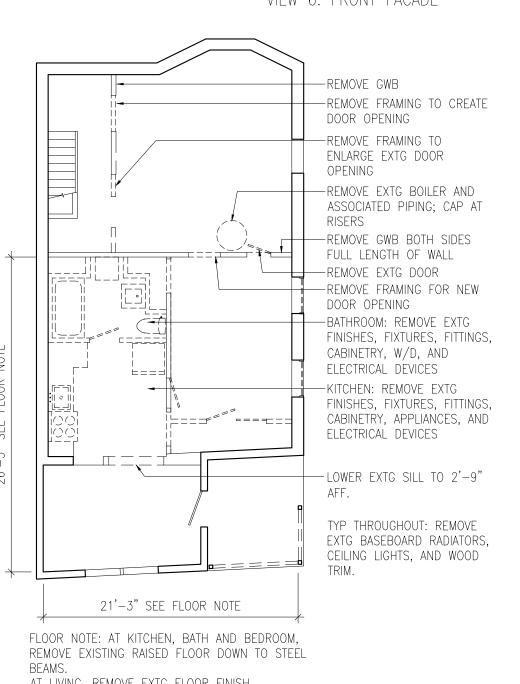

AT LIVING, REMOVE EXTG FLOOR FINISH, SUBSTRATE, JOISTS, AND INSULATION.



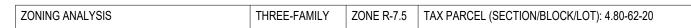

CODE CITATION | ALLOWED

MAX. BUILDING & STRUCTURES (OTHER USE)	295-69.F(2)(b)	30 %	28	%	30	%	YES	2% INCREASE
BLDG & STRUCTURES CALCS		ALLOWED	EXISTING		PROPOSED			
BUILDING FOOTPRINT			965	SF	965	SF		
COVERED PORCH			159	SF	159	SF		
DECK			141	SF	182	SF		
FIRE ESCAPE			86	SF	156	SF		
RETAINING WALLS			38	SF	38	SF		

1,655 SF

EXISTING

1,543 SF

PROPOSED

154 SF

1,654 SF


COMPLAINT

NOTES





VIEW 5: FROM #63 HILLSIDE AVE REAR YARD

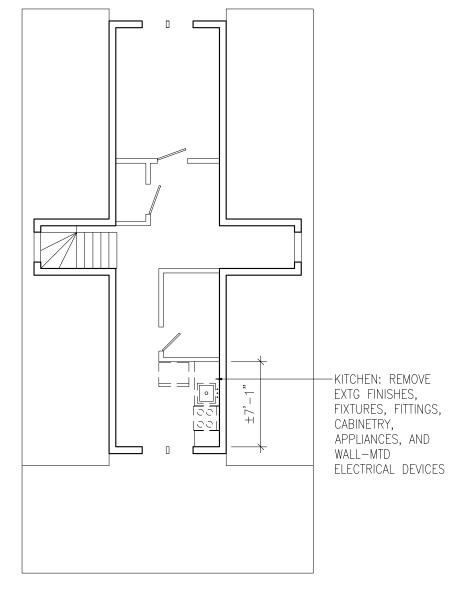

4 ATTIC REMOVALS PLAN
1/8"=1'-0"

ARCHITECT

CASTRO WATSON 55 ROSEDALE AVE HASTINGS ON HUDSON, NY 10706 T 917 415 0732 ACASTRO@CASTROWATSON.COM

DONNA POLIZIO & AARON FELIZ 65 HILLSIDE AVE HASTINGS ON HUDSON, NY 10706

ISSUE DATE DESCRIPTION

01 01 MAR 2021 ISSUED FOR OWNER REVIEW 02 15 APR 2021 PLANNING BOARD SUBMISSION

03 24 MAY 2021 ARB SUBMISSION 04 10 JUN 2021 PLANNING BOARD SUBMISSION REVISION 1

PROJECT

65 HILLSIDE AVE HOH, NY 10706

PROJECT NUMBER 65H 2020

DRAWING TITLE

SITEPLAN, ZONING TABLES, & REMOVAL PLANS

APRIL 15, 2021 SCALE


SHEET NORTH ARROW 1/8" = 1'-0"

SEAL & SIGNATURE

DRAWING NUMBER

SP-1.0

PAGE NUMBER **3** OF 06

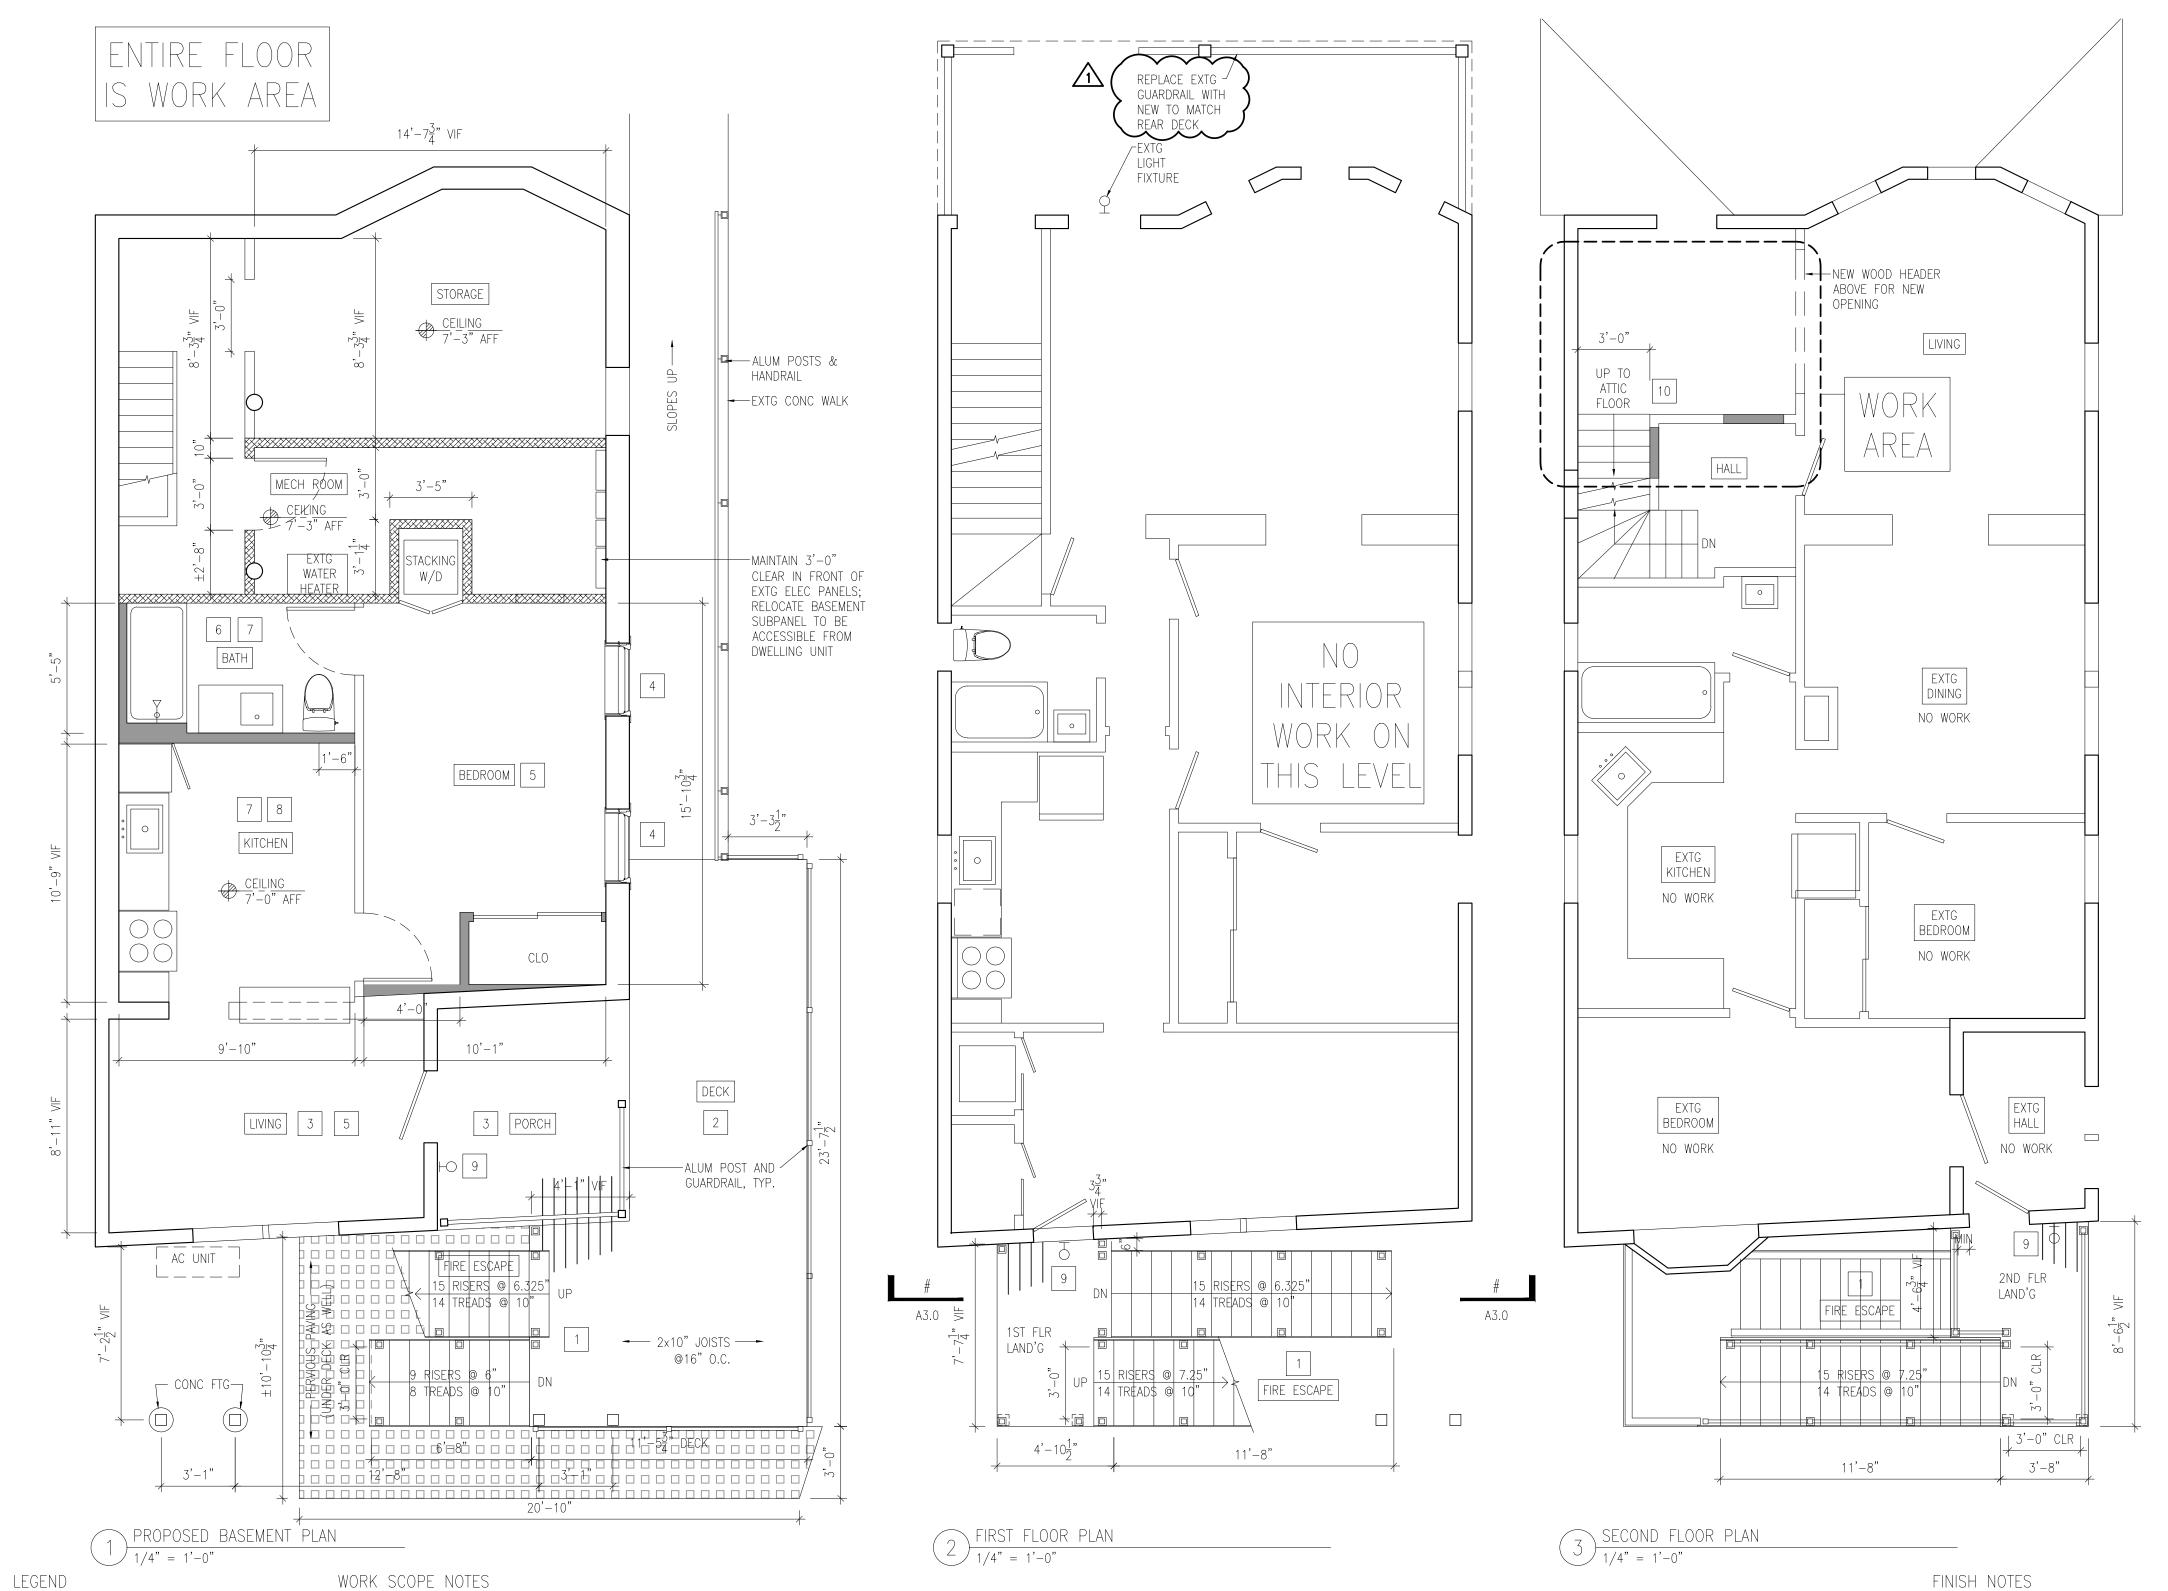

EXTG BEDROOM NO WORK WHERE CABINETS EXISTED: 🕂 AREA PATCH WALL WITH ½" GWB, 📗 PTD TO MATCH EXTG. NSTALL WOOD FLOORING TO MATCH EXTG; SEE ALSO FINISH NOTES + + PROPOSED ATTIC FLOOR 4)1/4" = 1'-0"

> APARTMENT FLOOR AREAS PROPOSED BASEMENT 463 SF EXISTING 1ST FLOOR 824 SF 1,133 SF PROPOSED 2ND FLOOR/ATTIC DUPLEX

		LIG	HT	VENTILATION		
ROOM	FLOOR AREA	MIN. REQ'D PER FLOOR AREA	PROVIDED	MIN. REQ'D OPENABLE AREA	PROVIDED	
		8%		4%		
LIVING	113 SF	9 SF	19 SF	5 SF	8 SF	
BEDROOM	142 SF	11 SF	18 SF	6 SF	18 SF	
KITCHEN + LIVING	198 SF	SEE B	ELOW	8 SF	8 SF	
BATHROOM	50 SF	0 SF	0 SF	SF MIN. 20 cfm/50 SF		
ADJOINING SPACES	WALL AREA	MIN. WALL OPEN'G REQ'D PER FLOOR AREA	WALL OPEN'G PROVIDED	MIN. WALL OPEN'G REQ'D PER INT FLR AREA	WALL OPEN'G PROVIDED	
		10% OR 25 SF	MIN. 1/2 WALL AREA	8% OR 25 SF		
KITCHEN	69 SF	25 SF	35 SF	25 SF	35 S	

- 5. TYP. DECK/FIRE ESCAPE FLOORING TO BE TIMBERTECH AZEK VINTAGE COLLECTION 1X4 FLOOR BOARDS WITH CLASS A FLAME SPREAD RATING. COLOR TBD.
- AZEK VINTAGE COLLECTION 1X12 (OR SIZE AS NEEDED) WITH CLASS A FLAME SPREAD RATING. COLOR TBD.
- 7. TYP DECK/FIRE ESCAPE ALUM POST AND GUARDRAIL BY TREX TO BE BLACK POWDER-COATED.

ARCHITECT

CASTRO WATSON 55 ROSEDALE AVE HASTINGS ON HUDSON, NY 10706

ACASTRO@CASTROWATSON.COM

OWNER

T 917 415 0732

DONNA POLIZIO & AARON FELIZ 65 HILLSIDE AVE HASTINGS ON HUDSON, NY 10706

ISSUE DATE DESCRIPTION

01 01 MAR 2021 ISSUED FOR OWNER REVIEW 02 15 APR 2021 PLANNING BOARD SUBMISSION 03 24 MAY 2021 ARB SUBMISSION

04 10 JUN 2021 PLANNING BOARD SUBMISSION

REVISION 1

PROJECT

65 HILLSIDE AVE HOH, NY 10706

PROJECT NUMBER 65H 2020

DRAWING TITLE

FLOOR PLAN AND NOTES

> SHEET NORTH

ARROW

 $\frac{1}{4}$ " = 1'-0"

APRIL 15, 2021

SCALE

SEAL & SIGNATURE

DRAWING NUMBER

PAGE NUMBER **4** OF 06

WORK SCOPE NOTES

EXTG WALL NEW 1-HOUR FIRE RATED INT. WALL

PARTITION: 2X4 WOOD STUD WITH CONT. §" TYPE X GYP. WALLBOARD BOTH SIDES, TOP AND BOTTOM JOINTS CAULKED; ALL BOARD SEAMS TAPED AND PRIMED (1) COAT. PTND WOOD BASEBOARD 1X3 FLAT STOCK

NEW INTERIOR WALL PARTITION: 2X4 WOOD STUD WITH CONT.  $\frac{1}{2}$ " GYP. WALLBOARD, TOP AND BOTTOM JOINTS CAULKED; ALL BOARD SEAMS TAPED AND PRIMED (1) COAT. AT TUB, USE  $\frac{1}{2}$ " DUROCK CEMENT BOARD ON ALL THREE SIDES I.L.O. GWB AND ½" MOISTURE RESIST. GWB AT ALL OTHER WALLS INSIDE 2 DECK:

PERVIOUS PAVING; SEE LP-1.0

- FIRE ESCAPE SHALL BE CONSTRUCTED TO SUPPORT
- A LIVE LOAD OF 100 PSF AND NO LESS THAN NOMINAL 2 INCHES THICK FOR WOOD SUPPORTS. BOTTOM OF POST CONCRETE FOOTINGS TO BE 12" BELOW FROST LINE AND SHALL REST ON UNDISTURBED SOIL WITH A BEARING CAPACITY OF
- 4000 PSF. - P.T. LEDGER BOARDS BOLTED TO WALL STUDS; DETAILS TO FOLLOW. PROVIDE COPPER FLASHING ABOVE LEDGER TO EXISTING EXTERIOR SHEATHING. - ALL FASTENERS TO BE MIN. 18 GAUGE, STAINLESS STEEL OR HOT-DIPPED GALVANIZED, STEEL

APPROVED FOR EXTERIOR USE AND FRTW

- ASSEMBLIES, SUCH AS SIMPSON STRONG-TIE. INSTALL PER MANUF. RECOMMENDATIONS. - ALL WOOD TO BE PRESSURE-TREATED, TYP.
- DECK SUPPORTING FIRE ESCAPE SHALL BE CONSTRUCTED TO SUPPORT A LIVE LOAD OF 100 PSF AND NO LESS THAN NOMINAL 2 INCHES THICK

- 2X10 P.T. WOOD JOISTS @ 16" O.C., TYP.

ALL WOOD TO BE PRESSURE—TREATED, TYP.

FOR WOOD SUPPORTS. - 4X4 P.T. WOOD POSTS ON CONCRETE FOOTINGS.

- NEW FLOOR STRUCTURE AT LOWERED ELEVATION TO BE CONFIRMED ONCE EXISTING FLOORING IS REMOVED: PRESSURE—TREATED LEDGER BOARDS AT EXTG
- PRESSURE—TREATED BLOCKING AT I—BEAMS 2X10 PRESSURE—TREATED WOOD JOISTS AT 16" ON

MASONRY PERIMETER FOUNDATION WALLS

- R-20 BATT INSULATION IN BETWEEN JOISTS - ¾ PLYWOOD DECK
- EMERGENCY ESCAPE & RESCUE WINDOW: ☐ MARVIN ELEVATE CASEMENT 36"X40" (VIF SIZE IN FIELD) WITH TEMPERED, ARGON-FILLED DOUBLE PANE INSULATED GLAZING UNITS WITH LOW E COATING (MAX. .32 U-FACTOR AND MAC .4 SHGC) AND INSECT SCREENS. PROVIDE WINDOW OPENING CONTROL DEVICES COMPLIANT WITH ASTM F2090 AND EERO REQUIREMENTS. WHITE FIBERGLASS EXTERIOR AND WHITE FACTORY-PTD WOOD INTERIOR; SATIN NICKEL HARDWARE.
- NEW BASEBOARD HEATING IN BEDROOM AND LIVING
- BATH WATERPROOFING: INSTALL LATICRETE 9235
  LIQUID-APPLIED WATERPROOFING MEMBRANE AT FLOORS THROUGHOUT, FULL-HEIGHT AT TUB ALCOVE WALLS, AND UP TO 4FT AFF ALL OTHER WALLS.

- REPLACE KITCHEN EXHAUST HOOD; REUSE DUCT TO EXTERIOR. 10 NEW STAIR TREADS AND RISERS TO MATCH EXTG. EXTEND EXTG HANDRAIL DOWN TO LAST TREAD. PROVIDE NEW
- 8 FIRE PROTECTION AND LIFE SAFETY DEVICES:
  HARD-WIRED WITH BATTERY BACK-UP SINGLE OR MULTIPLE-STATION SMOKE ALARMS SHALL BE INSTALLED AND MAINTAINED PER SECTION 907.2.10.2 OF THE BCNYS AND FCNYS AT ALL THE FOLLOWING LOCATIONS: A) CEILINGS OR WALL OUTSIDE OF EACH SEPARATE SLEEPING AREA IN THE IMMEDIATE VICINITY OF BEDROOMS; B) IN EACH ROOM USED FOR SLEEPING PURPOSES; C) IN EACH STORY WITHIN A
- DWELLING UNIT. HARD-WIRED WITH BATTERY BACK-UP CARBON MONOXIDE DETECTION SHALL BE INSTALLED AND MAINTAINED PER SECTION 915 OF THE FCNYS WITHIN 10 FT OF A SLEEPING AREA WITHIN A DWELLING UNITS WITH A FUEL BURNING APPLIANCE IN A KITCHEN OR KITCHENETTE AND ON EACH STORY WITHIN A DWELLING UNIT.
- EXTERIOR EGRESS LIGHTING WITH MIN. 90 MIN. BATTERY BACK-UP TO BE UL & IP65 RATED AND DARK SKY COMPLIANT; DURATION AND ILLUMINATION PER NYSBC 1008.3.4 & 1008.3.5; CONTROL WITH MOTION SENSOR. A MINIMUM 90% OF INTERIOR LIGHT FIXTURES TO BE HIGH-EFFICACY LAMPS.

FINISH NOTES


1. TILED FLOOR THROUGHOUT BASEMENT DWELLING UNIT WITH ELECTRIC HEAT MAT WITHIN GROUT. SPEC BY OWNER. 3-WAY LIGHT SWITCH AT BOTTOM OF STAIR TO EXTG STAIR 2. TYP: PNTD 1X3 FLAT STOCK WOOD BASEBOARD ON GWB

> 3. TYP: CEILING THROUGHOUT TO BE  $\frac{1}{2}$ " TAPED, PRIMED, AND PNTD GWB. AT MECHANICAL RM INSTALL & TYPE X GWB

> 4. TYP: PAINTED WALL AND CEILING FINISH TO BE (2) COATS BENJAMIN MOORE NATURA ZERO-VOC LATEX ACRYLIC PAINT IN EGG SHELL. COLOR BY OWNER. WOOD TRIM TO BE SEMI-GLOSS.

6. TYP. DECK/FIRE ESCAPE FASCIA BOARDS TO BE TIMBERTECH

8. PERMEABLE PAVERS SPEC TBD.

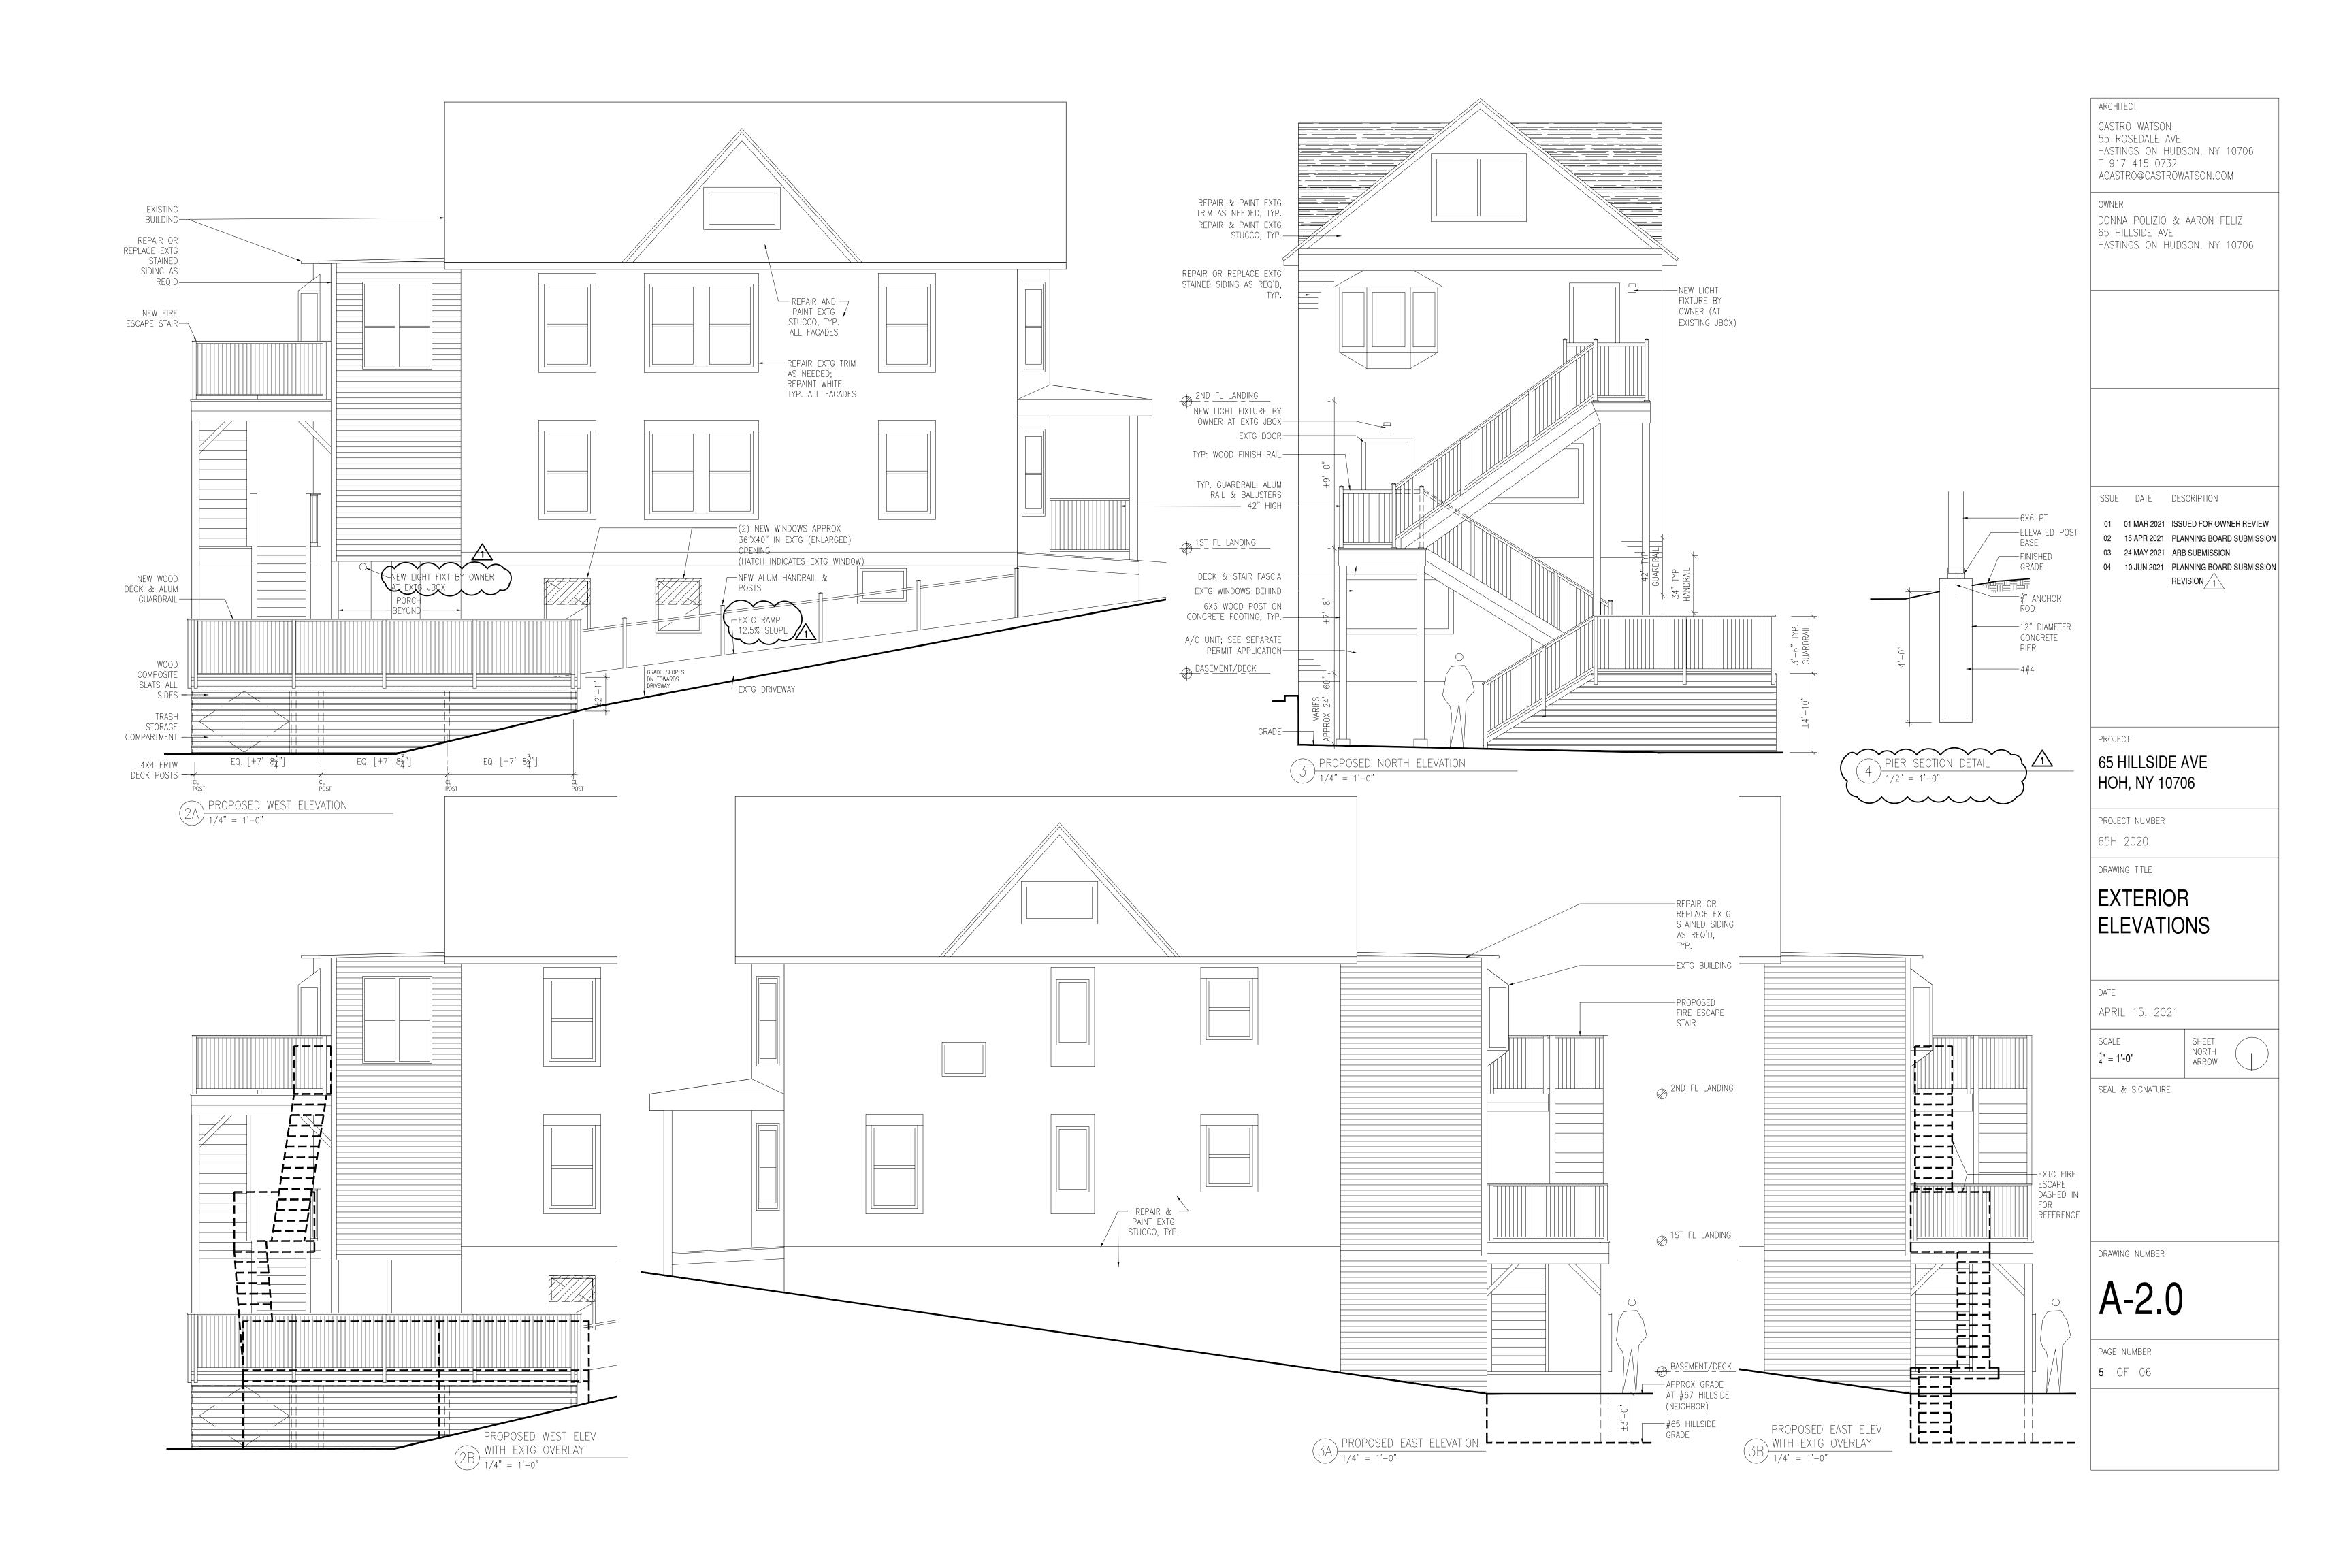


## LANDSCAPE PLAN LEGEND

LEVEL OR SLIGHTLY RAISED PLANTING BED WITH MULCH


PERVIOUS PAVING SUCH AS "TRUEGRID" WITH PERMEABLE GRAVEL OR "HYDROPAVERS"; INSTALL PER MANUF. INSTRUCTIONS

PLANTINGS SCHEDLILE

PLANTINGS SCI	HEDULE		
PLANTING #	APPROX SIZE	PLANTINGS TYPE	NOTES
BED 01 (EXTG)	18 SF	MIX OF SHRUBS, PERENNIALS, ROSES, AND/OR BULBS	
BED 02 (EXTG)	57 SF	MIX OF SHRUBS, PERENNIALS, ROSES, AND/OR BULBS	
BED 03 (EXTG)	120 SF	MIX OF SHRUBS, PERENNIALS, ROSES, AND/OR BULBS	
BED 04 (NEW)	±300 SF	MIX OF SHRUBS, PERENNIALS, ROSES, AND/OR BULBS	
BED 05 (NEW)	±100 SF	MIX OF SHRUBS, PERENNIALS, ROSES, AND/OR BULBS	
TREE 01 (EXTG)		NATIVE EASTERN REDBUD	15-30 FT
SHRUB 01 (EXTG & NEW)		ILEX CRENATA	APPROX. 8FT TALL FOR PRIVACY

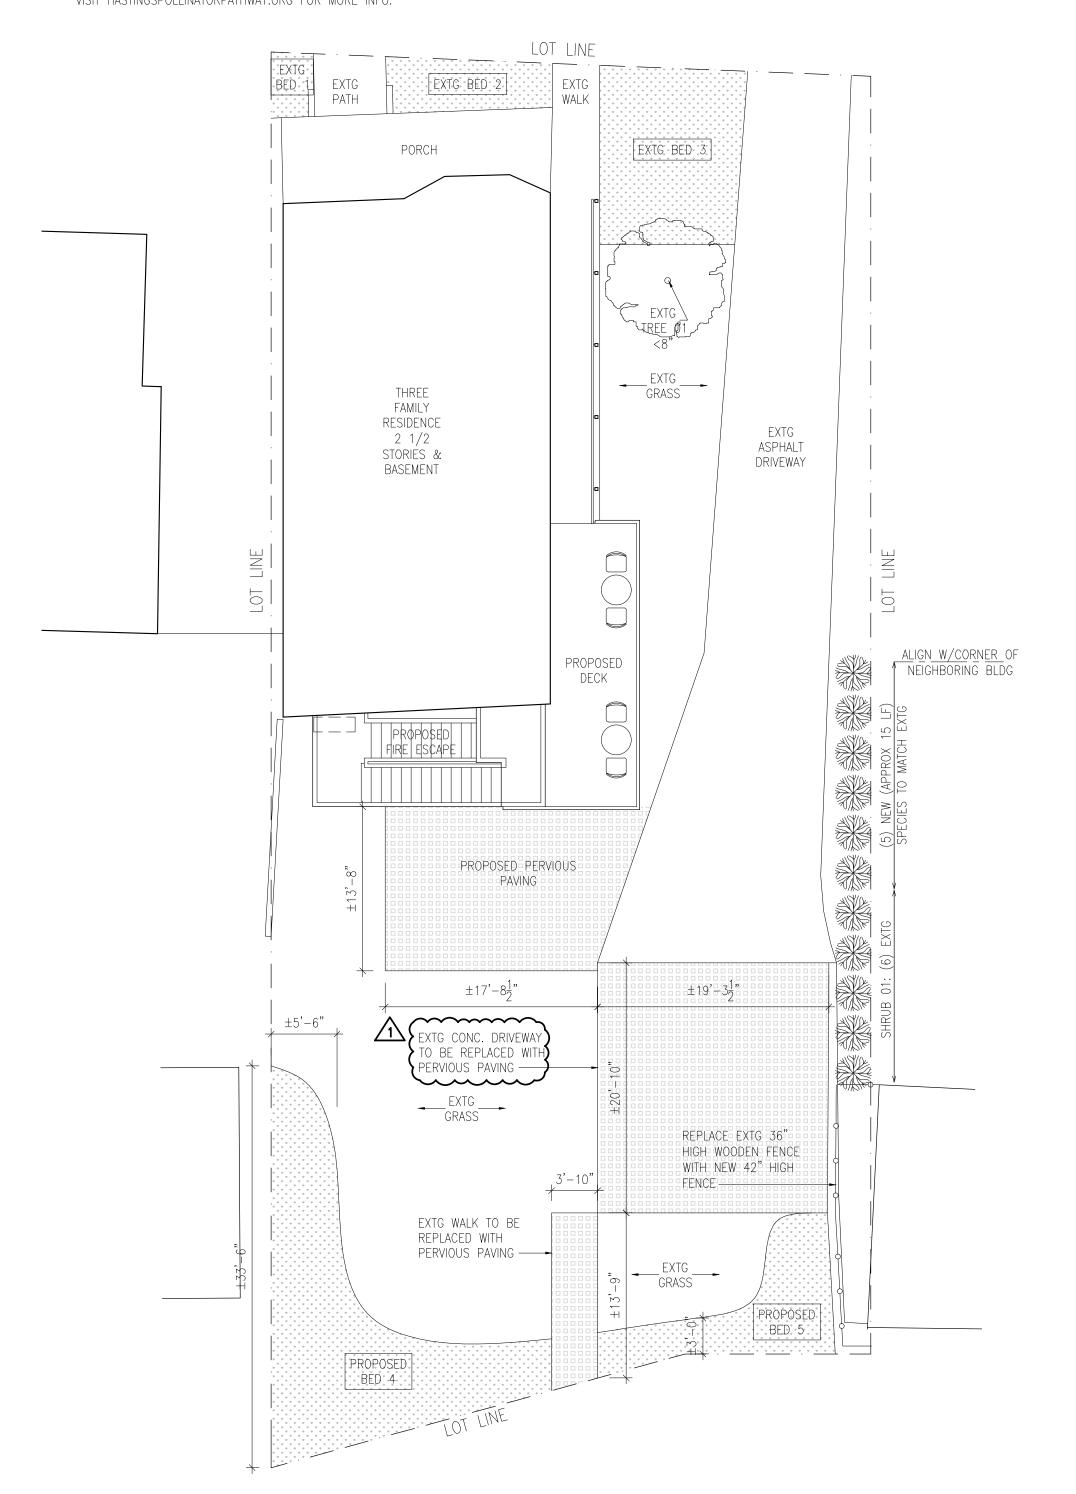



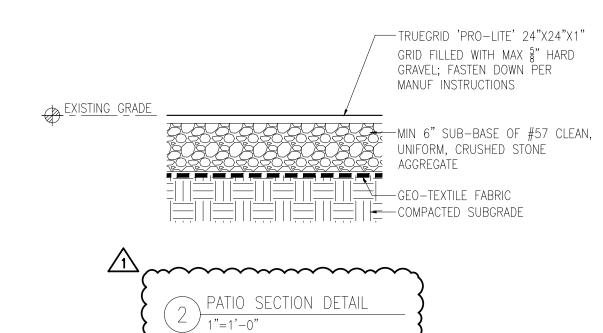

ARCHITECT

CASTRO WATSON 55 ROSEDALE AVE HASTINGS ON HUDSON, NY 10706 T 917 415 0732

ACASTRO@CASTROWATSON.COM

DONNA POLIZIO & AARON FELIZ 65 HILLSIDE AVE HASTINGS ON HUDSON, NY 10706

ISSUE DATE DESCRIPTION

01 14 APR 2021 ISSUED FOR OWNER REVIEW 02 15 APR 2021 PLANNING BOARD SUBMISSION 03 10 JUN 2021 PLANNING BOARD SUBMISSION REVISION 1

PROJECT

65 HILLSIDE AVE HOH, NY 10706

PROJECT NUMBER 65H 2020

DRAWING TITLE

LANDSCAPE PLAN

APRIL 15, 2021

SCALE 1/8" = 1'-0"

SEAL & SIGNATURE

SHEET NORTH ARROW

DRAWING NUMBER

LP-1.0

PAGE NUMBER **6** OF 06

THERE SHALL BE NO INVASIVE PLANTINGS.
 ALL PLANTINGS BEDS TO INCLUDE NATIVE PLANTS ENDORSED BY THE HASTINGS POLLINATOR PATHWAY PROJECT; VISIT HASTINGSPOLLINATORPATHWAY.ORG FOR MORE INFO.