

	LIST OF DRA	WINGS	
	DPW#	Sheet #	Drawing Title
	GENERAL		
	43-75I-T-92-0 43-75I-G-93-0 43-75I-G-94-0 43-75I-G-95-0 48-75I-G-96-0 48-75I-G-97-0	1. 2. 3. 4. 5.	TITLE SHEET GENERAL NOTES ROADWAY & BRIDGE SECTIONS BASIC WORK TRAFFIC CONTROL NOTES BASIC WORK TRAFFIC CONTROL PLANS BASIC WORK TRAFFIC CONTROL PLANS
	XX-XXX-X-XX-X 43-75I-R-98-0 43-75I-R-99-0 XX-XXX-X-XX-X 43-75I-R-100-0	8. 9. X 10.	EXISTING CONDITIONS SITE PREPARATION & DEMOLITION PLAN LAYOUT & MATERIALS SIGNAGE AND STRIPING GRADING & DRAINAGE PLAN
JF	ORMATION		

PERMIT INFORMATION

-) Any additional permits and fees required to complete the work are the responsibility of the Contractor
-) STATE HIGHWAY PERMIT submitted on [ADD DATE] approved on [ADD
- Any work done in the state right of way shall be built according to the current NYS Standard Specifications for Constructions and Materials, dated May 1 2008 and all addenda thereto. Any structures located in the state right of way shall be certified by the manufacturer that the item is built according to the current NYS Standard Specifications for Constructions and Materials, dated May 1, 2008 and all addenda thereto.

TABLE OF MAINTENANCE **ROAD BED & SURFACE, TRAFFIC SIGNAL,** NYSDOT (BROADWAY)


STRIPING & TRAFFIC CONTROL COUNTY (WARBURTON AVE) ROAD BED & SURFACE, DRAINAGE & TRAFFIC CURB, SIDEWALKS, CROSSWALK STRIPING. **VILLAGE OF HASTINGS** TRAFFIC SIGNAL, STREET TREES, LITTER & SNOW REMOVAL, AND EVERYTHING ELSE **BEYOND THE EDGE OF ROADWAY & WITHIN**


THE R.O.W.



WESTCHESTER COUNTY, NEW YORK DEPARTMENT OF PUBLIC WORKS & TRANSPORTATION DIVISION OF ENGINEERING

CONTRACT No. 16-526 MISCELLANEOUS ROADWAY IMPROVEMENTS WARBURTON AVENUE (C.R. #75I) VILLAGE OF HASTINGS ON HUDSON, NY

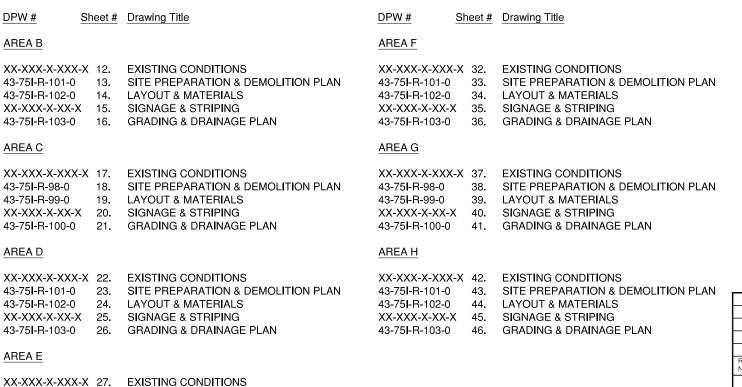

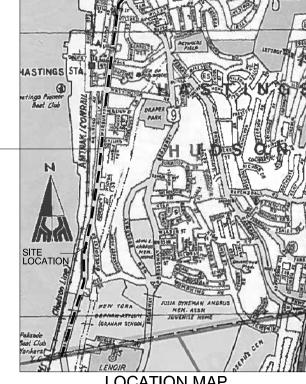

SITE LOCATION-

DPW#

DETAILS

43-75**I**-R-90-0

43-75**I**-R-90-0

43-75**I**-R-91-0

43-75**I**-R-92-0

43-75**I**-R-92-0

43-75I-R-93-0

43-75**I**-R-94-0

XX-XXX-X-XX-X

XX-XXX-X-XX-X

Sheet # Drawing Title

50.

51.

53.

54.

LOCATION MAP

SITE PREPARATION & RESTORATION DETAILS

ASPHALT PAVEMENT DETAILS

CONCRETE REPAIR DETAILS

PAVEMENT MARKING DETAILS SIGNAGE & PARKING LAYOUT DETAILS

GUIDE RAIL & FENCING DETAILS

MISCELLANEOUS DETAILS

DRAINAGE DETAILS

CONCRETE PAVEMENT DETAILS

DATE RECORD DRAWING CERTIFICATION AS BUILT - CHANGES AS NOTED AS BUILT - NO CHANGES PROJECT COORDINATOR ONTRACT WESTCHESTER COUNTY, NEW YORK 16-526 DEPARTMENT OF PUBLIC WORKS AND TRANSPORTATION SHEET NO. 1 OF 55 MISCELLANEOUS ROADWAY IMPROVEMENTS SCALE: AS SHOWN

WARBURTON AVENUE (C.R. #75I)

VILLAGE OF HASTINGS ON HUDSON, NEW YORK

TITLE SHEET

DATE: 3/15/2018

XX-XX-T-XX-0

RECOMMENDED FOR CONSTRUCTION

ANTHONY J. VENTAROLA, P.E. ASSOCIATE ENGINEER DEPARTMENT OF PUBLIC WORKS AND TRANSPORTATION

SITE PREPARATION & DEMOLITION PLAN

LAYOUT & MATERIALS

SIGNAGE & STRIPING

43-75**I**-R-98-0

43-75**I**-R-99-0

XX-XXX-X-XX-X 30.

28.

29.

43-75I-R-100-0 31. GRADING & DRAINAGE PLAN

RECOMMENDED FOR CONSTRUCTION

JOSEPH J. NICOLETTI, JR., P.E. FIRST DEPUTY COMMISSIONER DEPARTMENT OF PUBLIC WORKS AND TRANSPORTATION

APPROVED FOR CONSTRUCTION

HUGH J. GREECHAN, P.F. COMMISSIONER DEPARTMENT OF PUBLIC WORKS AND TRANSPORTATION

General Notes

- The Contractor shall visit the site and familiarize himself with existing site conditions prior to submitting a bid. He shall check, and verify all conditions and dimensions and report any discrepancies, where evident, to Westchester County prior to the bid.
- All pay items shown on Plans refer to the latest version of the New York State
 Department of Transportation Standard Specifications for construction and
 materials and all addenda thereto, excluding pay items that begin with a "W"
 which are Westchester County Special Specifications (see specification book
 for descriptions).
- 3. Work pertaining to modifications, as may be required, due to any difference between actual field conditions and those shown by the details and dimensions on the contract plans, will be paid at the unit bid price for the actual quantities of materials used or for the work performed, as indicated by the various items in the contract
- I. The contractor is responsible for examining the areas of proposed work as to the actual conditions and requirements of work prior to submitting a bid. He/she shall check and verify all conditions and dimensions, and any discrepancies between the drawings and field conditions shall be brought to the attention of the Engineer in writing prior to commencement of work.
- 5. The contractor will be held responsible for all damages to the existing facilities caused by his operations which are not included as part of the intended work. All damages to the existing facilities which are not part of the intended work shall be repaired by the Contractor without cost to the County, and to the satisfaction of the Engineer.
- 6. All work shall be done and installed in compliance with all laws, rules and regulations of the local municipality and shall comply with the latest edition of the New York State Fire Prevention and Building Code, including all reference standards. All materials and equipment used in the project shall conform to and have approvals in accordance with any other public authorities or agencies having jurisdiction over the project. The contractor shall protect his workers at all times in conformance with applicable OSHA regulations.
- Access to all adjoining facilities shall be maintained at all times where reasonably possible. Property manager/owners must be notified in advance of any temporary driveway closures. See Construction Staging Note #4.
- 8. The Contractor will be required to perform maintenance cleaning of the pavement when ordered by the Engineer. Maintenance cleaning shall mean the removal of debris from any source, which in the opinion of the Engineer impedes flow of traffic or storm water. This requirement shall not be construed to change the provisions of Article 619-1.02B Snow and Ice Control (NYSDOT Standard Specifications).
- Areas beyond the work limits disturbed for any reason by the Contractor and his employees, shall be restored to the satisfaction of the Engineer at the Contractor's expense.
- 10. The Contractor's attention is directed to the fact that due to the nature of reconstruction projects, the exact extent of reconstruction work cannot always be accurately determined prior to the commencement of work. These contract documents have been prepared based on field inspection and other available information. Actual field conditions may require modifications to construction details and work quantities. The contractor shall perform the work in accordance with field conditions and as directed by the Engineer.
- 11. "A.O.B.E." indicates work to be performed as ordered by Engineer.

12. The Contractor shall take positive steps to prevent the splattering of vehicles. The Contractor shall provide for the prompt cleaning of any vehicles splattered by Contractor's operations and shall pay for the cleaning. The cost for this work shall be include in the price bid for the various items in the contract.

Paving and Milling

- Tack coat in addition to the distributor equipment described in the specifications, small power spray units or hand-held spray equipment, as approved by the Engineer, may be used in the areas where use of the distributor is impractical, such as narrow irregular areas, intersections and other locations where traffic must be allowed to cross the pavement.
- Tack coat shall be applied to any asphalt concrete pavement except when the existing surface is excessively flushed, as determined by the Engineer.
- 3. Where pavement keys are cut into the existing pavement in preparation for the overlay at the limits of resurfacing, prior to reopening the roadway to traffic, the Contractor shall either place the proposed asphalt overlay immediately or place a temporary wedge (4' min. width a.o.b.e.) of asphalt to eliminate the bump created by the pavement key. The cost of this work shall be included in the price bid for the paving items.
- 4. The contractor shall exercise care in his cold milling and removal operations so as not to unduly disturb or damage underlying materials which are to remain in place. If the contractor damages any materials that are to remain in place, the damaged materials shall be either repaired or replaced in a manner satisfactory to the Engineer at the expense of the contractor. The Contractor shall keep the roadway within the project limits clear of debris and dust and is responsible for any street cleaning necessary during the course of the project.
- 5. Prior to opening crosswalks to pedestrians after milling operations, the crosswalk area shall be inspected by the Engineer to ensure an even walking surface for pedestrians for safety issues. Walking surfaces deemed unsafe shall be corrected by the Contractor as directed by the Engineer.
- 6. The contractor is solely responsible for <u>properly</u> securing any required water for milling, saw cutting and other operations. The County and municipalities will not be able to provide this.
- Pavement shall be cleaned after milling, and directly before paving. This
 work is included in the milling item.

Staging Areas

- Due to the populated locations of some of the work sites, there will be limited areas for staging available for work operations on or off County property. Therefore, equipment must be removed from work areas at the end of each work day, unless approved in writing by the Engineer.
- Any staging area for equipment and material storage, for the contract, must be approved by the Engineer and municipality and restored to its original condition after completion of the project. No separate payment will be made for this work.
- The Contractor's attention is directed to the fact that because of the proximity of adjacent property, within the limits of this contract, there may not be exclusive occupancy of the territory within the limits of this contract,
- 3. Whenever items in the contract require materials to be removed and disposed of, the cost of supplying a disposal area and transportation to that area shall be included in the unit price bid for those items.

Construction Staging

- Roads are limited to a single lane closure at any given time. Full closures and detours will not be permitted without written permission from the Engineer, and the Village of Hastings.
- 2. This roadway is a major arterial and as such has a large volume of traffic during the day that must be maintained. Because of this fact the Contractor will be required to perform the millling and paving operations at night between 10:00 pm and 6:00 am. No lane closures are permitted on weekends or 7:00 am to 9:30am and 3:00 pm to 7:00 pm on weekdays. Work may be permitted on weekends only with the written permission of the Engineer and the Village of Hastings. All work shall be limited to one "segment" or zone, only one side of the travelled way at a time only with the written permission of the Engineer. A work "segment" or zone is defined as that area in which traffic is restricted because of construction activities in the travel way, or that area that invokes a drop-off next to the pavement.
- A schedule of operations shall be provided to the County prior to start of work, indicating which roads will be affected by work and allowing proper notification.
- 4. Before restricting the normal flow of traffic in any way, the Contractor shall give forty-eight (48) hours prior notice to the County, and the Village of Hastings. In addition, he shall give forty-eight (48) hours notice to all residents and/or businesses having driveways and entrances within the contract limits before commencing any operations which will temporarily interfere with their use. The Contractor shall assign a responsible employee to give the aforementioned notices in writing after concurrence with the Engineer.
- Police for traffic services shall be utilized at work locations where it is required by municipal regulation, or at the discretion of the Engineer, and paid accordingly from item W911.

Utilities

- 1. The location, size, depth and completeness of information of existing utilities are not guaranteed. The Contractor shall adhere to the regulations of the State of New York, Department of Public Service code 16 NYCRR Part 753- "Protection of Underground Facilities;" call 1-800-962-7962 prior to commencing any work. Where excavation is required under this contract, the Contractor shall verify actual locations by excavating test pits under the direction of the respective utility company. Test pits paid for under Item 206.05.
- 2. The Contractor shall be responsible for locating surface utility fixtures, such as valve boxes & electrical manholes. Care should be taken not to damage said facilities, or bury them under new layers of pavement. Existing damaged facilities should be reported to the Engineer and the appropriate utility company.

Testing of Materials


- 1. Material testing shall be paid under Item W851, and shall be used at the discretion of the Engineer. Such testing involves, but not limited to, asphalt density testing, concrete cylinders and slump measurement and may include payement cores.
- 2. The County reserves the right to weigh all asphalt material trucks on site

Erosion Control Notes

- All proposed soil erosion and sediment control practices have been designed in accordance with the most recent editions of the New York State Stormwater Management Design Manual and the New York State Standards and Specifications for Erosion and Sediment Control. The contractor shall comply with all applicable stormwater management, water quality control, erosion, and sediment control laws, rules, regulations and permits.
- Sediment and erosion control practices shall be installed prior to any major soil disturbances and maintained until permanent protection is established.
- 3) The contractor shall be responsible for the timely maintenance of sediment and erosion control practices. All practices shall be maintained in good working order. The sediment level in all sediment traps shall be closely monitored and sediment removed when maximum levels are reached or as ordered by the construction administrator. All sediment control practices shall be inspected on a regular basis, and after rainfall events greater than half an inch to ensure proper operation as designed.
- 4) All soils not being used for final grading shall be immediately, protected, stabilized and stockpiled in a location away from storm drains and waterbodies as approved by the construction administrator. All soil stockpiles shall be limed, fertilized, temporarily seeded with annual or perennial ryegrass or oats within 14 days once it is known the soil stockpile will not be used for a period of time greater than 14 days. The cost of such protection and stabilization shall be deemed included in the various items of the contract. No Direct Payment.
- 5) Any disturbed areas that will be left exposed for more than 21 days and are not subject to construction traffic shall be stabilized with temporary seeding. Erosion control fabric or mulch shall be used on all disturbed areas if the season prevents the establishment of a temporary cover for temporary stabilization. Erosion control fabric shall be used to temporarily stabilize steep slopes (slope gradient of 2:1 or greater). Disturbed areas shall be limed and fertilize prior to temporary seeding.
- All disturbed areas within 500 feet of an inhabited dwelling shall be wetted as necessary to ensure dust control.
- 7) Temporary sediment and erosion control practices shall be removed and permanent sediment and erosion control practices implemented, where specified, when the drainage area, including all roads, driveways, and parking areas used during the course of construction has been properly stabilized by permanent practices in accordance with the New York State Stormwater Management Design Manual and the New York State Standards and Specifications for Erosion and Sediment Control.
- 8) The contractor shall phase the construction in a manner that there will be no more than five acres of soil disturbance at any one time.

THE CONTRACTOR IS ADVISED THAT ADDITIONAL NOTES WILL BE FOUND ON SUBSEQUENT SHEETS OF THE CONTRACT PLANS. SUCH NOTES WHILE PERTAINING TO SPECIFIC DRAWINGS WHERE THEY ARE PLACED, ALSO SUPPLEMENT THE GENERAL NOTES LISTED HEREIN.

							RECORD DRAWIN	NG CERTIFICATION	WESTCHESTER COUNTY, NEW YORK	CONTRACT SHEET NUMBER	
						ı ——	BUILT — CHANGES AS NOTED BUILT — NO CHANGES		DEPARTMENT OF PUBLIC WORKS AND TRANSPORTATION DIVISION OF ENGINEERING	16-526 SHEET NO. 2	2 OF 55
IN CHARGE OF A. VENTAROLA, P.E. CHECKED BY S. LOPANE						NAME	CONTRACTOR	PROJECT COORDINATOR	MISCELLANEOUS ROADWAY IMPROVEMENTS WARBURTON AVENUE (C.R. #75I)	SCALE: AS SH DATE: 3/15/2	2018
MADE BYK. SITZMAN	REVISION NUMBER	DATE	MADE BY	APP'D BY	REVISION	SIGNATURE TITLE	DATE	SIGNATURE DATE	VILLAGE OF HASTINGS ON HUDSON, NEW YORK GENERAL NOTES	DPW FILE NO.	NO.

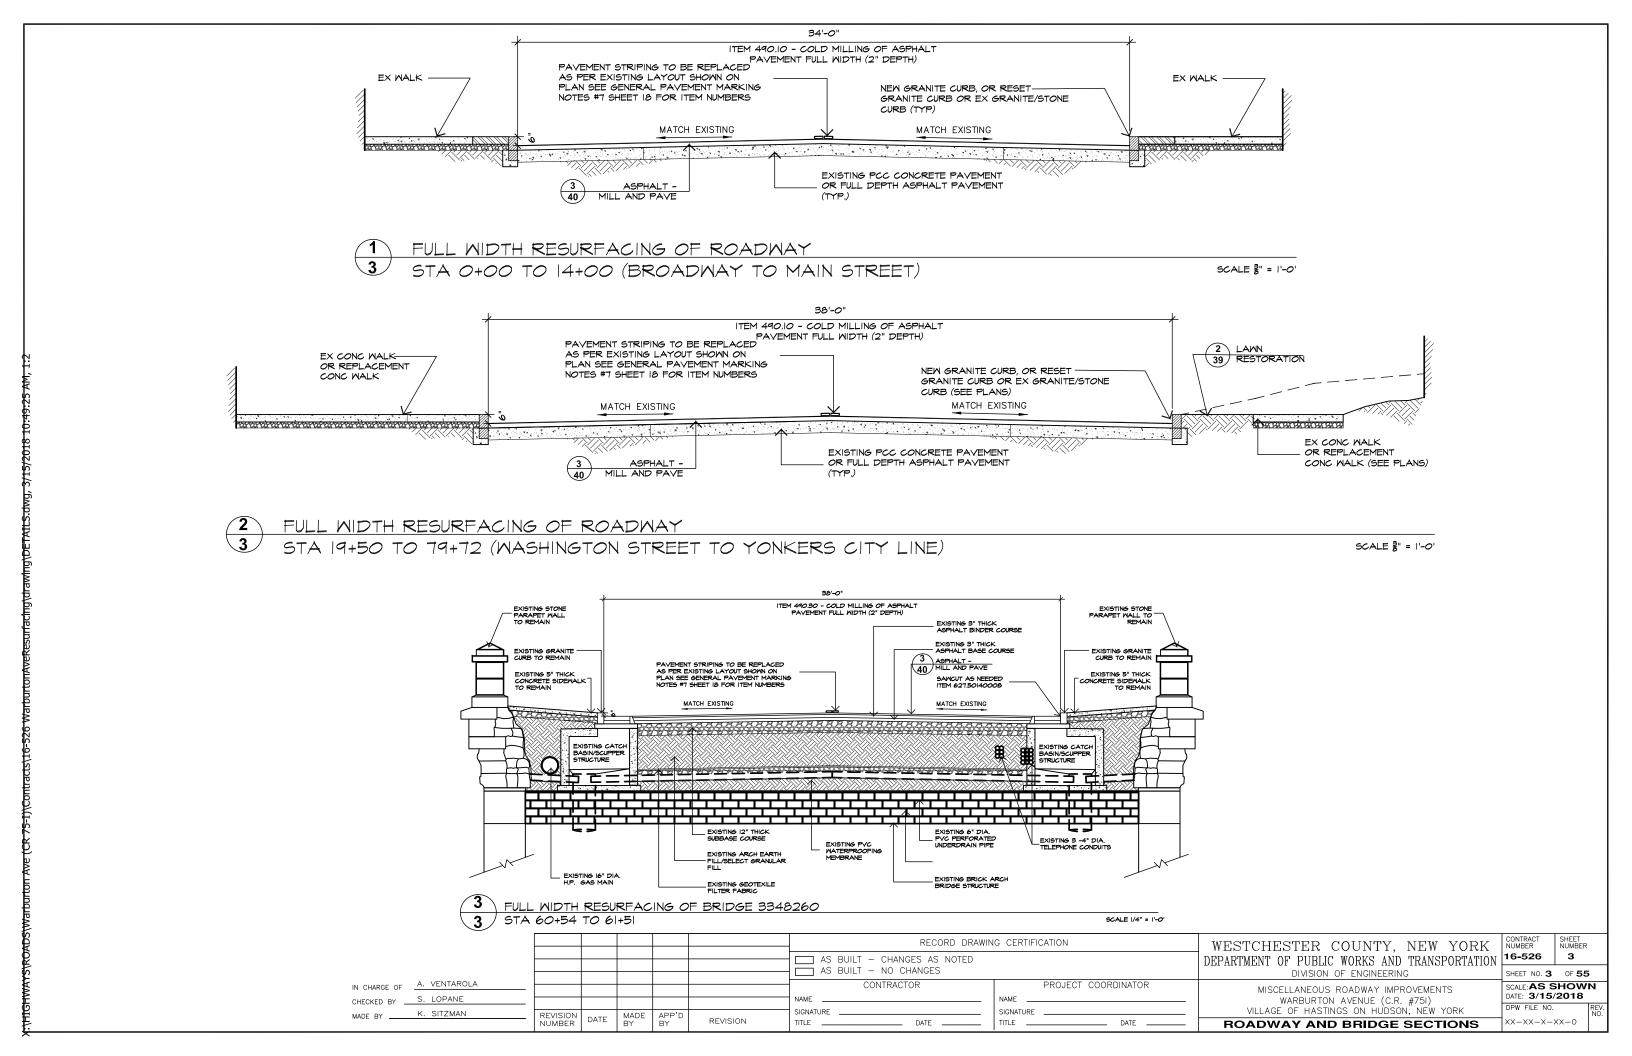

GENERAL NOTES (01/08/09)

- THE TYPICAL DETAILS DEPICTED ON THE STANDARD SHEETS AND IN THE MUTCD, REFLECT THE MINIMUM REQUIREMENTS.
- THE CONTRACTOR MUST SUBMIT TO THE ENGINEER, IN WRITING, PROPOSED REVISIONS TO THE TRAFFIC CONTROL PLAN FOR REVIEW AND APPROVAL BY THE REGIONAL DIRECTOR OR HIS/HER DESIGNEE FIVE (5) WORK DAYS PRIOR TO THE PLANNED IMPLEMENTATION OF SUCH PRÓPOSED REVISIONS, EXCÉPT FOR CHANGES THAT ALTER THE SCOPE OF THE TRAFFIC CONTROL PLAN. SUCH CHANGES IN SCOPE MUST BE SUBMITTED TO THE ENGINEER FOR APPROVAL BY THE REGIONAL DIRECTOR OR HIS/HER DESIGNEE THIRTY (30) WORKING DAYS PRIOR TO IMPLEMENTATION OF SUCH REVISIONS.
- THE CONTRACTOR SHALL PROVIDE THE ENGINEER, IN WRITING, WITH THE NAMES, ADDRESSES, AND TELEPHONE NUMBERS OF STAFF WHO ARE AUTHORIZED TO SECURE LABOR, MATERIALS, AND EQUIPMENT FOR EMERGENCY REPAIRS OUTSIDE NORMAL WORKING HOURS. THE ENGINEER WILL PROVIDE THE SUBMITTED INFORMATION TO REGIONAL MANAGEMENT, THE NEW YORK STATE POLICE, THE RESIDENT ENGINEER, AND THE LOCAL POLICE.

ACTIVITY AREA

- THE CONTRACTOR SHALL MAINTAIN A MINIMUM 500' LONGITUDINAL DISTANCE BETWEEN CONSTRUCTION OPERATIONS ON ALTERNATE SIDES OF THE ROADWAY, UNLESS OTHERWISE
- WHEN TWO OR MORE AREAS ARE ADJACENT, OVERLAP, OR ARE IN CLOSE PROXIMITY, THE CONTRACTOR SHALL ENSURE THERE ARE NO CONFLICTING SIGNS AND THAT LANE CONTINUITY IS MAINTAINED THROUGHOUT ALL WORK AREAS.

- THE LOCATIONS OF THE SIGNS SHOWN ON THE WORK ZONE TRAFFIC CONTROL PLANS AND DETAILS MAY BE ADJUSTED BASED ON SIGHT DISTANCE AND OTHER CONSIDERATIONS. THE FINAL LOCATIONS OF SIGNS ARE SUBJECT TO APPROVAL OF THE ENGINEER.
- ANY EXISTING SIGNS, INCLUDING OVERHEAD SIGNS, WHICH CONFLICT WITH THE TEMPORARY TRAFFIC CONTROL SIGN LAYOUT SHALL BE COVERED, REMOVED, STORED OR RESET, AS APPROVED BY THE ENGINEER. ALL APPROPRIATE EXISTING SIGNS SHALL BE RESTORED TO THEIR ORIGINAL CONDITION AND/OR LOCATION UNLESS OTHERWISE REPLACED IN THIS

SIGNS AT OR NEAR INTERSECTIONS SHALL BE PLACED SO THAT THEY DO NOT OBSTRUCT A

ALL WARNING AND REGULATORY SIGNS SHALL BE POSTED ON BOTH SIDES OF MULTI-LANE DIVIDED HIGHWAYS, MULTI-LANE RAMPS, AND ONE-WAY STREETS. IN CASES WHERE LANE RESTRICTIONS REDUCE THE TRAVEL LANE TO ONE LANE, SIGNS SHALL BE POSTED ON THE SIDE OF THE ACTIVE TRAVEL LANE, UNLESS OTHÉRWISE AUTHORIZED BY THE

SIGNS MOUNTED ON THE MEDIAN OF DIVIDED HIGHWAYS WHERE MEDIAN BARRIER IS IN PLACE MAY BE MOUNTED ON THE BARRIER WITH A SADDLE TYPE BRACKET. LAYING THE SIGN DOWN IN A HORIZONTAL POSITION IS NOT PERMITTED.

THE DIMENSIONS OF WORK ZONE TRAFFIC CONTROL SIGNS ARE DESCRIBED IN THE MUTCO. ANY CHANGES TO THE DIMENSIONS SHALL BE APPROVED BY THE REGIONAL DIRECTOR OR BY HIS/HER DESIGNEE

NYR9-12 MAY BE USED IN PLACE OF NYR9-11.

WHERE POSSIBLE ALL CHANNELIZING AND GUIDING DEVICES ARE TO BE PLACED SO AS TO PROVIDE A MINIMUM 2' LATERAL CLEARANCE TO THE TRAVELED WAY.

UBLIC ACCESS

PROPERTY OWNERS WHOSE DRIVEWAYS WILL BE MADE INACCESSIBLE SHALL BE NOTIFIED BY THE CONTRACTOR AT LEAST 24 HOURS PRIOR TO RESTRICTING USE OF THE DRIVEWAY, FOR MULTIPLE ACCESS PROPERTIES, AT LEAST ONE DRIVEWAY SHALL BE OPEN AT ALL TIMES. ACCESS SHALL BE RESTORED TO ALL DRIVEWAYS AS SOON AS POSSIBLE.

SUITABLE RAMPS SHALL BE INSTALLED TO MAINTAIN SMOOTH TRANSITIONS FROM RESIDENTIAL AND COMMERCIAL DRIVEWAYS TO AND FROM THE WORK AREA.

THE CONTRACTOR SHALL LOCATE LANE CLOSURES TO PROVIDE OPTIMUM VISIBILITY, I.E. BEFORE CURVES AND CRESTS, TO THE EXTENT CONDITIONS PERMIT.

THE ENGINEER MAY REQUIRE THAT ALL LANES BE RE-OPENED AT ANY TIME IF THE ROUTE IS NEEDED FOR EMERGENCY PURPOSES. THIS COULD INCLUDE INCIDENTS AT LOCATIONS OUTSIDE THE CONTRACT LIMITS.

UNLESS AUTHORIZED BY THE ENGINEER, THE MINIMUM LANE WIDTHS FOR WORK ZONE TRAVEL LANES SHALL BE AS FOLLOWS: FREEWAYS AND/OR EXPRESSWAYS IS 11'. THE MINIMUM LANE WIDTH FOR ALL OTHER TYPES OF ROADWAYS IS 10'.

THE CONTRACTOR SHALL PROVIDE A WRITTEN NOTICE TO THE ENGINEER, A MINIMUM OF 21 CALENDAR DAYS IN ADVANCE OF PERFORMING ANY WORK THAT RESULTS IN THE REDUCED WIDTH OF AN EXISTING ROADWAY, SO THAT THE ENGINEER MAY NOTIFY THE REGIONAL PERMIT ENGINEER IN A TIMELY MANNER.

TABLE NY1-A BARRIER VEHICLE USE REQUIREMENTS (LONG TERM, INTERMEDIATE TERM, AND SHORT TERM STATIONARY CLOSURES)

		USE REQUIREMENTS ^{4,5}					
CLOSURE TYPE	EXPOSURE CONDITION 1		NON-FREEWAY (PRECONSTRUCTION POSTED SPEED LIMIT)				
		FREEWAY	w 45-MPH	35-40 MPH	I 30 MPH		
LANE OLOGUPE	WORKERS ON FOOT OR IN VEHICLES EXPOSED TO TRAFFIC	REODHRED ³	REQUIRED ³	REQUIRED ³	OPTIONAL ²		
LANE CLOSURE	NON-TRAVERSABLE HAZARD (IE. EQUIPMENT, MATERIALS, EXCAVATION) ONLY NO WORKERS EXPOSED	REQUIRED ³	REQUIRED ³	OP TIQUAL ²	OPTIONAL ²		
CHAIR DED OF OCHDE	WORKERS ON FOOT OR IN VEHICLES EXPOSED TO TRAFFIC	REODERED ³	REQUIRED ³	OPTIONAL ²	OPTIONAL ²		
SHOULDER CLOSURE	NON-TRAVERSABLE HAZARD (IE. EQUIPMENT, MATERIALS, EXCAVATION) ONLY NO WORKERS EXPOSED	REQUIRED ³	OPTIQUAL ²	OP THOMAL ²	OPTIONAL ²		

- THE EXPOSURE CONDITIONS DESCRIBED IN TABLE NY1-A ASSUMES THERE IS NO POSITIVE PROTECTION (TEMPORARY TRAFFIC BARRIER) PRESENT. WHERE WORKERS OR HAZARDS ARE PROTECTED BY A TEMPORARYTRAFFIC BARRIER, BARRIER VEHICLES ARE NOT REQUIRED.
- 2. WHERE THE REQUIREMENT IS "OPTIONAL", EITHER A BARRIER VEHICLE OR THE STANDARD LONGITUDINAL BUFFER SPACE (TABLE 6C-2) SHALL BE PROVIDED.
- 3. REQUIREMENTS SHALL INCLUDE PROVIDING A SEPARATE BARRIER VEHICLE FOR EACH CLOSED LANE AND EACH CLOSED PAVED SHOULDER 8' OR GREATER IN WIDTH. IF THE WORK SPACE MOVES WITHIN THE STATIONARY CLOSURE, THE BARRIER VEHICLE SHALL BE REPOSITIONED ACCORDINGLY. BARRIER VEHICLES PROTECTING NON-TRANSVERSABLE HAZARDS SHALL REMAIN IN PLACE DURING BOTH WORKING AND NON-WORKING HOURS UNTIL THE HAZARD NO LONGER EXISTS. EXCEPTIONS TO THESE REQUIREMENTS MAY BE MADE, AS APPROVED BY THE REGIONAL DIRECTOR OR HIS/HER DESIGNEE WHERE BARRIER VEHICLE PLACEMENT WOULD BE INEFFECTIVE OR WOULD INTERFERE WITH THE SAFE OPERATION OF TRAFFIC.
- 4. BARRIER VEHICLES ARE NOT REQUIRED FOR MILLING AND/OR PAVING OPERATIONS, BUT THE STANDARD LONGITUDINAL BUFFER SPACE (TABLE 6C-2) SHALL BE PROVIDED.
- 5. BARRIER VEHICLES ARE NOT REQUIRED FOR FLAGGING OPERATIONS, BUT THE STANDARD LONGITUDINAL BUFFER SPACE (TABLE6C-2) SHALL BE PROVIDED.

TABLE NY6H-3 ADVANCE WARNING SIGN SPACING								
		DISTANCE	BETWEEN	SIGNS	SIGN I	LEGEND		
	ROAD TYPE	A (FT.)	B (FT.)	C (FT.)	XX	YY		
-	→URBAN (30 MPH*)	100	100	100	AHEAD	AHEAD	•	
	URBAN (35-40 MPH*)	200	200	200	AHEAD	AHEAD		
	URBAN (w 45 MPH*)	350	350	350	1000 FT.	AHEAD		
	RURAL	500	500	500	1500 FT.	1000 FT.		
	EXPRESSWAY / FREEWAY	1000	1500	2640	1 MILE	? MILE		

* PRECONSTRUCTION POSTED SPEED LIMIT

A. VENTAROLA, P.E.

IN CHARGE OF _

CHECKED BY _

MADE BY .

URBAN: (MEETS MORE THAN 1 OF THE FOLLOWING CRITERIA) SIDEWALKS, BICYCLE USAGE, CURBING, CLOSED DRAINAGE SYSTEMS, DRIVEWAY DENSITIES GREATER THAN 24 DRIVEWAYS PER MILE, MINOR COMMERCIAL DRIVEWAY DENSITIES OF 10 DRIVEWAYS PER MILE OR GREATER, MAJOR COMMERCIAL DRIVEWAYS, NUMEROUS RIGHT OF WAY CONSTRAINTS, HIGH DENSITY OF CROSS STREETS, 85TH PERCENTILE SPEEDS OF 45 MPH OR LESS.

RURAL: ANY AREA NOT EXHIBITING MORE THAN ONE OF THE ABOVE CHARACTERISTICS

EXPRESSWAY: DIVIDED HIGHWAYS FOR TRAFFIC WITH FULL OR PARTIAL CONTROL OF ACCESS AND GENERALLY WITH GRADE SEPARATIONS AT MAJOR CROSSROADS.

MADE


FREEWAYS/INTERSTATE: LOCAL OR INTER REGIONAL HIGH-SPEED, DIVIDED, HIGH-VOLUME FACILITIES WITH FULL OR PARTIAL CONTROL OF ACCESS.

DATE

REVISION

JUMBER

TABLE 6H-4 FORMULAS FOR DETERMINING TAPER LENGTHS											
SPEED LIMIT (MPH)	(S)		TAPER LENGTH (L) (FT.)			TARES LENGTH					
(40 MPH) OF	$L = WS^2 / 60$			L = TAPER LENGTH W = WIDTH OF OFFSET (FT.) S = PRECONSTRUCTION POSTED SPEED LIMIT (MPH)							
(45 MPH) OF	R MORE	L =	WS		, ,						
			STAN	NDARD T	APER LE	NGTHS					
LATERAL SHIFT OF TRAFFIC	TEMPORARY TRAFFIC CONTROL ZONE POSTED SPEED LIMIT										
FLOW PATH	(25 MPH)	(30 MPH)	(35 MPH)	(40 MPH)	(45 MPH)	(50 MPH)	(55 MPH)	(60 MPH)	(65 MPH)	(70 MPH)	
4	45	60	85	110	180	200	220	240	260	280	
5	55	75	105	135	225	250	275	300	325	350	
6	65	90	125	160	270	300	330	360	390	420	
7	75	105	145	190	315	350	385	420	455	490	
→ 8	85	120	165	215	360	400	440	480	520	560	
9	95	135	185	240	405	450	495	540	585	630	
10	105	150	205	270	450	500	550	600	650	700	
11	115	165	225	295	495	550	605	660	715	770	
12	125	180	245	320	540	600	660	720	780	840	

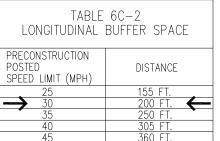

RECORD DRAWING CERTIFICATION

NAME

SIGNATURE

TITLE ____

AS BUILT - CHANGES AS NOTED

CONTRACTOR

DATE ___

AS BUILT - NO CHANGES

SIGNATURE

TITLE ___

495 FT

PROJECT COORDINATOR

DATE ___

WORK DURATION DEFINITIONS

LONG-TERM STATIONARY IS WORK THAT OCCUPIES A LOCATION MORE THAN 3 CONSECUTIVE DAYS.

INTERMEDIATE-TERM STATIONARY IS WORK THAT OCCUPIES A LOCATION MORE THAN ONE DAYLIGHT PERIOD UP TO 3 CONSECUTIVE DAYS, OR NIGHTTIME WORK LASTING MORE THAN 1 HOUR.

SHORT-TERM STATIONARY IS DAYTIME WORK THAT OCCUPIES A LOCATION FOR MORE THAN 1 HOUR WITHIN A SINGLE DAYLIGHT PERIOD.

SHORT DURATION IS WORK THAT OCCUPIES A LOCATION UP TO 1 HOUR.

MOBILE IS WORK THAT MOVES INTERMITTENTLY OR CONTINUOUSLY.

WC	RK ZONE TRAFFIC CONTROL LEGEND						
SYMBOL	DESCRIPTION	•	LUMINAIRE				
0,0000	ARROW PANEL	11111	PAVEMENT MARKINGS THAT SHALL BE REMOVED FOR A LONG TERM PROJECT				
• •	ARROW PANEL, CAUTION MODE	ŀ	SIGN, TEMPORARY				
888	ARROW PANEL TRAILER OR SUPPORT		TEMPORARY BARRIER				
Н	CHANGEABLE MESSAGE SIGN (PVMS)		TEMPORARY BARRIER WITH WARNING LIGHTS				
	CHANNELIZING DEVICE	F	TRAFFIC OR PEDESTRIAN SIGNAL				
	CRASH CUSHION/TEMPORARY IMPACT ATTENUATOR		TYPE III BARRICADE				
L	DIRECTION OF TEMPORARY TRAFFIC DETOUR	2	WARNING LIGHTS				
\Rightarrow	DIRECTION OF TRAFFIC		WORK SPACE				
	FLAGGER		WORK VEHICLE				
• •	FLAG TREE		WORK VEHICLE WITH TRUCK MOUNTED ATTENUATOR				
DRAWING CERTIF	CATION WEST	CHESTER COI	UNTY, NEW YORK CONTRACT SHEET NUMBER NUMBER				

DEPARTMENT OF PUBLIC WORKS AND TRANSPORTATION

MISCELLANEOUS ROADWAY IMPROVEMENTS

WARBURTON AVENUE (C.R. #751)

VILLAGE OF HASTINGS ON HUDSON, NEW YORK

BASIC WORK TRAFFIC CONTROL NOTES

DIVISION OF ENGINEERING

NUMBER 16-526

SHEET NO. 4 OF 55

SCALE: AS SHOWN

DATE: 3/15/2018

DPW FILE NO.

XX-XX-T-XX-0

Basic Work Traffic Control

- Basic Work Traffic Control shall be provided in accordance with section 619 of the NYS Standard Specifications and the 2009 edition MUTCD (including the 2010 NYS Supplement), and subsequent addenda, and any provisions contained in the plans and/or proposal of this contract.
- 2. The Contractor shall be responsible for all basic work zone traffic control. Maintenance of traffic schemes shall be in accordance with the plans and as approved or directed by the Engineer. Traffic schemes shown on the plans are to be considered minimum requirements. The Engineer may order additional signs, flaggers, cones, reflectorization etc., if deemed necessary at no additional cost to the County. Payment for all such work shall be included in the Series 619 items.
- Prior to the start of work, the Contractor may submit any proposed changes to the traffic control plan to the Engineer for approval. Any changes which alter the basic concept of the plan must be approved by the Engineer.
- 4. The Contractor must notify the Engineer, and all municipalities, police department, and fire departments involved of all work that might affect the mobility or access of the fire or police department 48 hours in advance of their implementation. In addition, the contractor shall ensure that hydrants and alarm boxes are kept clear and accessible.
- The Contractor shall provide a flagger with appropriate signing whenever operations interfere with traffic. Examples include, but are not limited to: delivery and removal of materials, lift operations, restricted sight distances, impedance of normal traffic flow and other activities. Cost shall be included in item 619.01.
- All single type III construction barricades and drums shall be of like new condition and shall require type C - Low Intensity", steady lights unless other wise noted on the plans.
- 7. Type A flashing low intensity warning lights shall be mounted on the first three drums in a taper. Cost to be included under item 619.01.
- For nighttime work, Type B flashing high intensity warning lights shall be mounted on all warning signs ("w-series"). Cost to be included under item 619.01.
- Pedestrian access to businesses must be maintained throughout the construction process. In order to maintain access to existing building, the Contractor must provide ramps with handrails if the sidewalk is not passable.
- The maintenance of traffic for both pedestrians and vehicles shall be the responsibility of the Contractor.
- 11. When necessary the Contractor shall construct temporary ramps, crossovers, etc. to permit safe and easy passage through the contract area. He shall provide suitable areas and locations from the loading


and unloading of passengers on roads within the contract limits that are serviced by motor buses. The Contractor shall be liable and responsible for the materials and workmanship required to provide adequate and safe crossing structures for pedestrians.

Construction Signage

- 12. All construction signs shall have a fluorescent orange background and black letters and border unless otherwise specified, orange construction sign material requirements shall be: 1) Scotchlite durable fluorescent diamond grade sheeting (3924/g orange) as manufactured by the 3m company, or 2) Stimsomite's fluorescent orange high-performance grade retroflective sheeting no. 4370, or approved equal. Sign materials must be in compliance with most recent version of NYSDOT specifications and MUTCD/NYS Supplement. All signs are to be in good condition with Type IV characters. Faded and deteriorated panels, as well as non-standard text will not be acceptable.
- The contractor shall erect signs to provide proper horizontal and vertical clearances.
- 14. As per the MUTCD and NYS Supplement, the following stipulations shall apply unless otherwise specified by the Engineer:
 - A. Where signs are shown in both diamond and rectangular shapes, only diamond shapes will be permitted, except in median applications where the rectangular signs will be used as specified by the Engineer.
 - B. Where signs are shown in alternate sizes, the largest size must be used unless otherwise specified by the Engineer, or as shown on the plans.
- 15. In addition to the signing shown on the Basic Work Traffic Control plans, the Contractor shall also erect G11-1C, "road work, next ___ miles" signs. The Contractor shall also erect W8-1D, "road work ahead" signs at intersecting cross streets within the contract limits. Payment for these signs will be made under Item 619.xx.
- The contractor shall place W4-1 "bump" signs, W4-2 "dip" signs and/or W4-4 "rough road" signs where directed by the Engineer.
- 17. The Contractor's attention is directed to subsections 619-3.02H of the standard specifications. Existing traffic signs and construction signs within the work area which are no longer needed, even temporarily, or are conflicting, inappropriate or confusing, shall be removed (subject to the approval of the engineer) or shall be covered completely with an opaque material, the cost of this work shall be included in the price bid for the maintenance and protection of traffic item.
- Type B High Intensity, flashing lights are required on all W20 Advance Warning Signs.


NOTES:


- WHEN CROSSWALKS OR OTHER PEDESTRIAN FACILITIES ARE CLOSED OR RELOCATED, TEMPORARY FACILITIES SHALL BE DETECTABLE AND SHALL INCLUDE ACCESSIBILITY FEATURES CONSISTENT WITH THE FEATURES PRESENT IN THE EXISTING FACILITY.
- 2. CURB PARKING SHALL BE PROHIBITED FOR AT LEAST 50' IN ADVANCE OF THE MID-BLOCK CROSSWALK.
- PEDESTRIAN TRAFFIC SIGNAL DISPLAYS CONTROLLING CLOSED CROSSWALKS SHOULD BE COVERED OR DEACTIVATED.
- ONLY THE WORK ZONE TRAFFIC CONTROL DEVICES RELATED TO PEDESTRIANS ARE SHOWN. OTHER DEVICES, SUCH AS LANE CLOSURE SIGNING OR ROAD NARROWS SIGNS (W5-4), MAY BEUSED TO CONTROL VEHICULAR TRAFFIC.
- 5. FOR NIGHTTIME CLOSURES, FLASHING WARNING LIGHTS SHALL BE USED ON BARRICADES SUPPORTING SIGNS AND CLOSING SIDEWALKS.
- FOR LONG-TERM STATIONARY WORK, THE DOUBLE YELLOW CENTERLINE AND/OR LANE LINES SHOULD BE REMOVED BETWEEN THE TEMPORARY CROSSWALK LINES.
- 7. AREA SHALL BE RECONSTRUCTED TO BE ACCESSIBLE TO PEDESTRIANS.
- 8. ALL MID-BLOCK CROSSINGS REQUIRE THE APPROVAL OF THE REGIONAL DIRECTOROR HIS/HER DESIGNEE.
- 9. TYPE II BARRICADES MAY BE SUBSTITUTED FOR TYPE III BARRICADES AS PER 619 STANDARD SPECIFICATIONS.

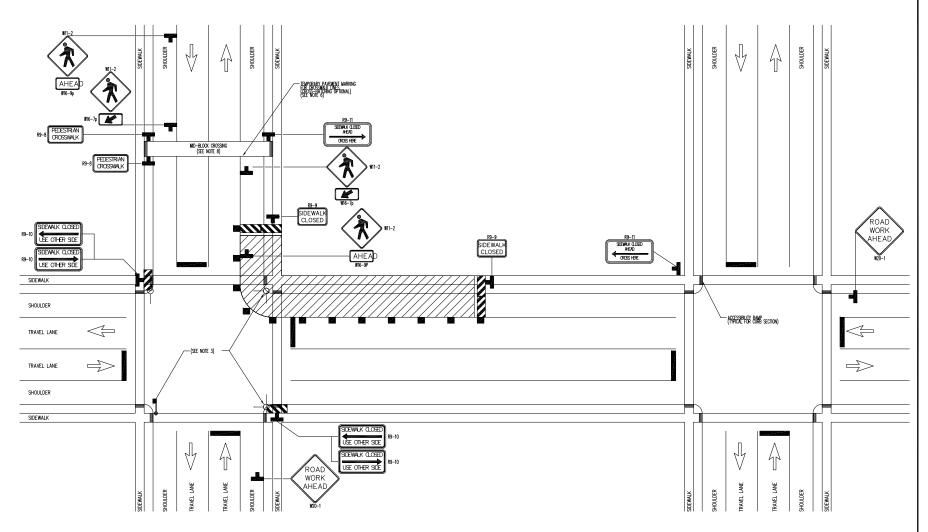



CROSSWALK CLOSURE AND PEDESTRIAN DETOUR SHORT, INTERMEDIATE, OR LONG TERM STATIONARY CROSSWALK CLOSURE ON 2-LANE 2-WAY ROADWAY (NOT TO SCALE)


SHEET NUMBER RECORD DRAWING CERTIFICATION WESTCHESTER COUNTY, NEW YORK 5 16-526 AS BUILT - CHANGES AS NOTED DEPARTMENT OF PUBLIC WORKS AND TRANSPORTATION AS BUILT - NO CHANGES DIVISION OF ENGINEERING SHEET NO. 5 OF 55 A. VENTAROLA, P.E. CONTRACTOR PROJECT COORDINATOR MISCELLANEOUS ROADWAY IMPROVEMENTS SCALE: AS SHOWN IN CHARGE OF S. LOPANE DATE: 3/15/2018 WARBURTON AVENUE (C.R. #751) NAME CHECKED BY VILLAGE OF HASTINGS ON HUDSON, NEW YORK DPW FILE NO. SIGNATURE SIGNATURE K. SITZMAN MADE BY REVISION MADE DATE REVISION XX-XX-T-XX-0 TITLE ____ TITLE ____ DATE ___ DATE ___ BASIC WORK TRAFFIC CONTROL PLANS I

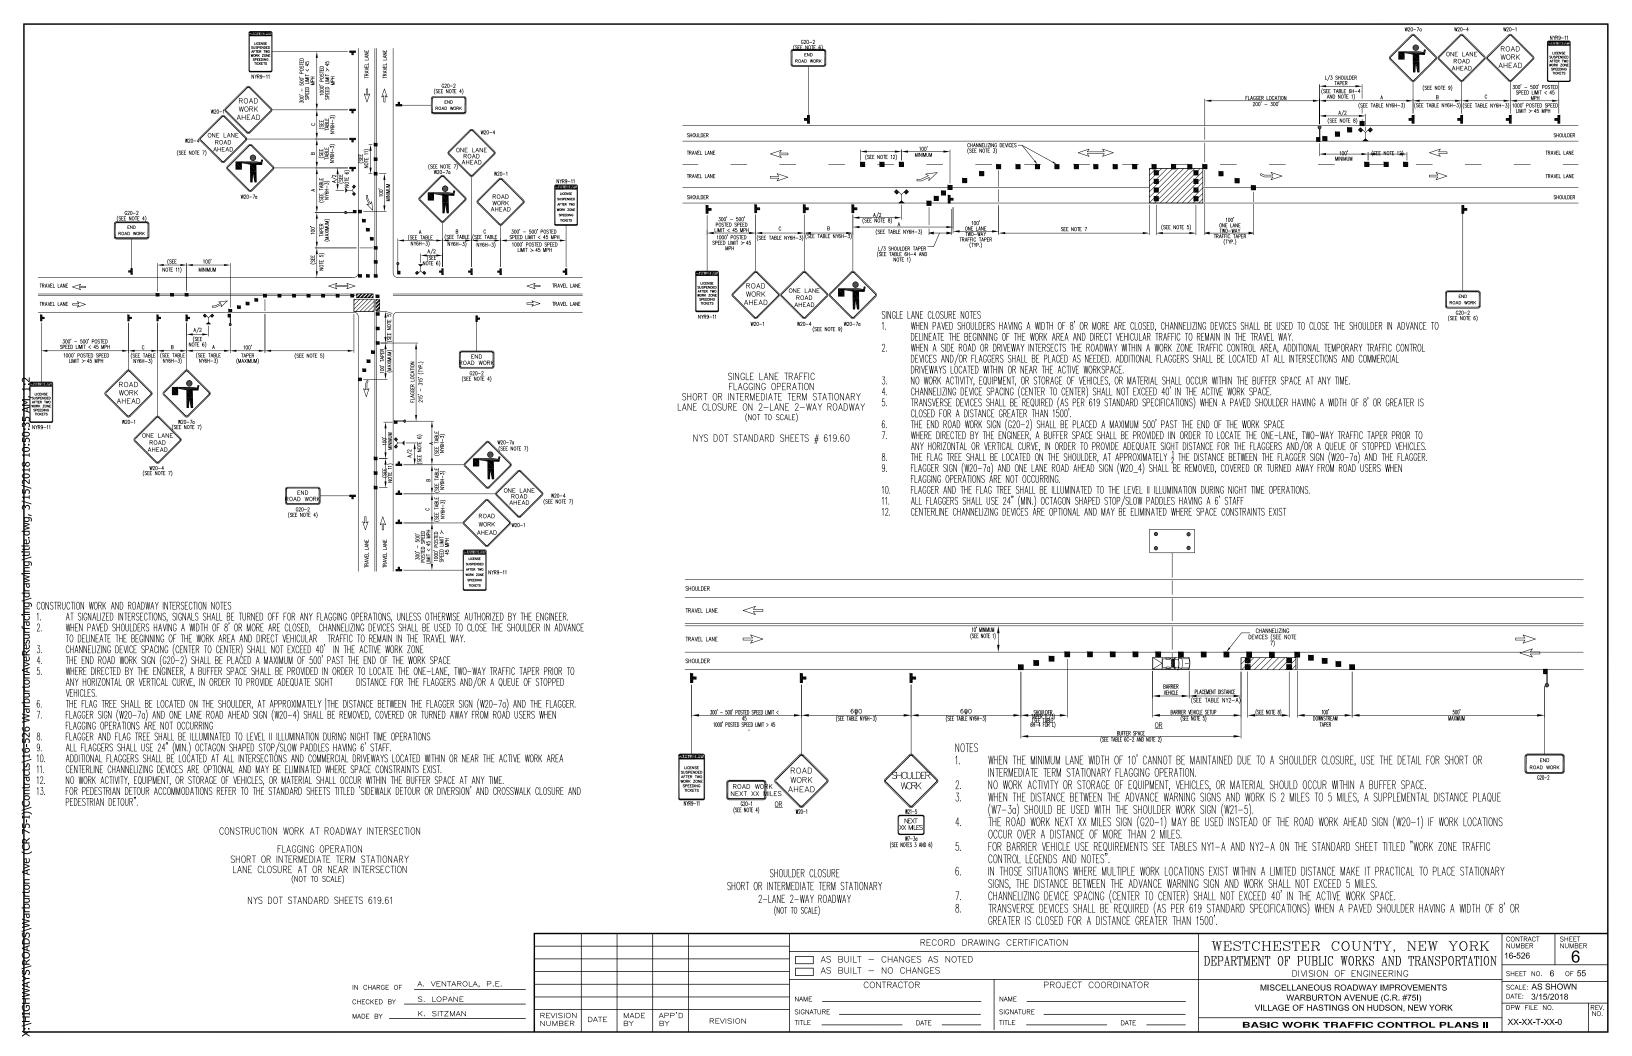


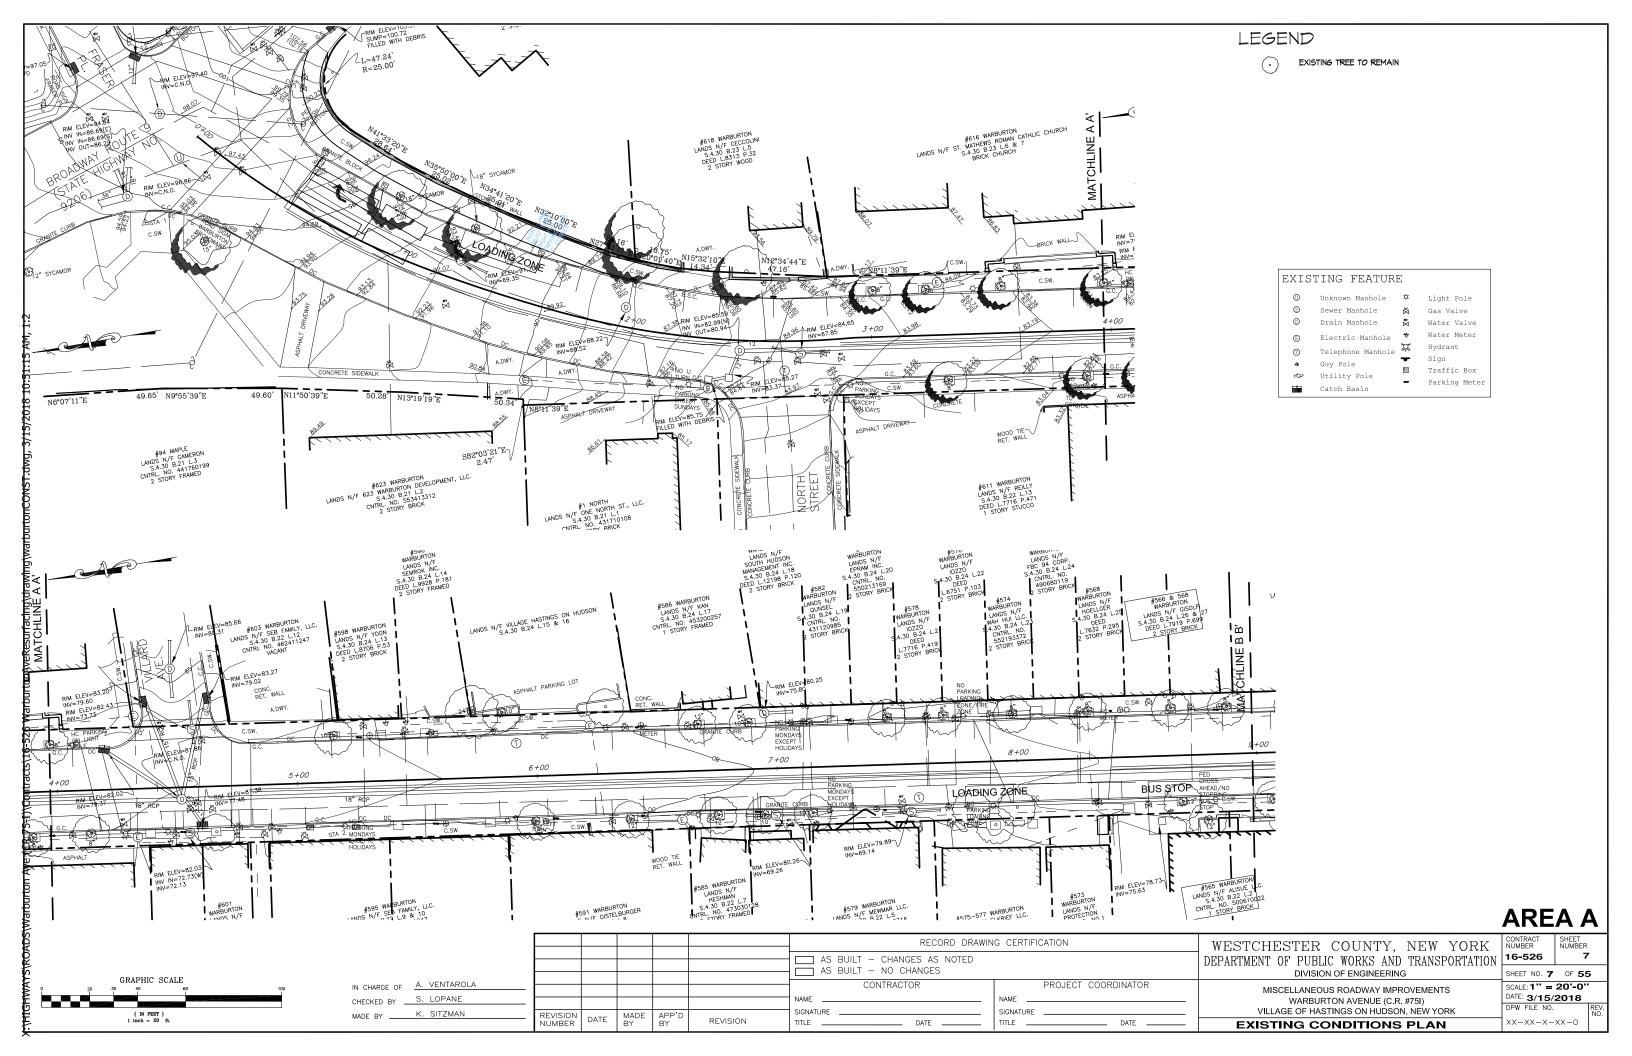


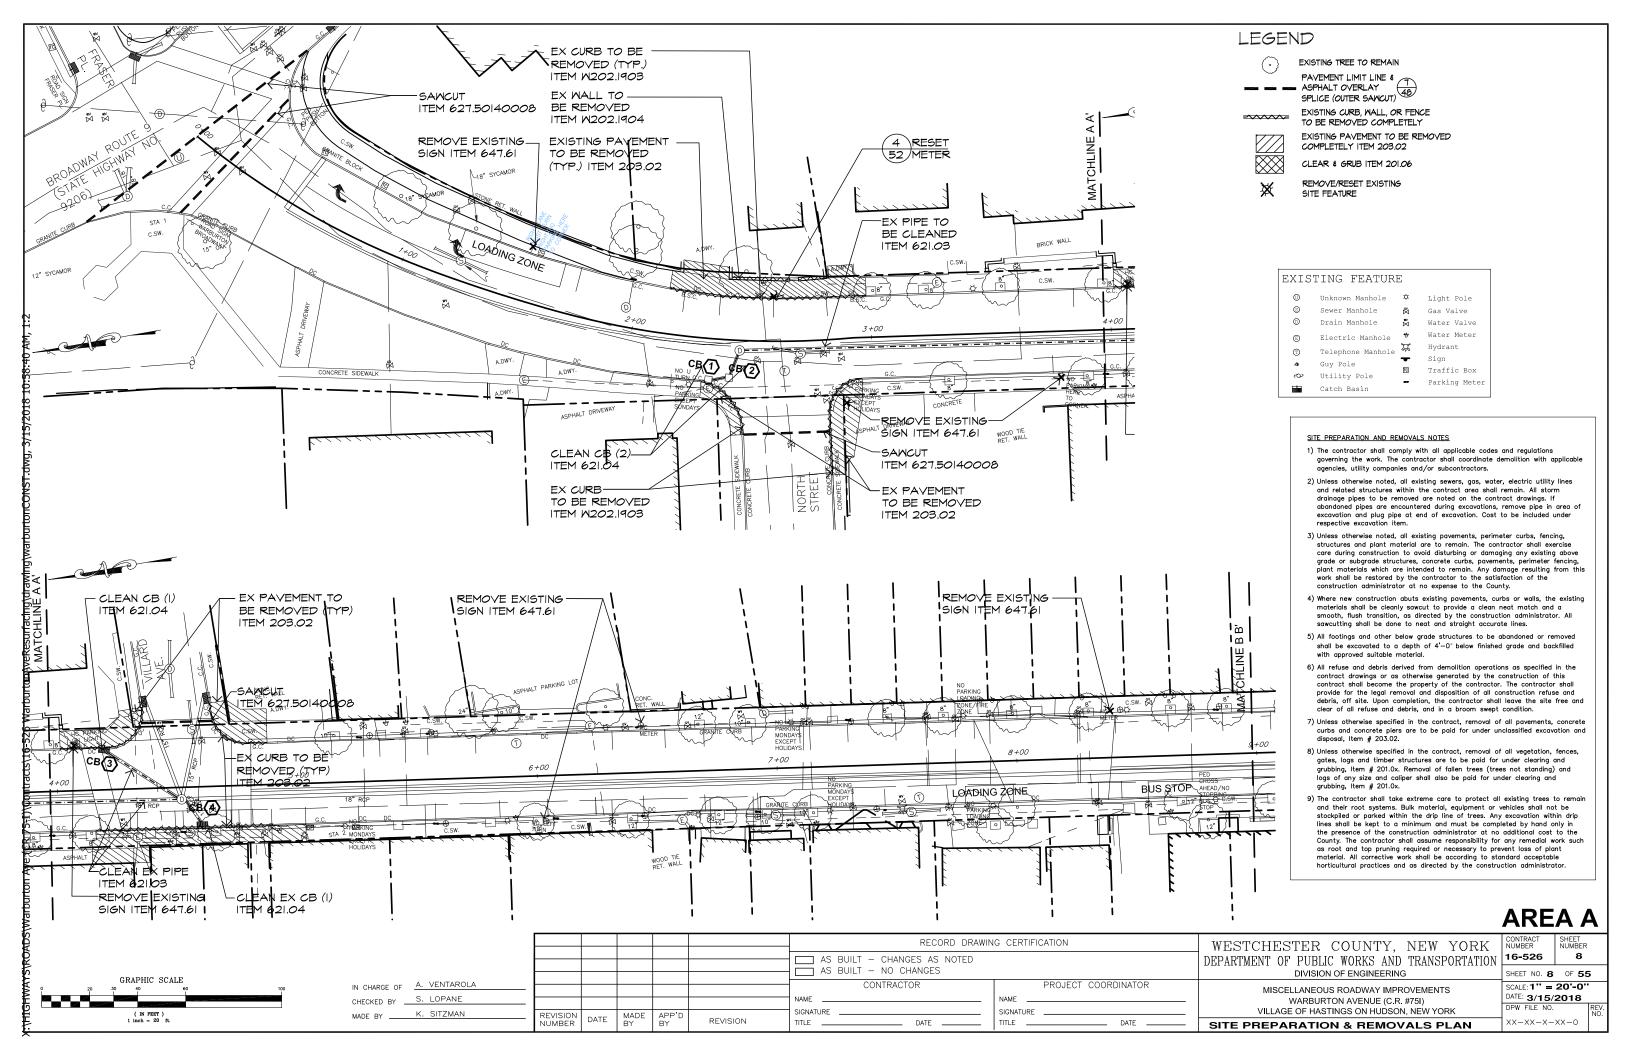


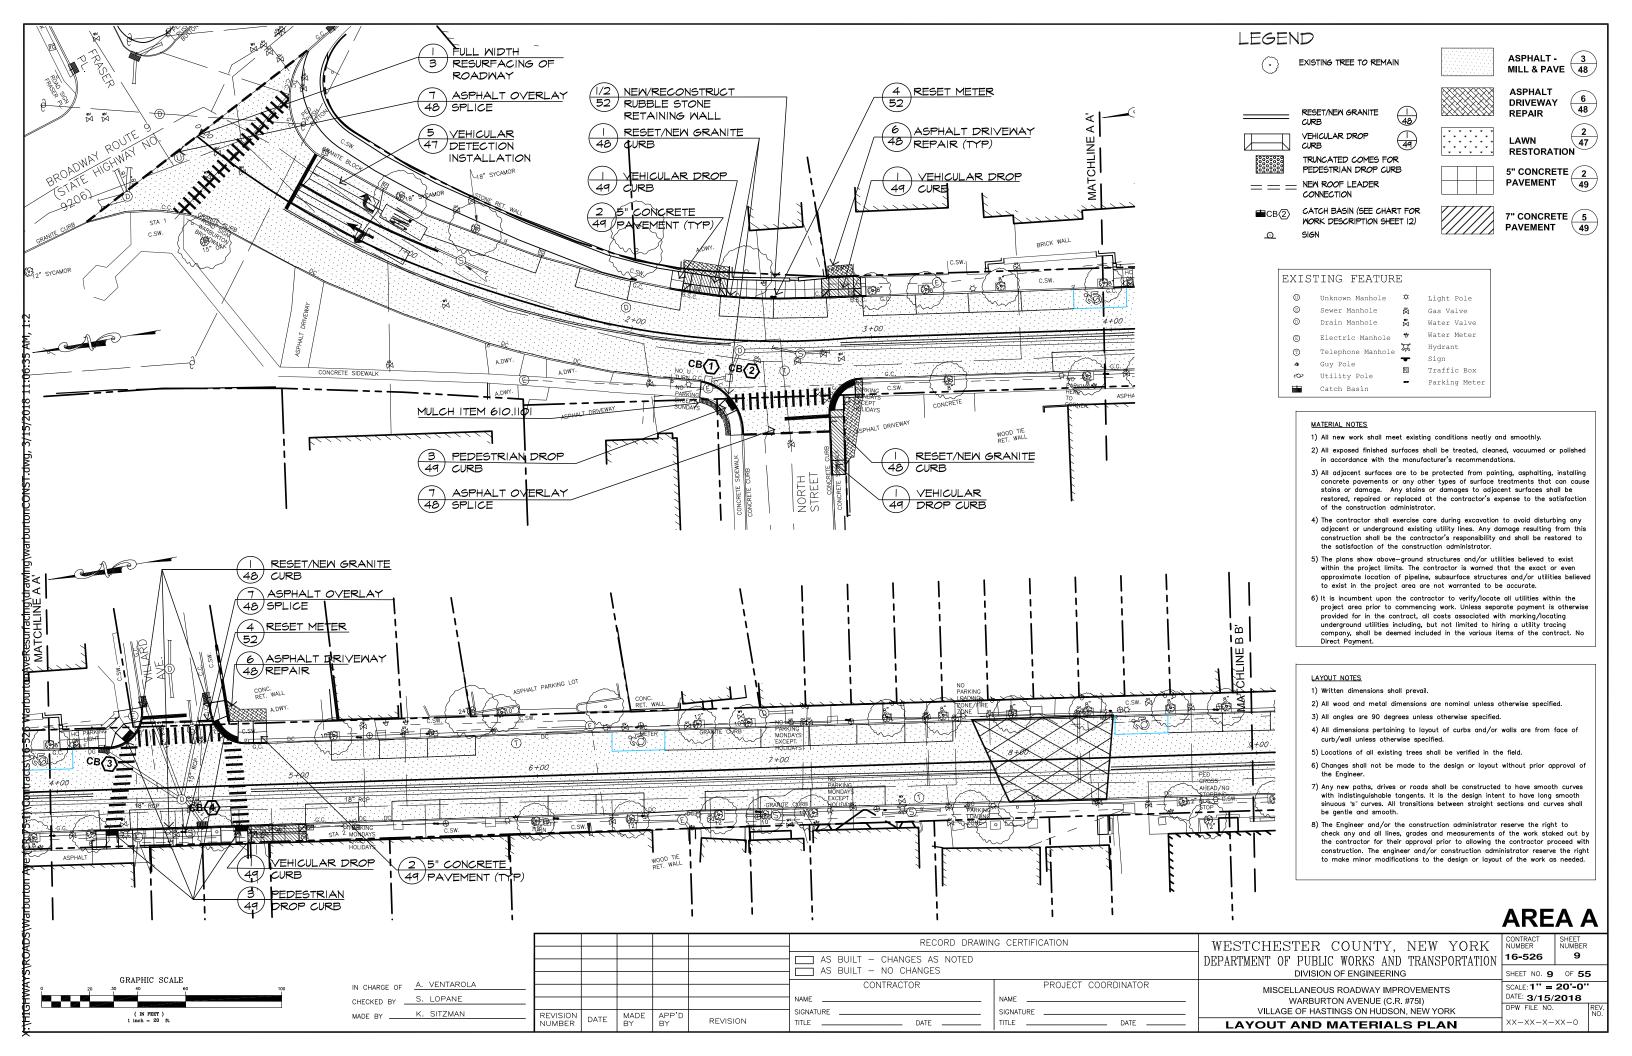


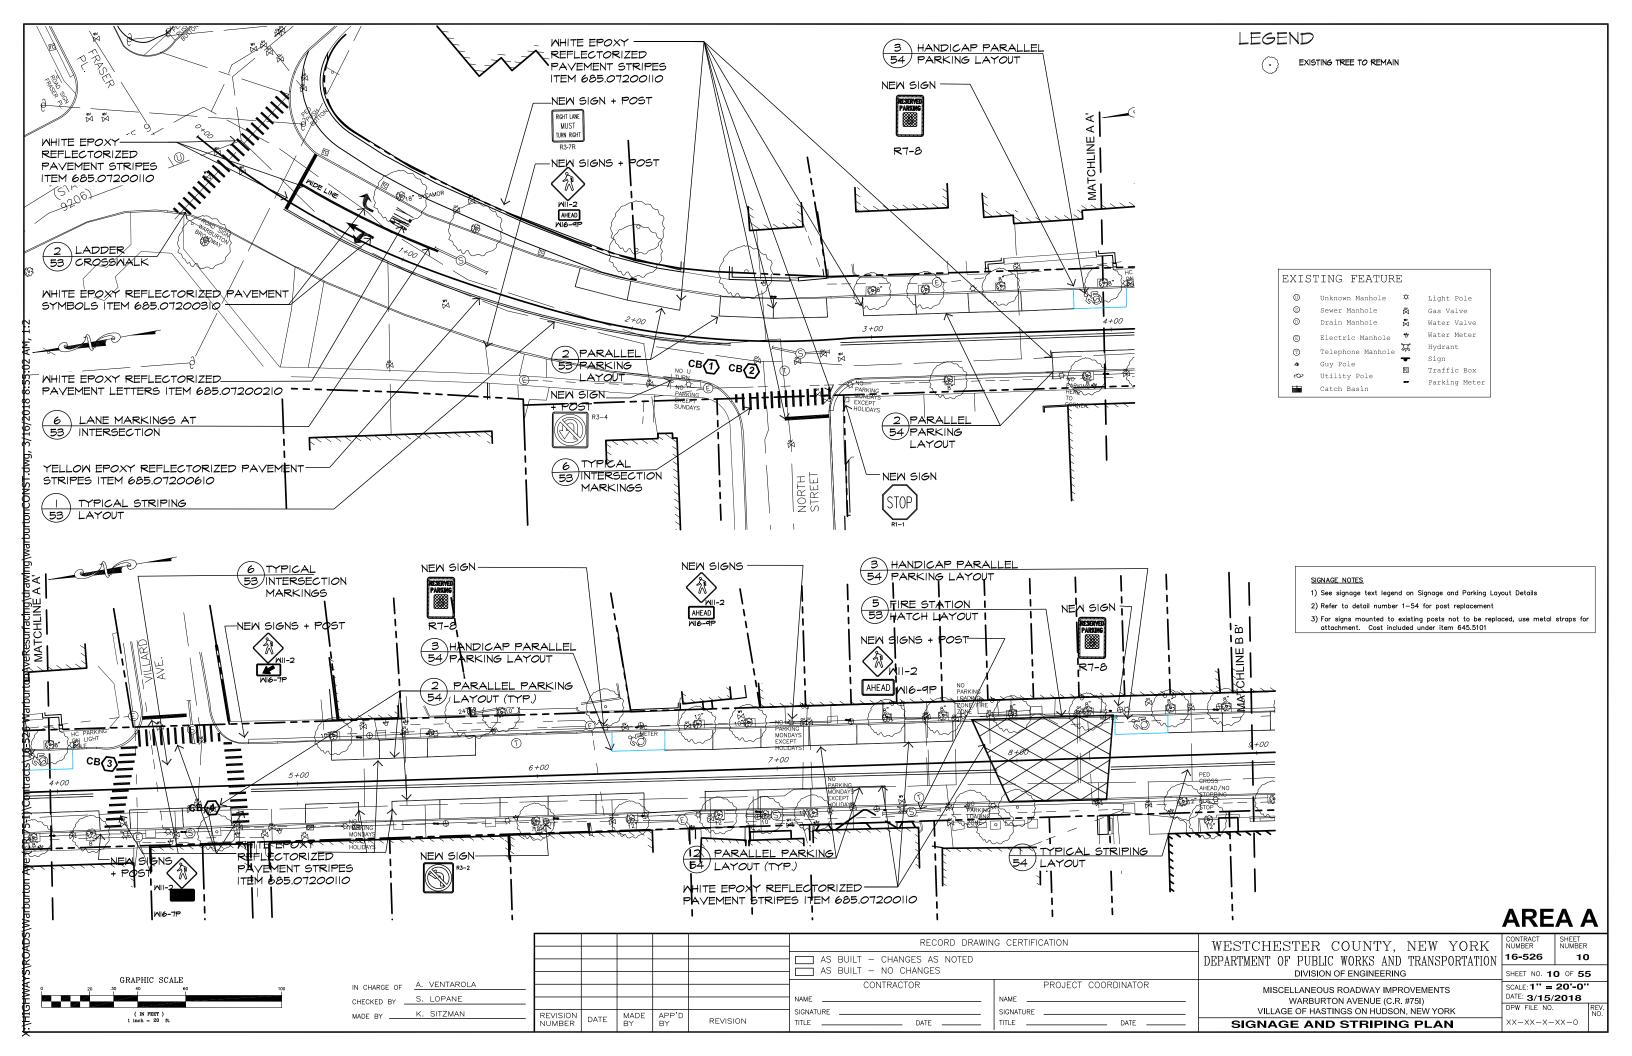


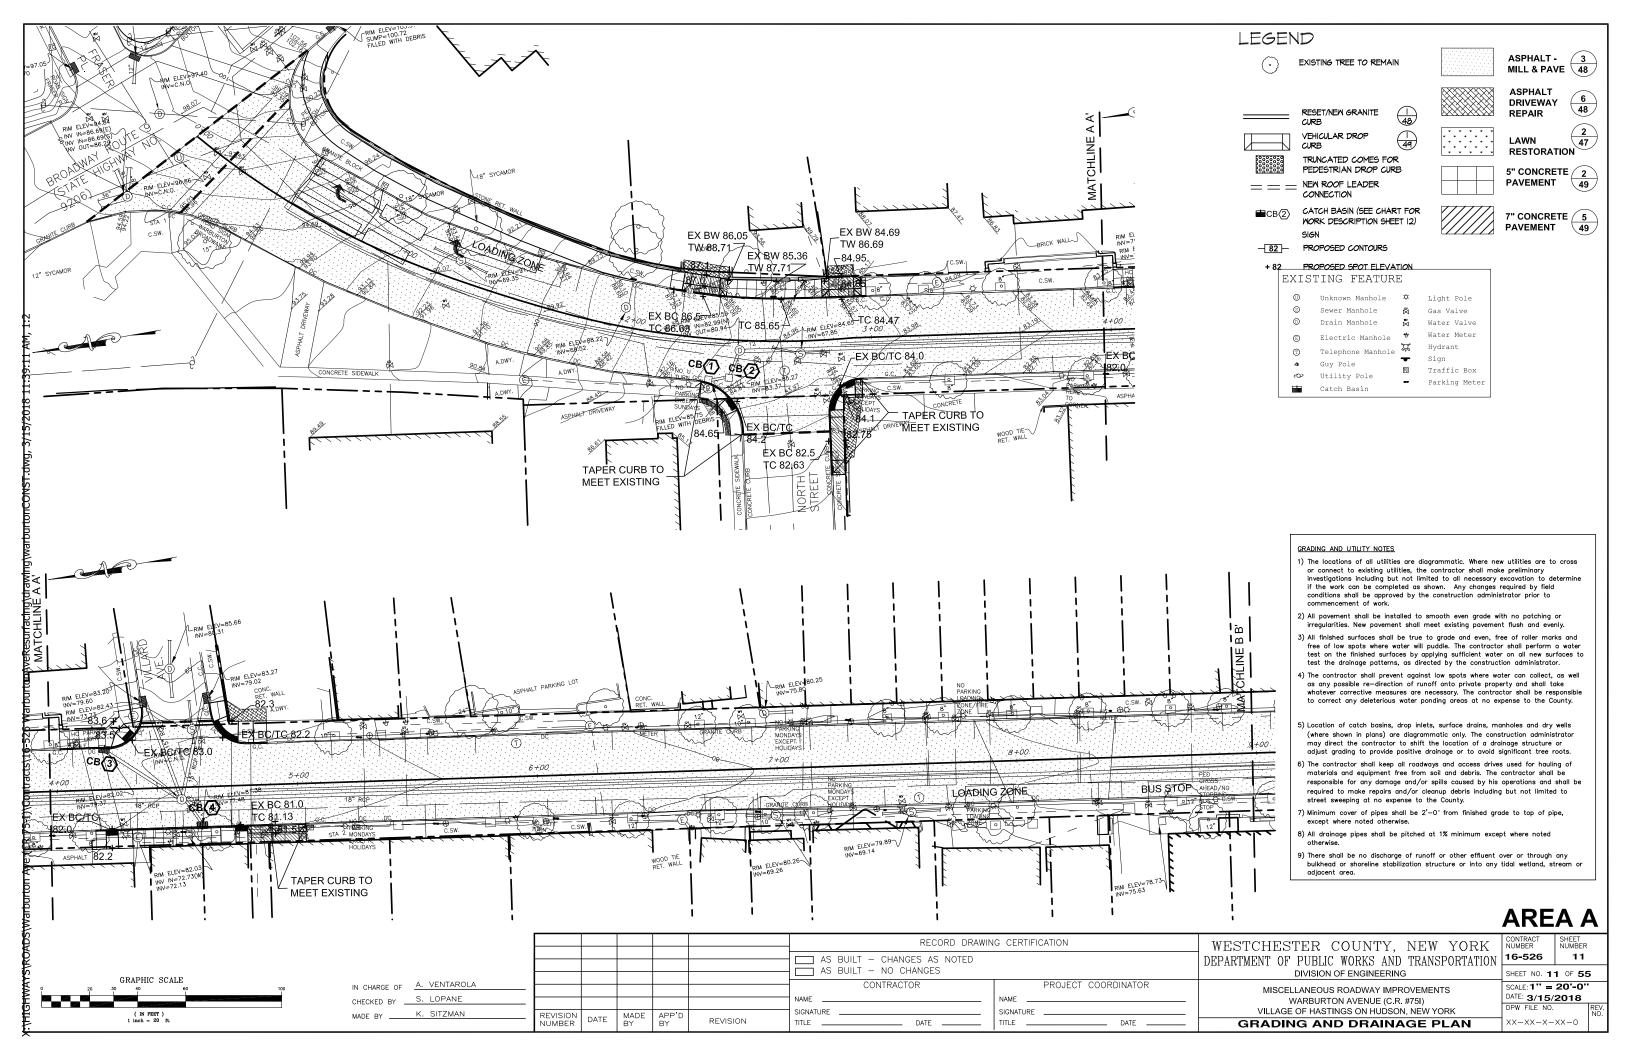


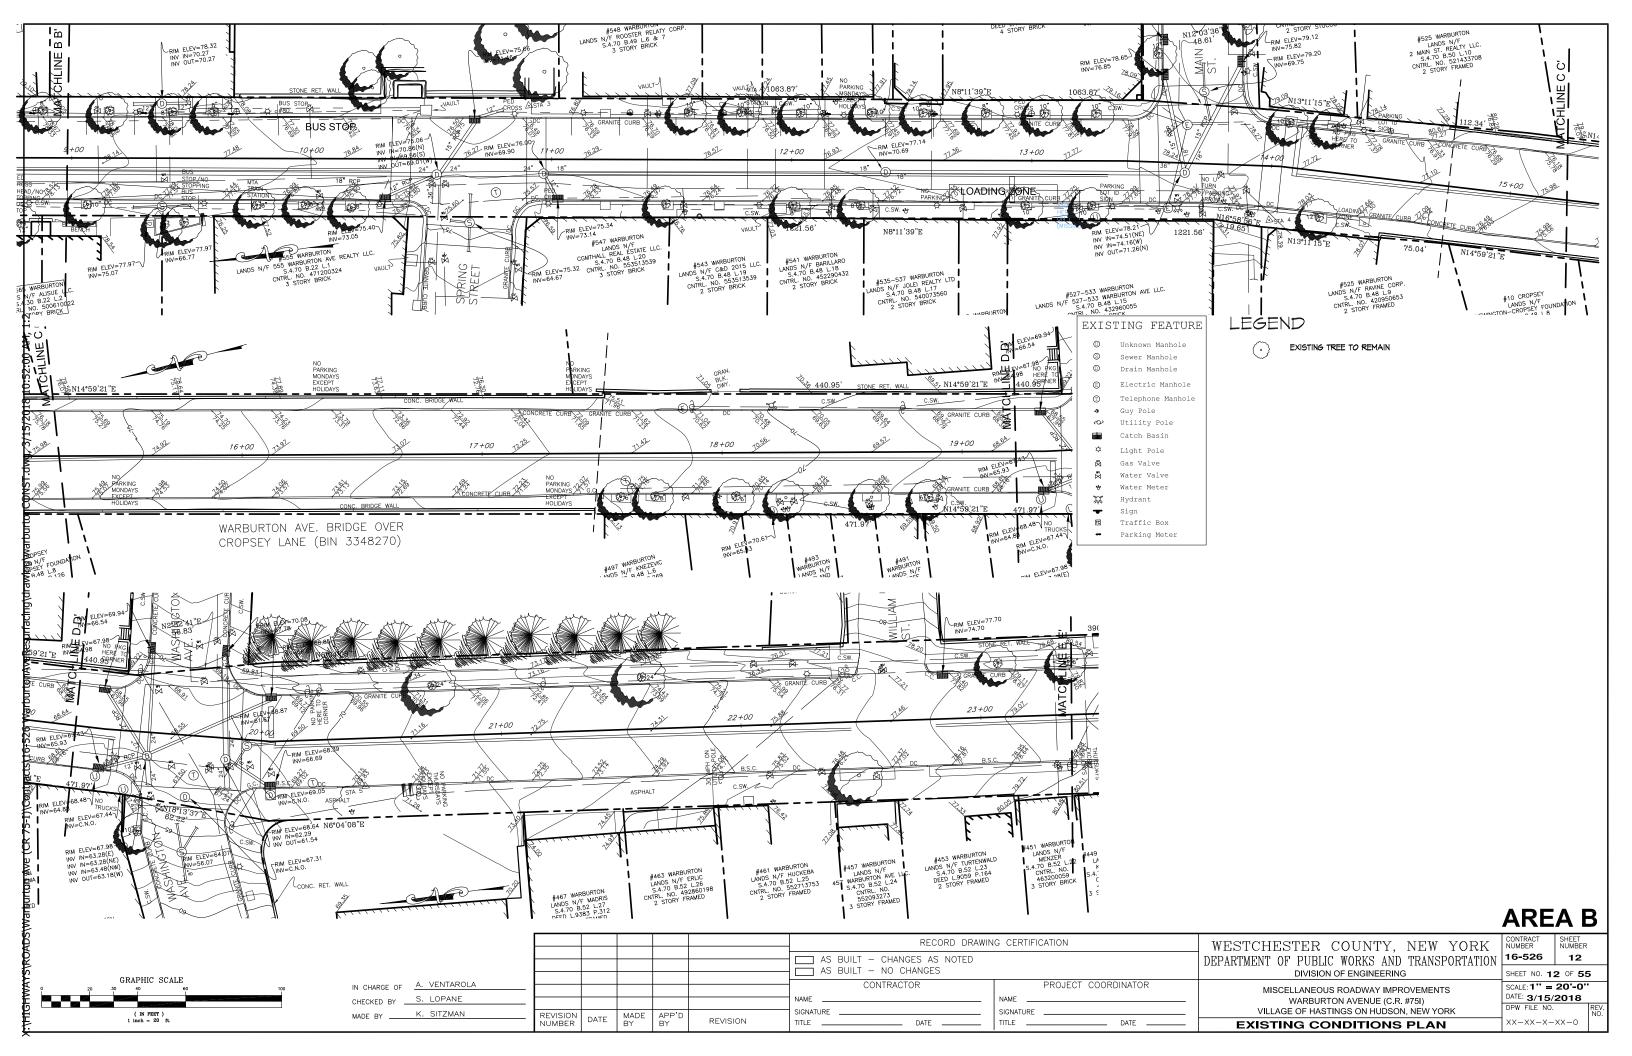


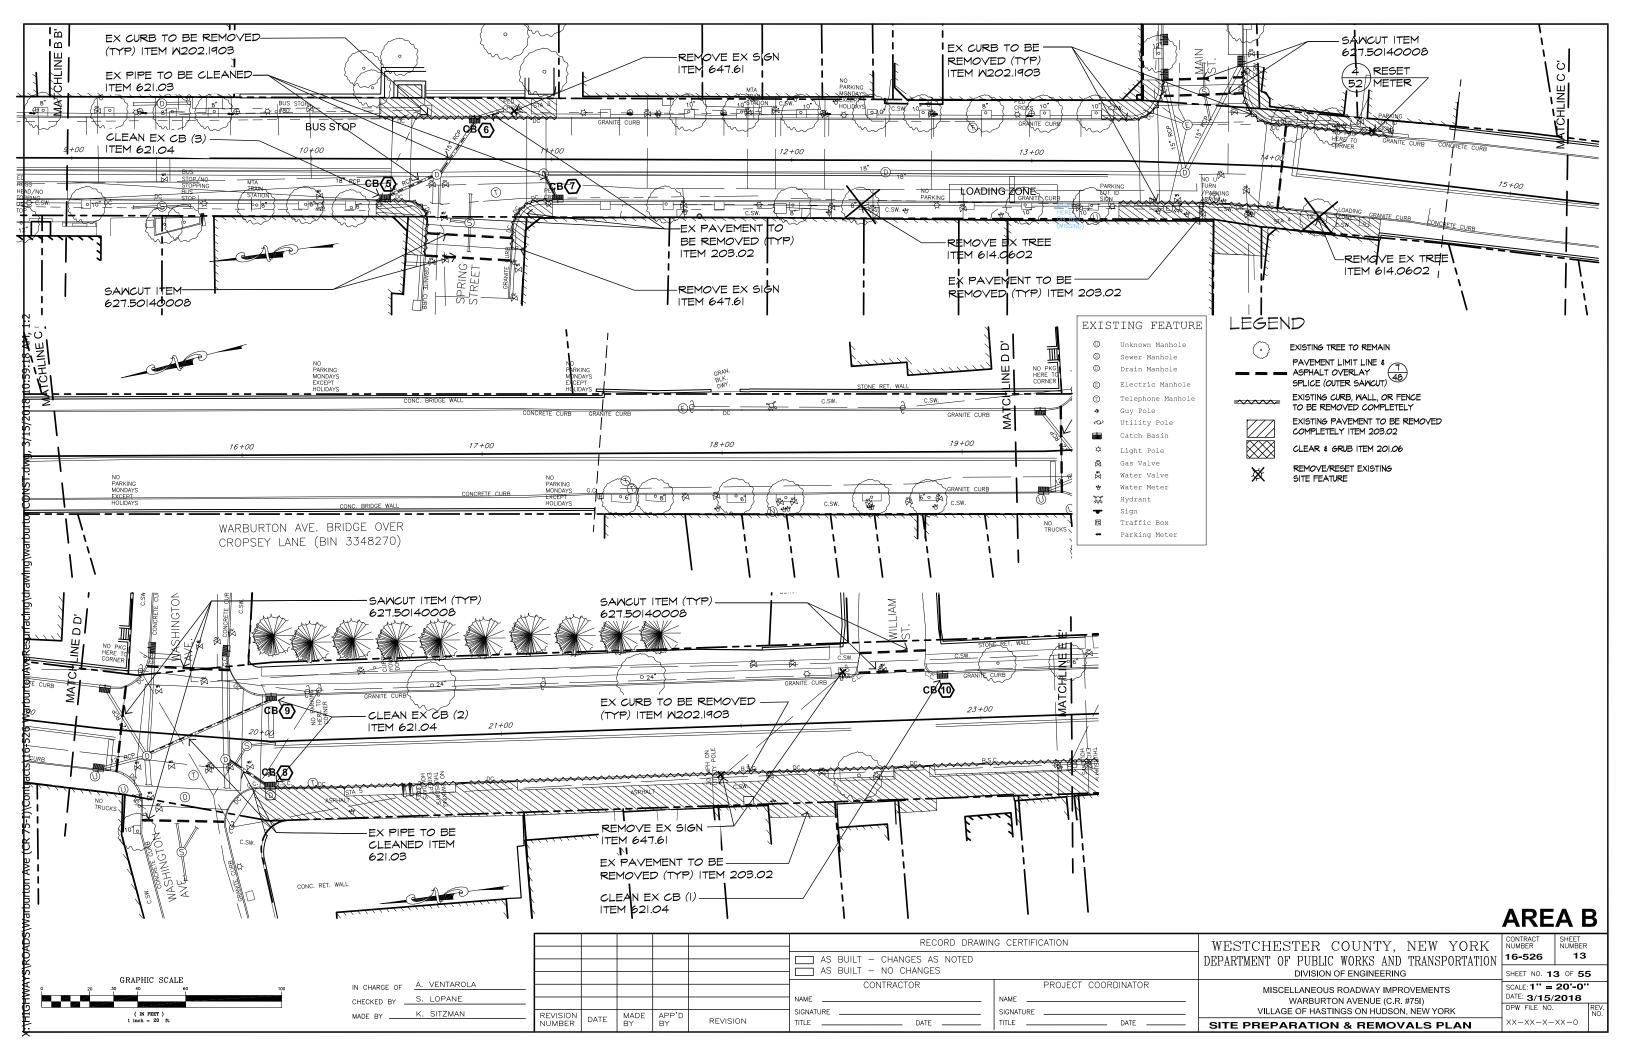


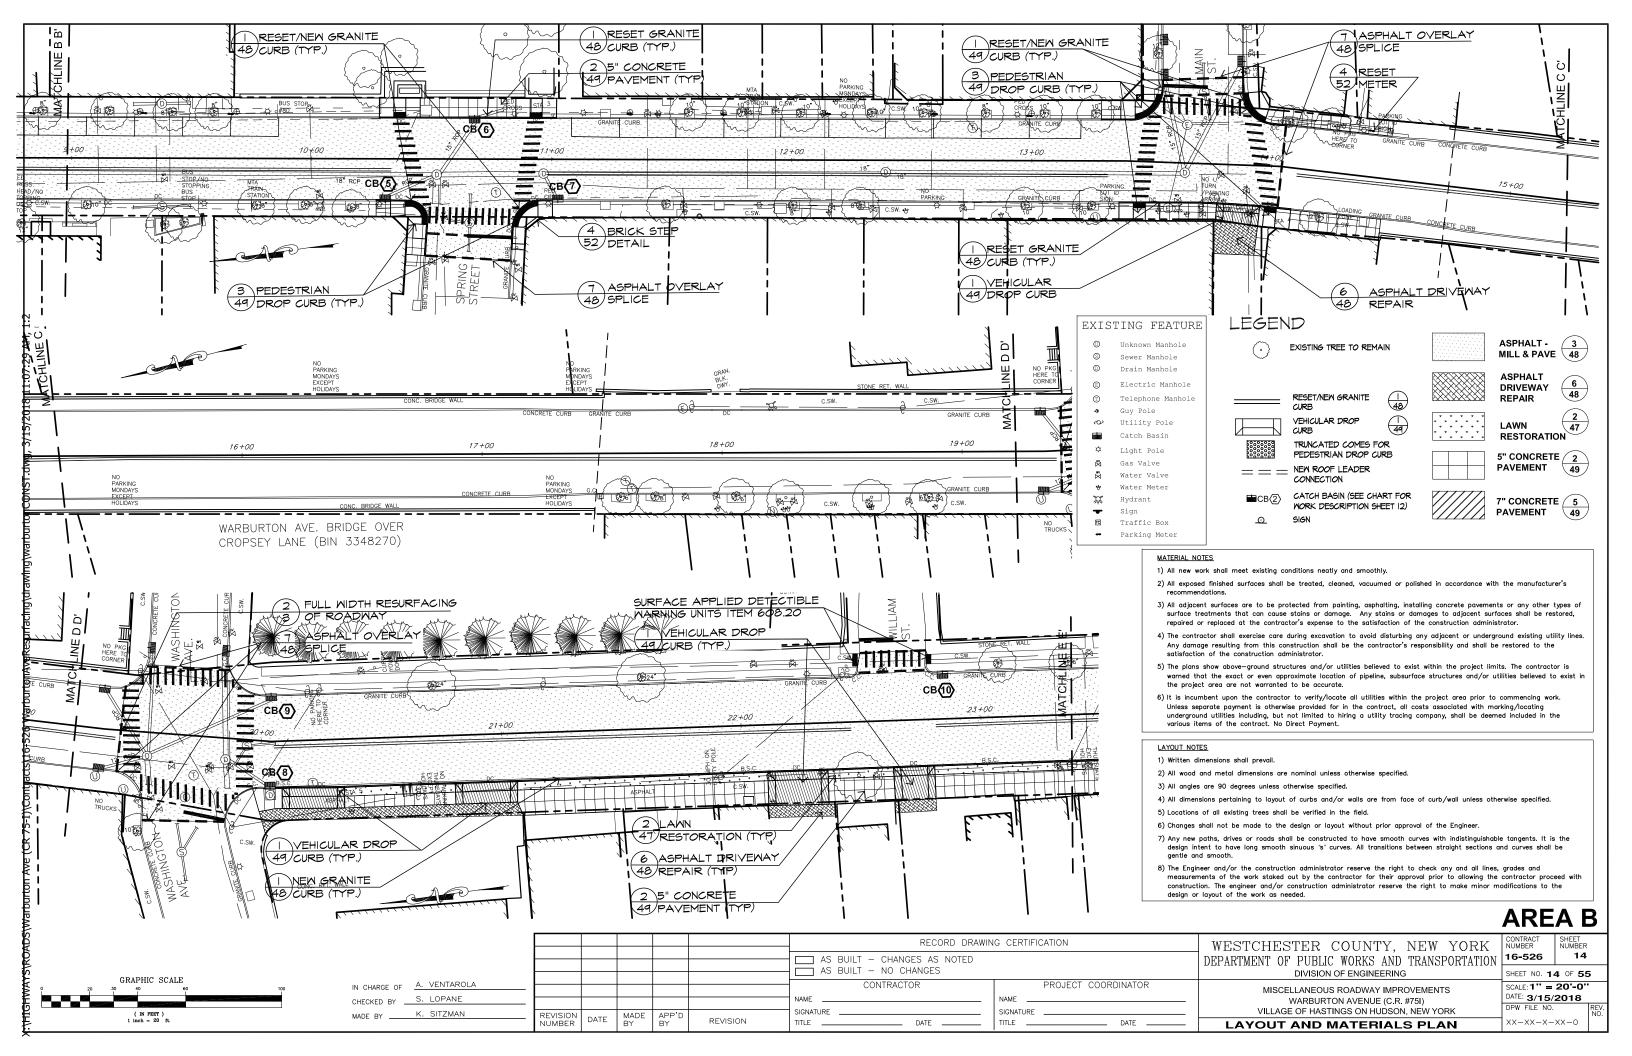


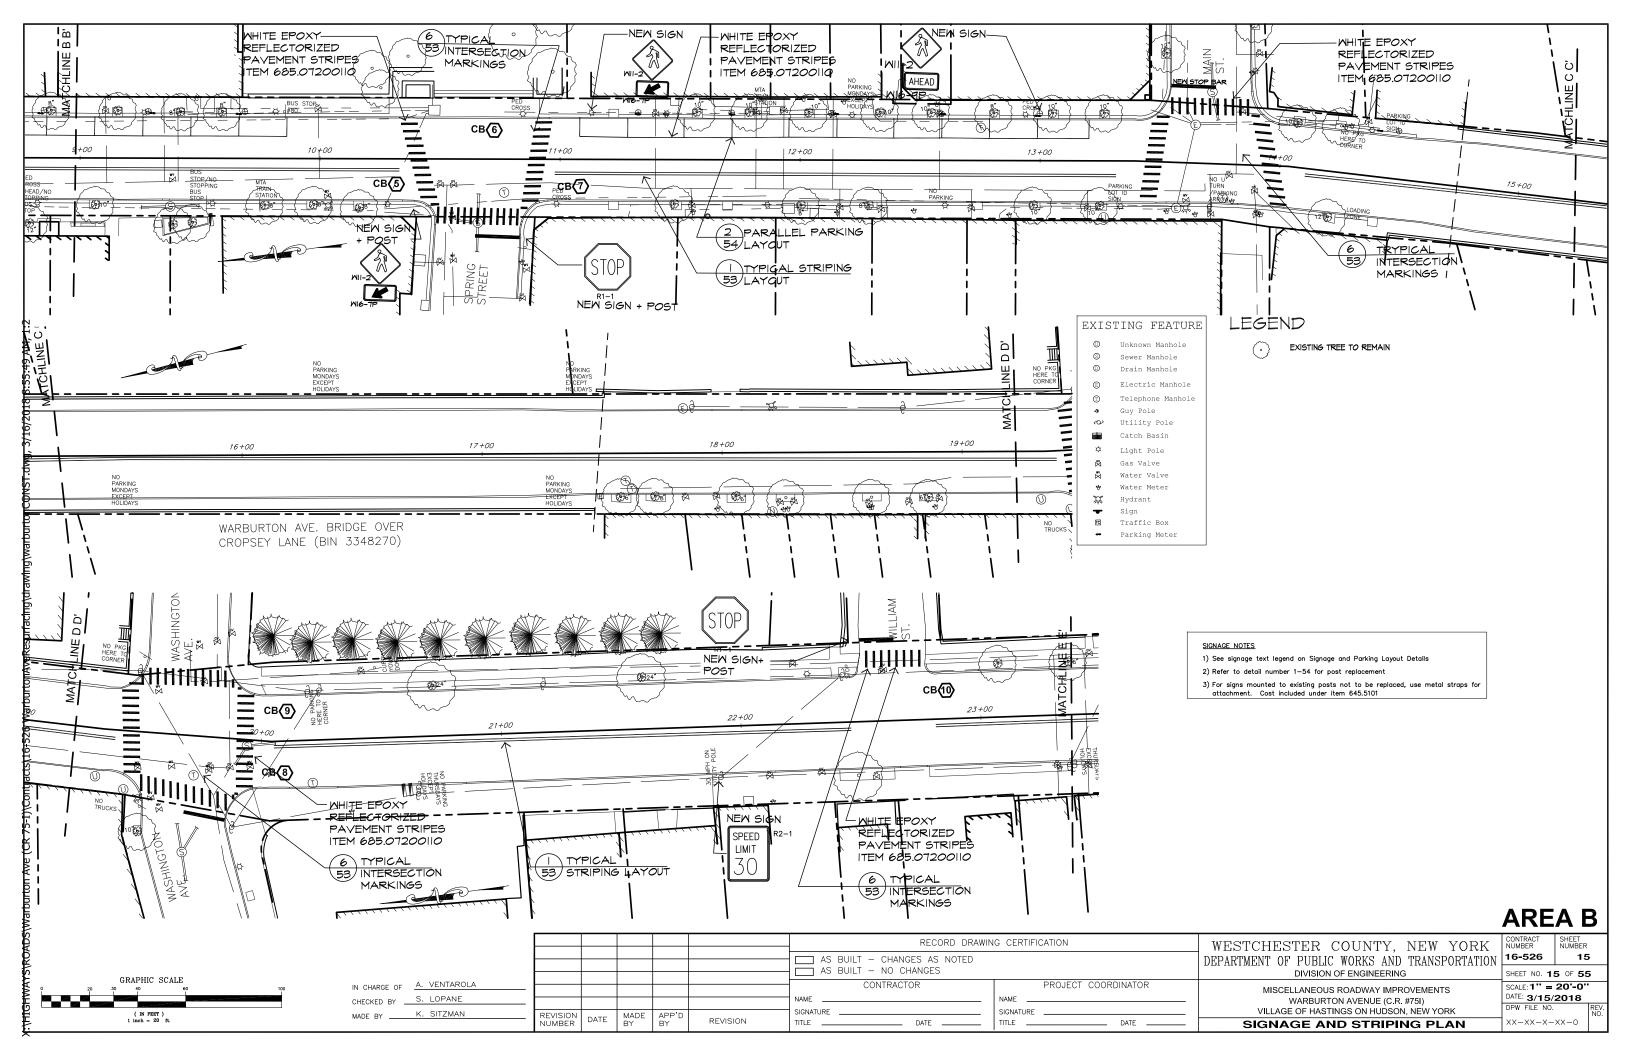


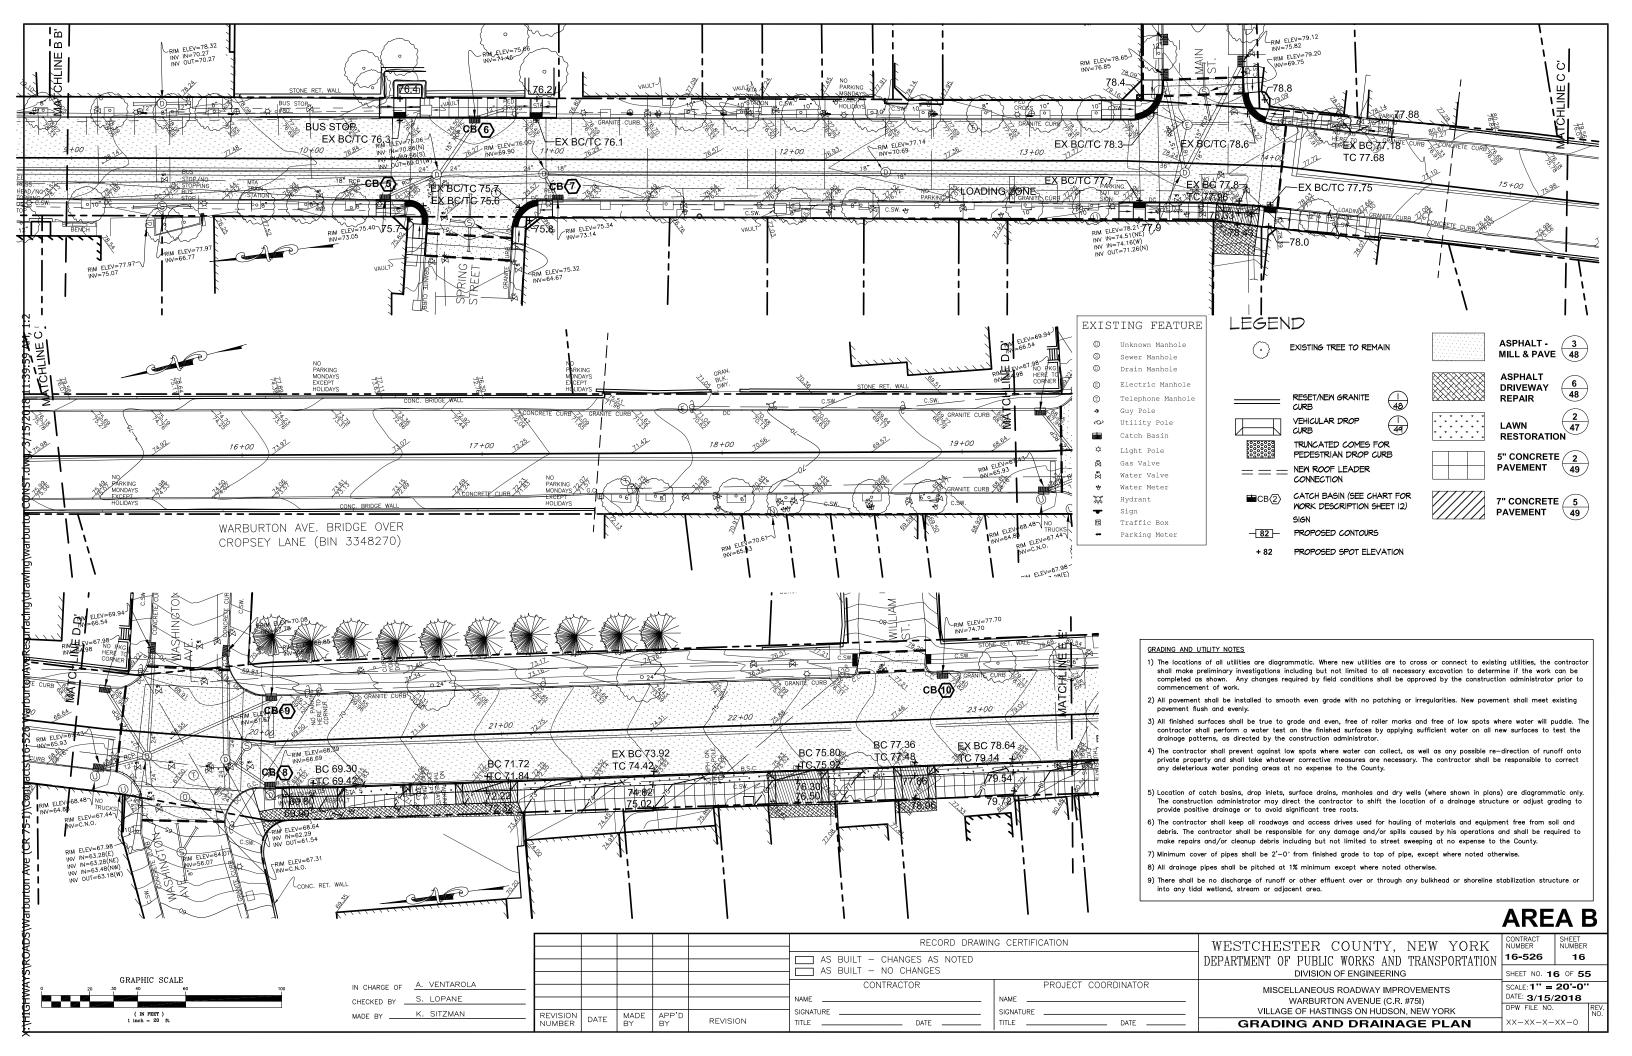


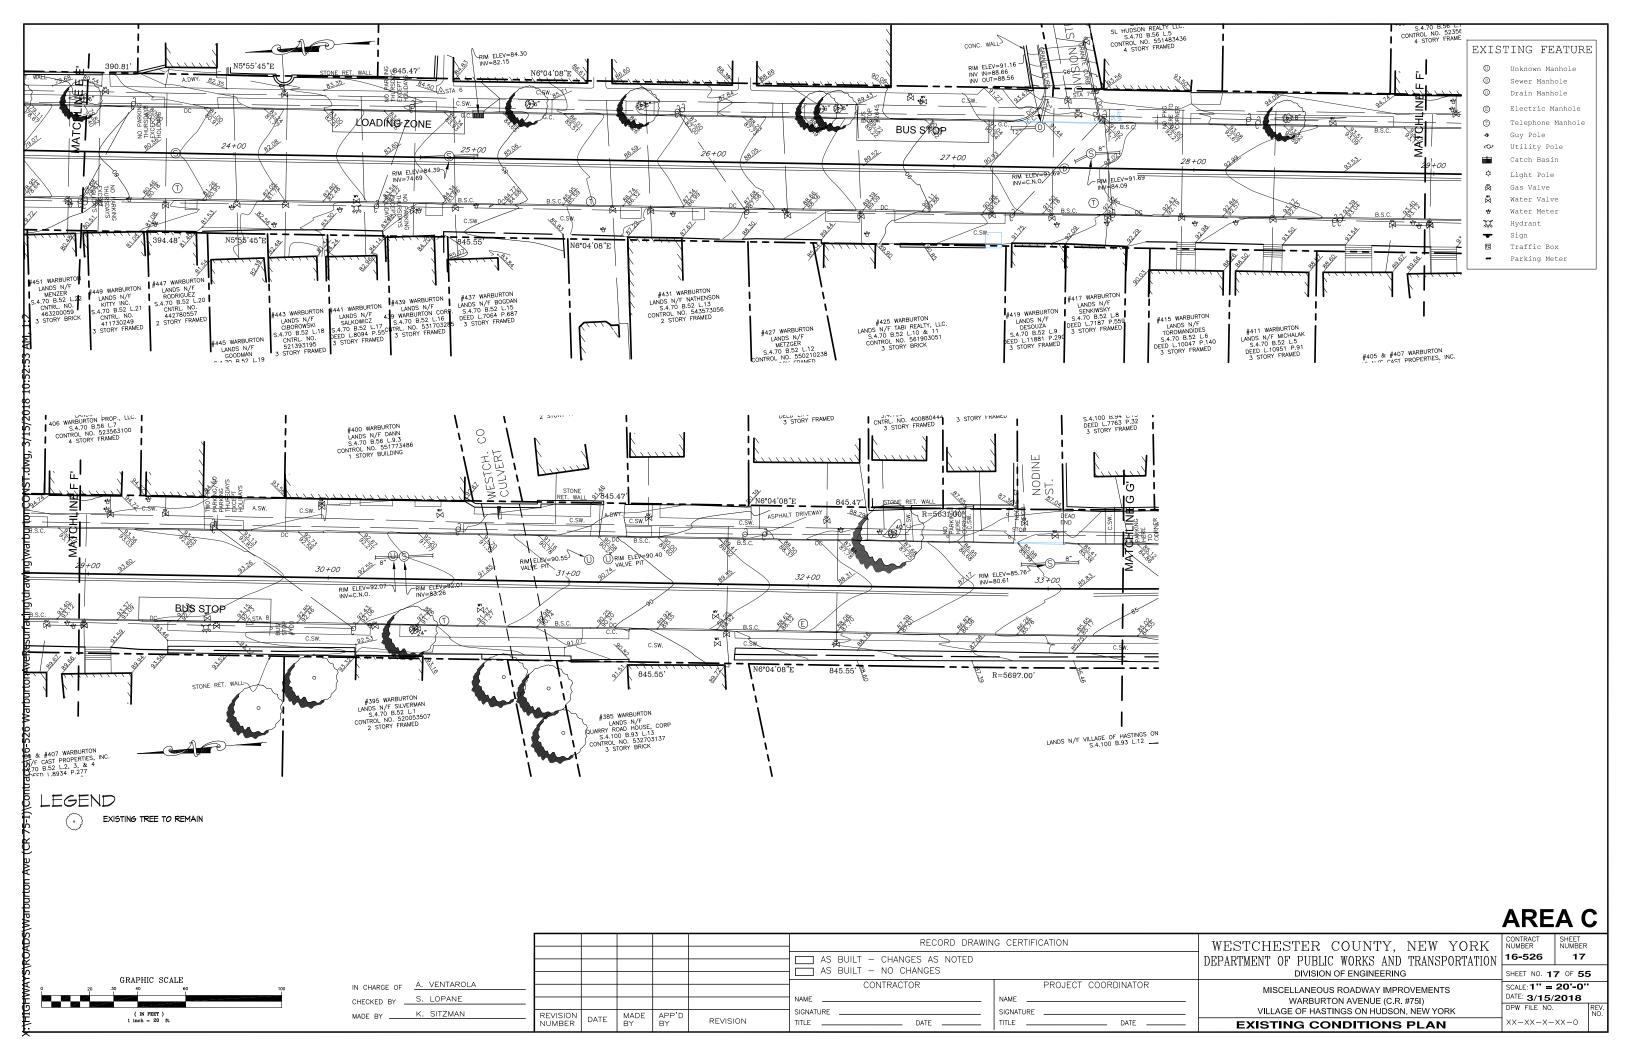


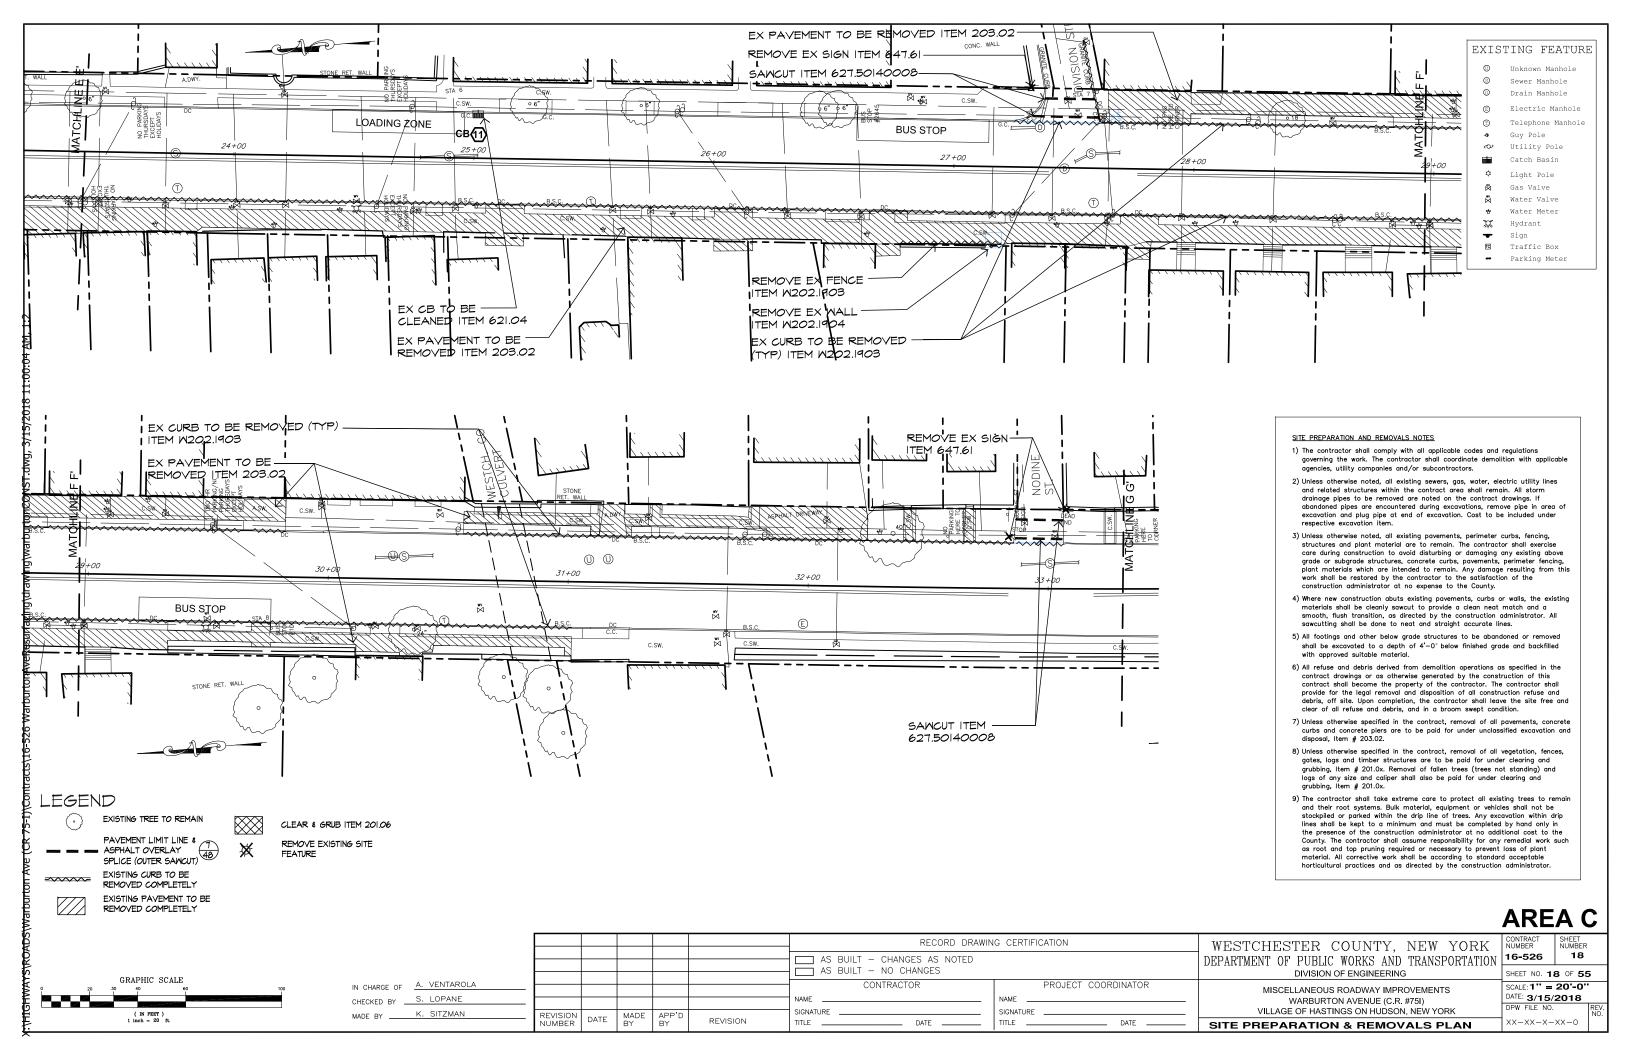


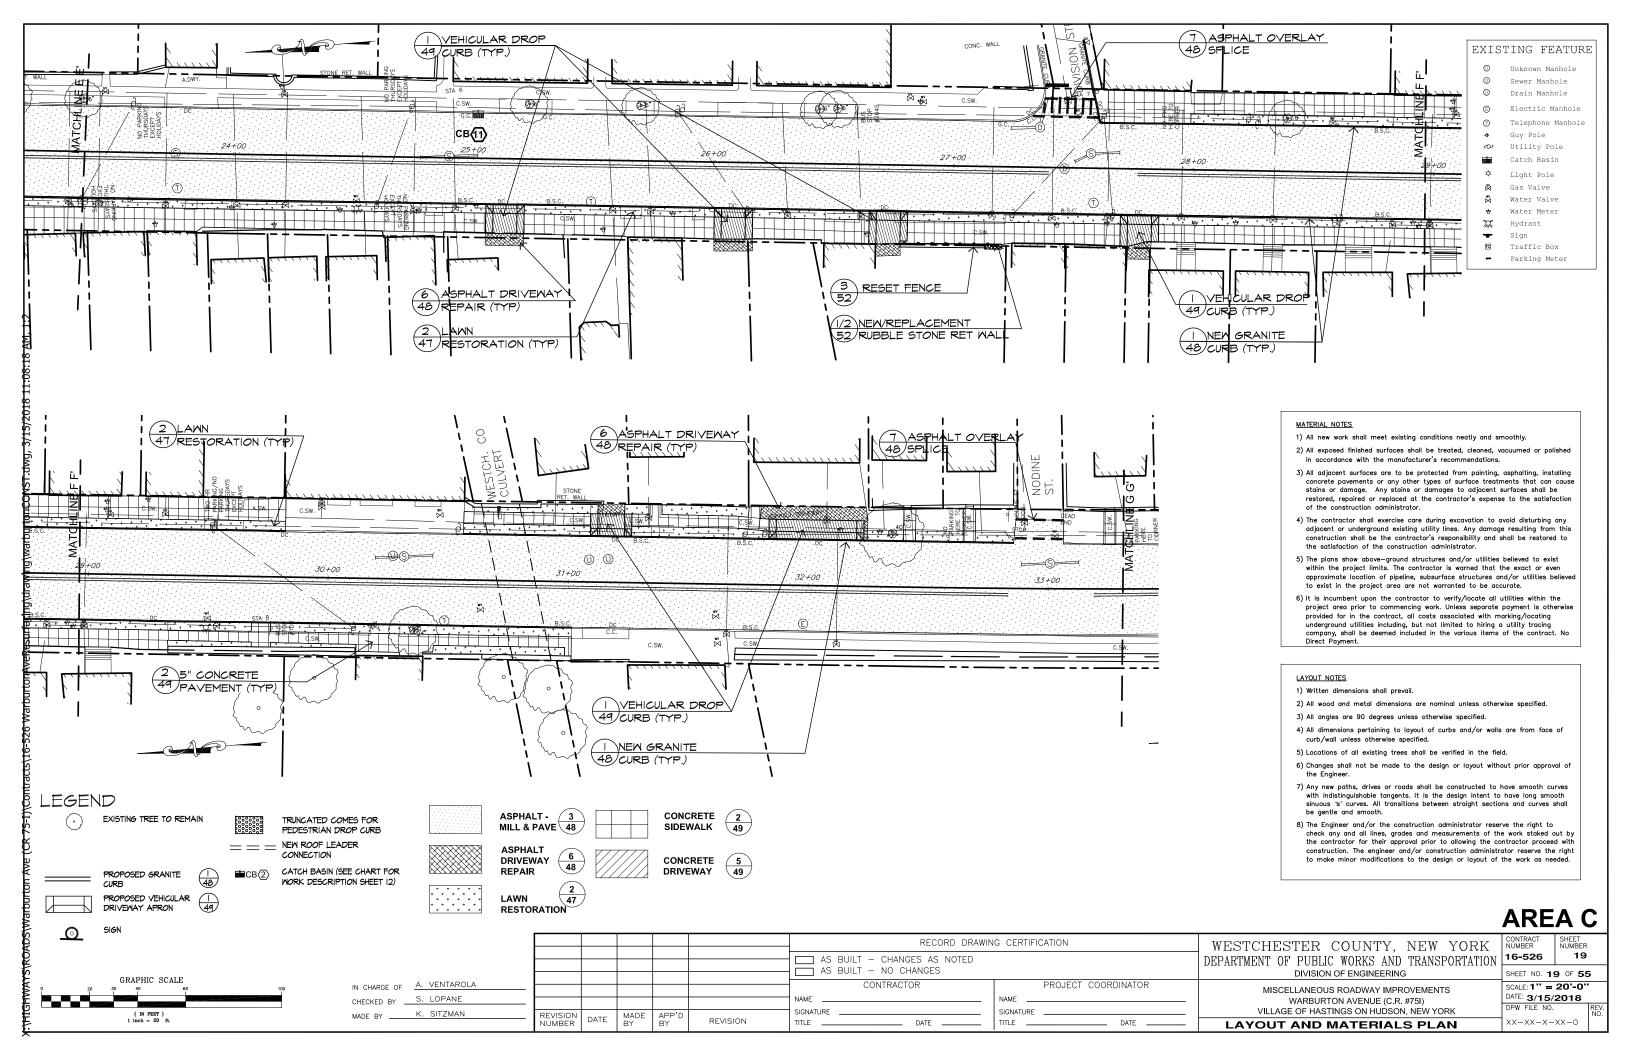


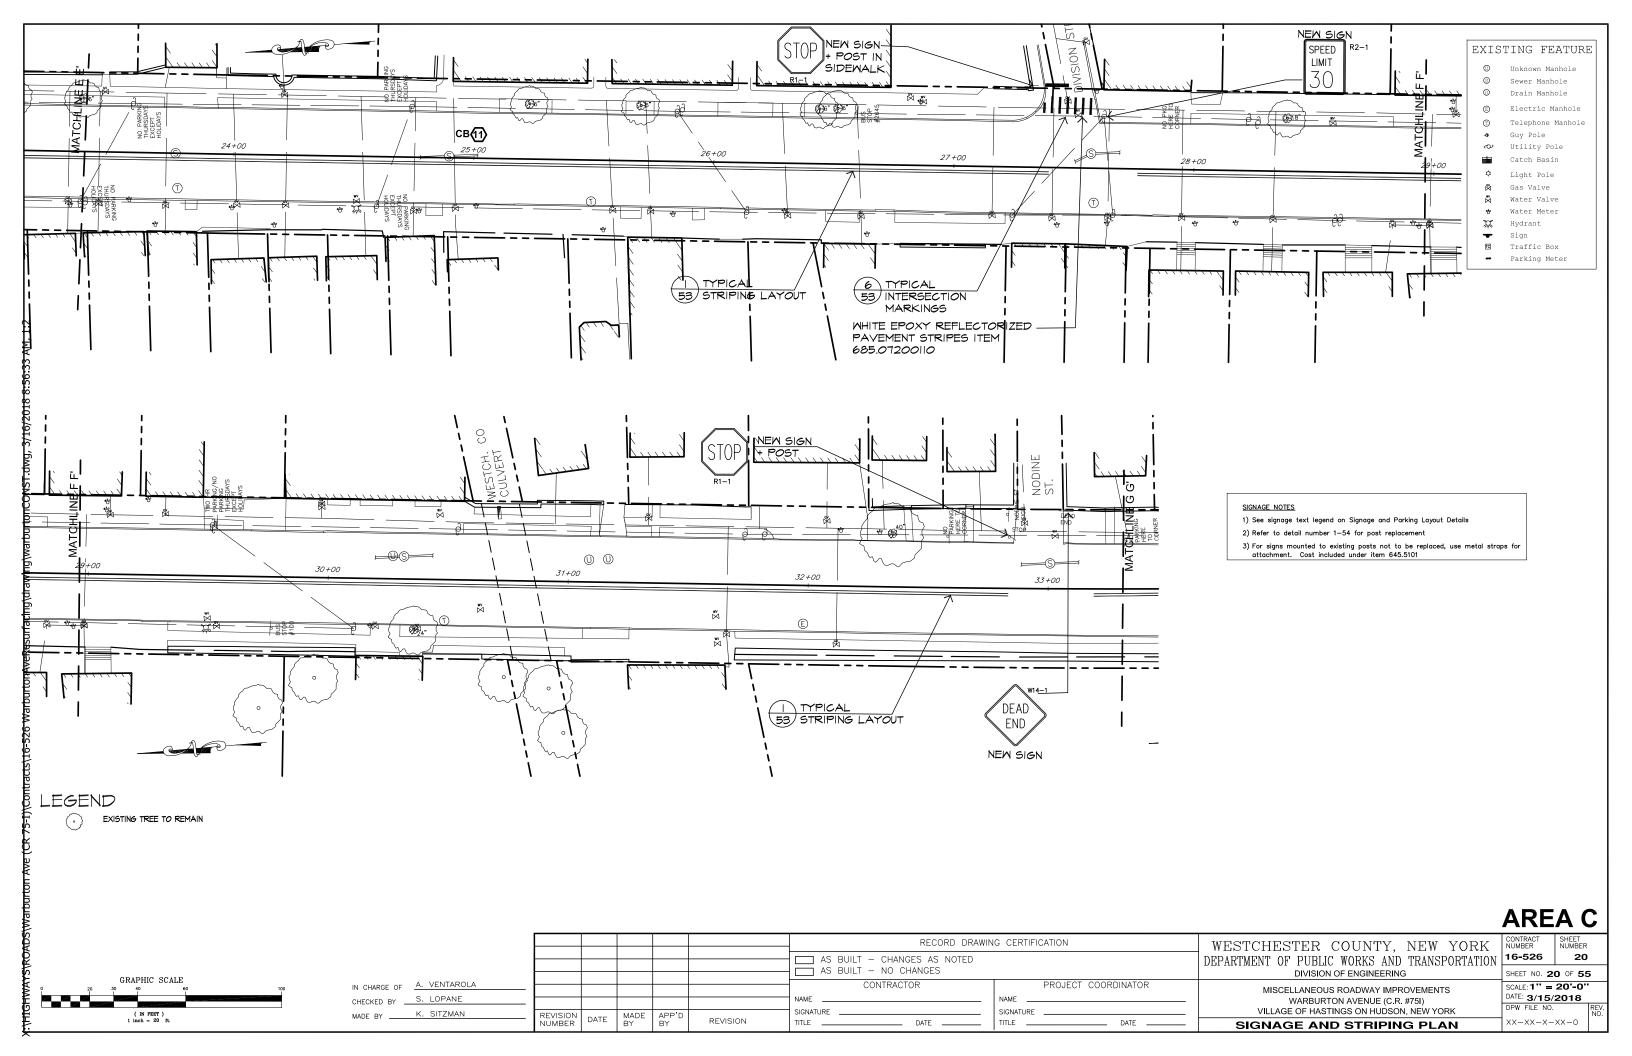


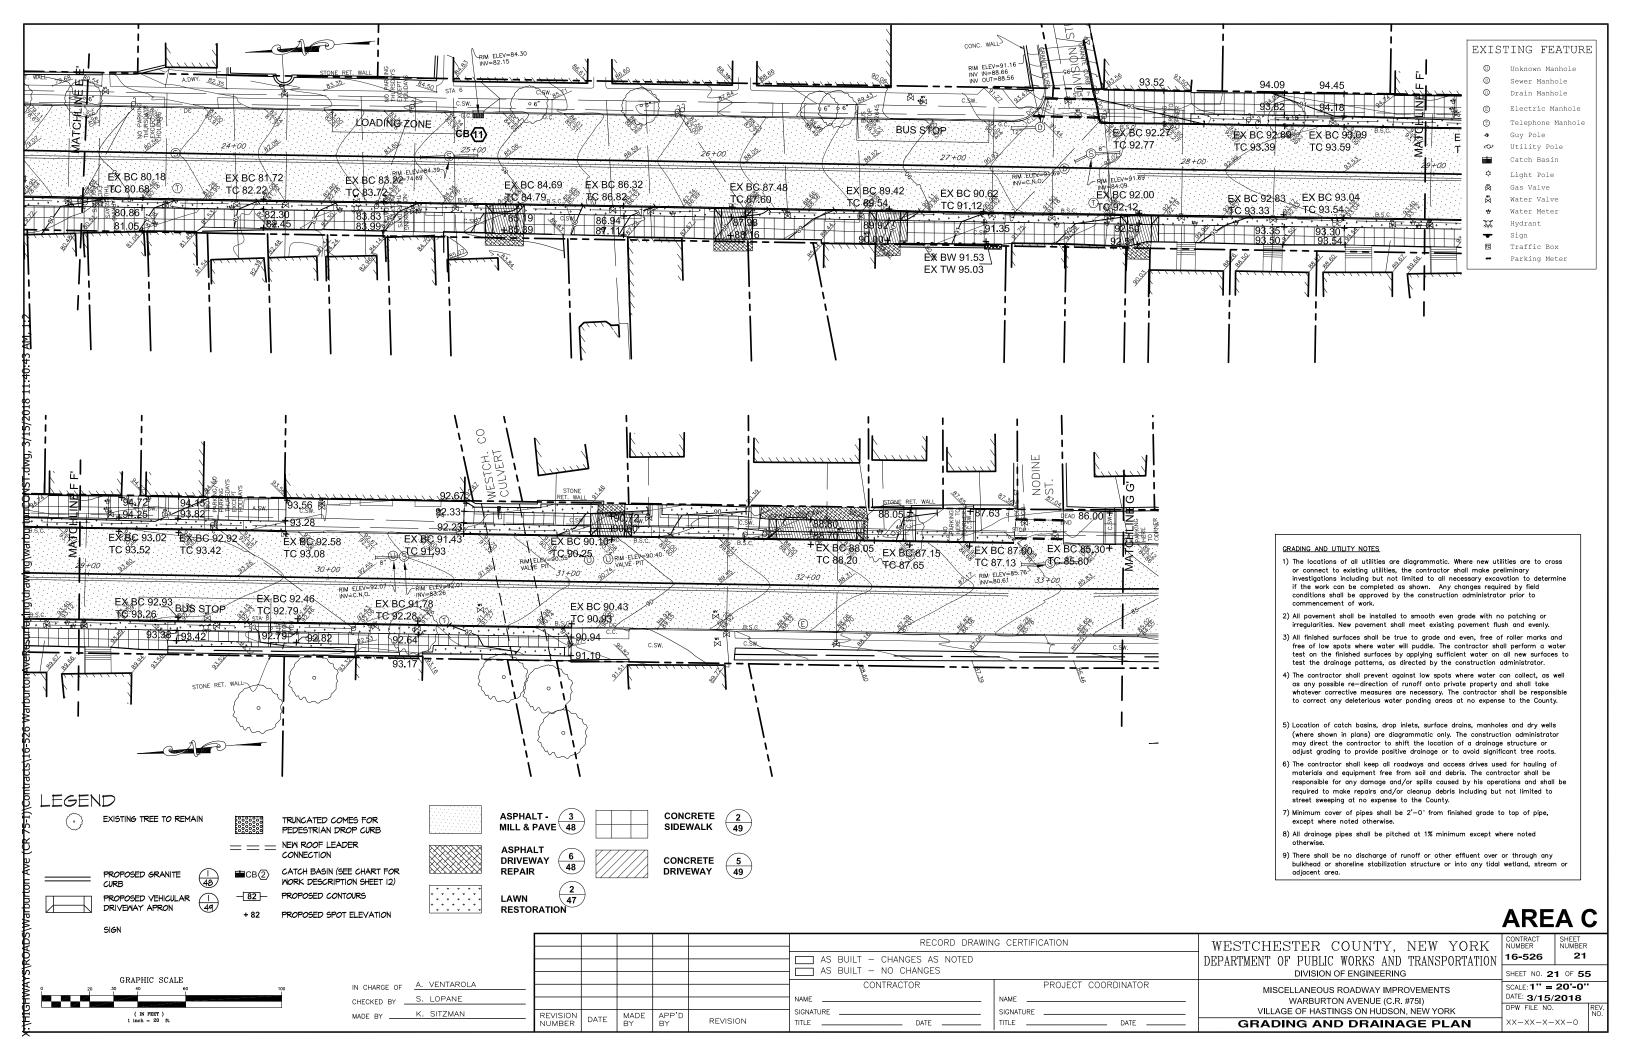


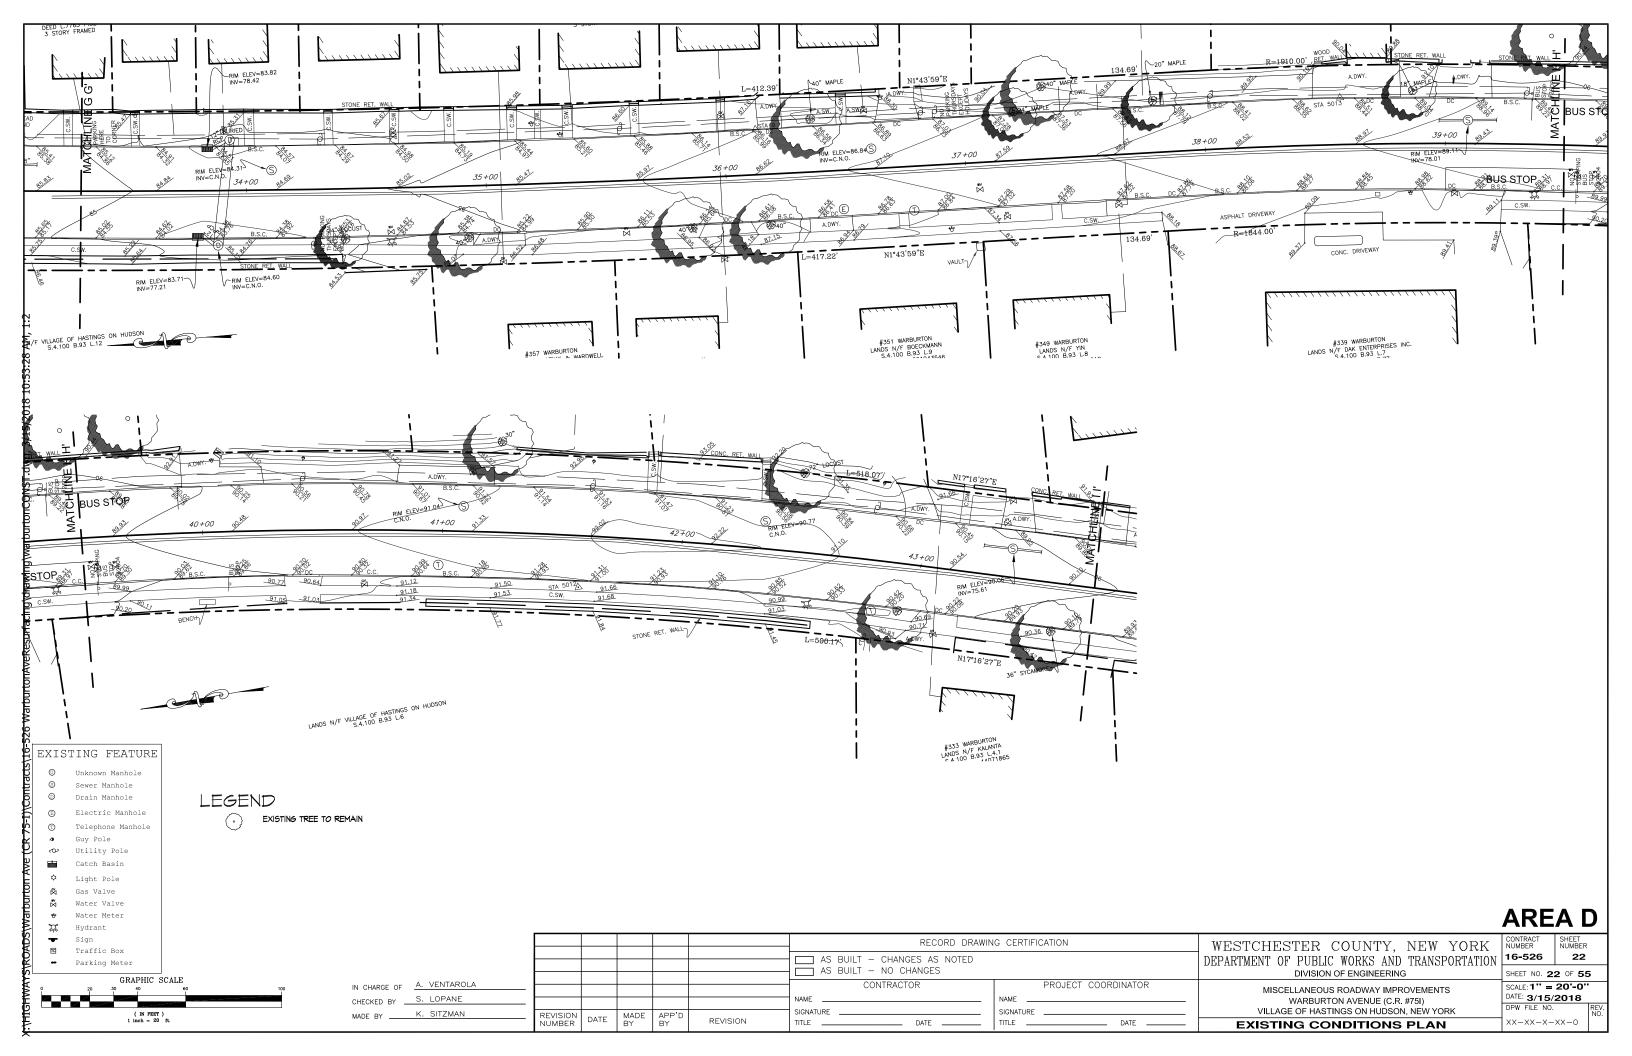


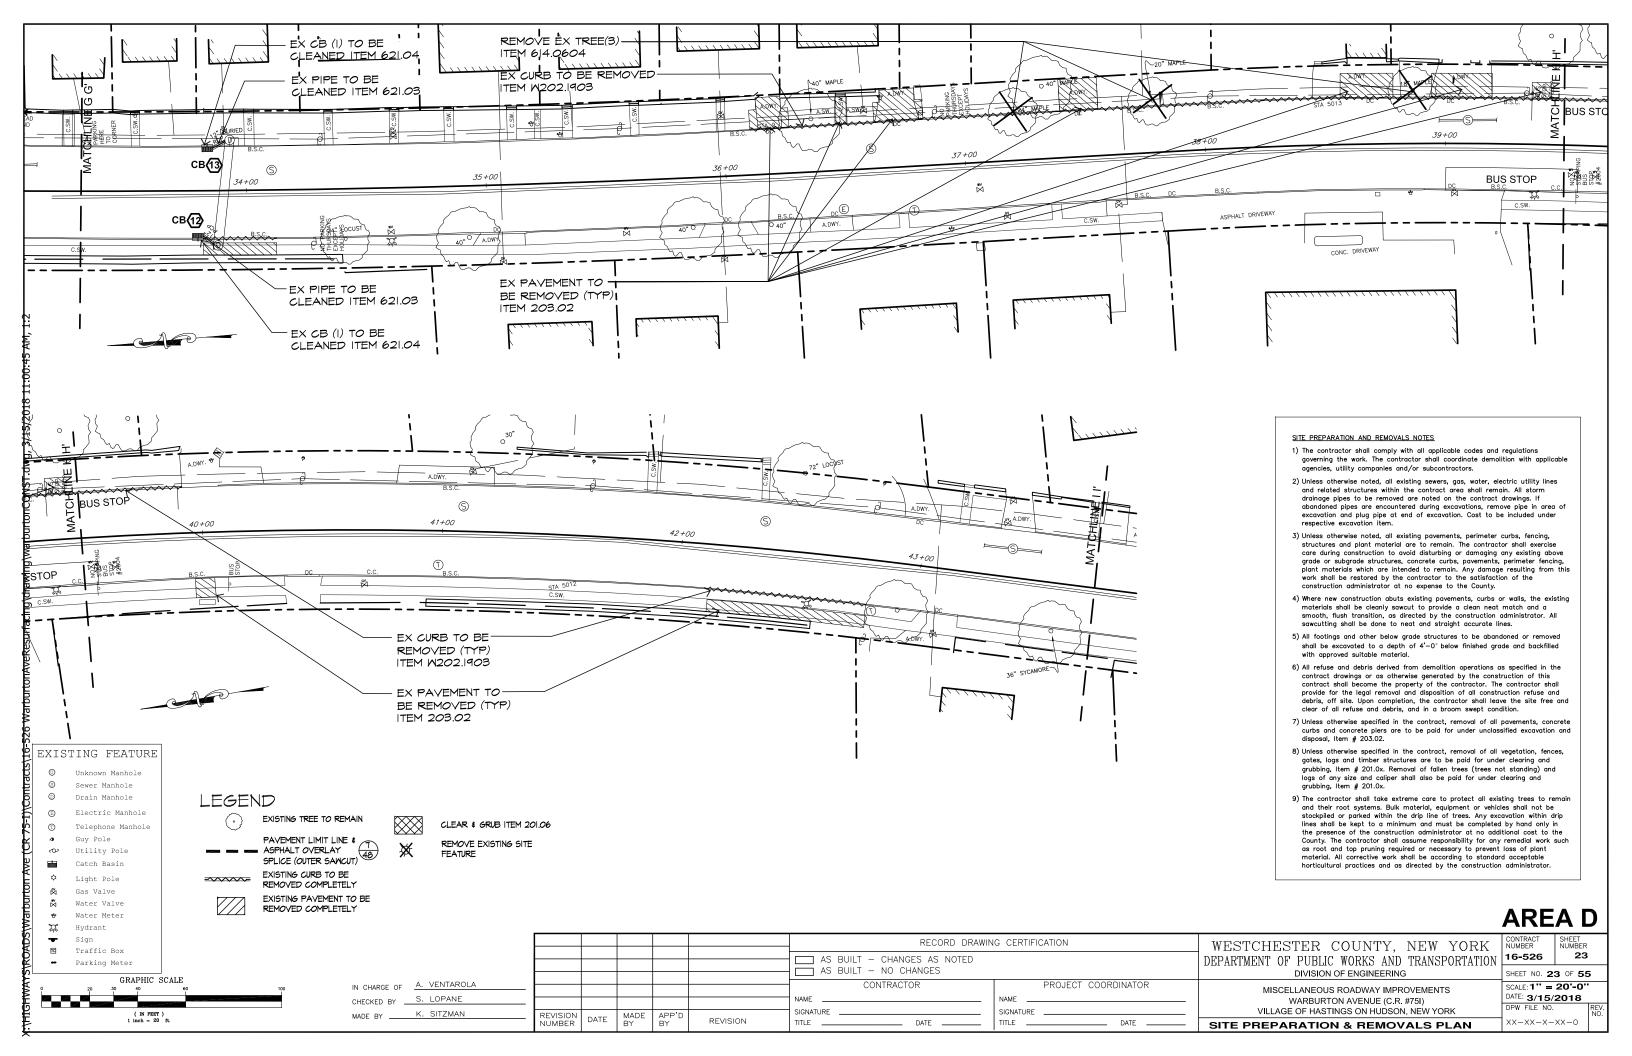


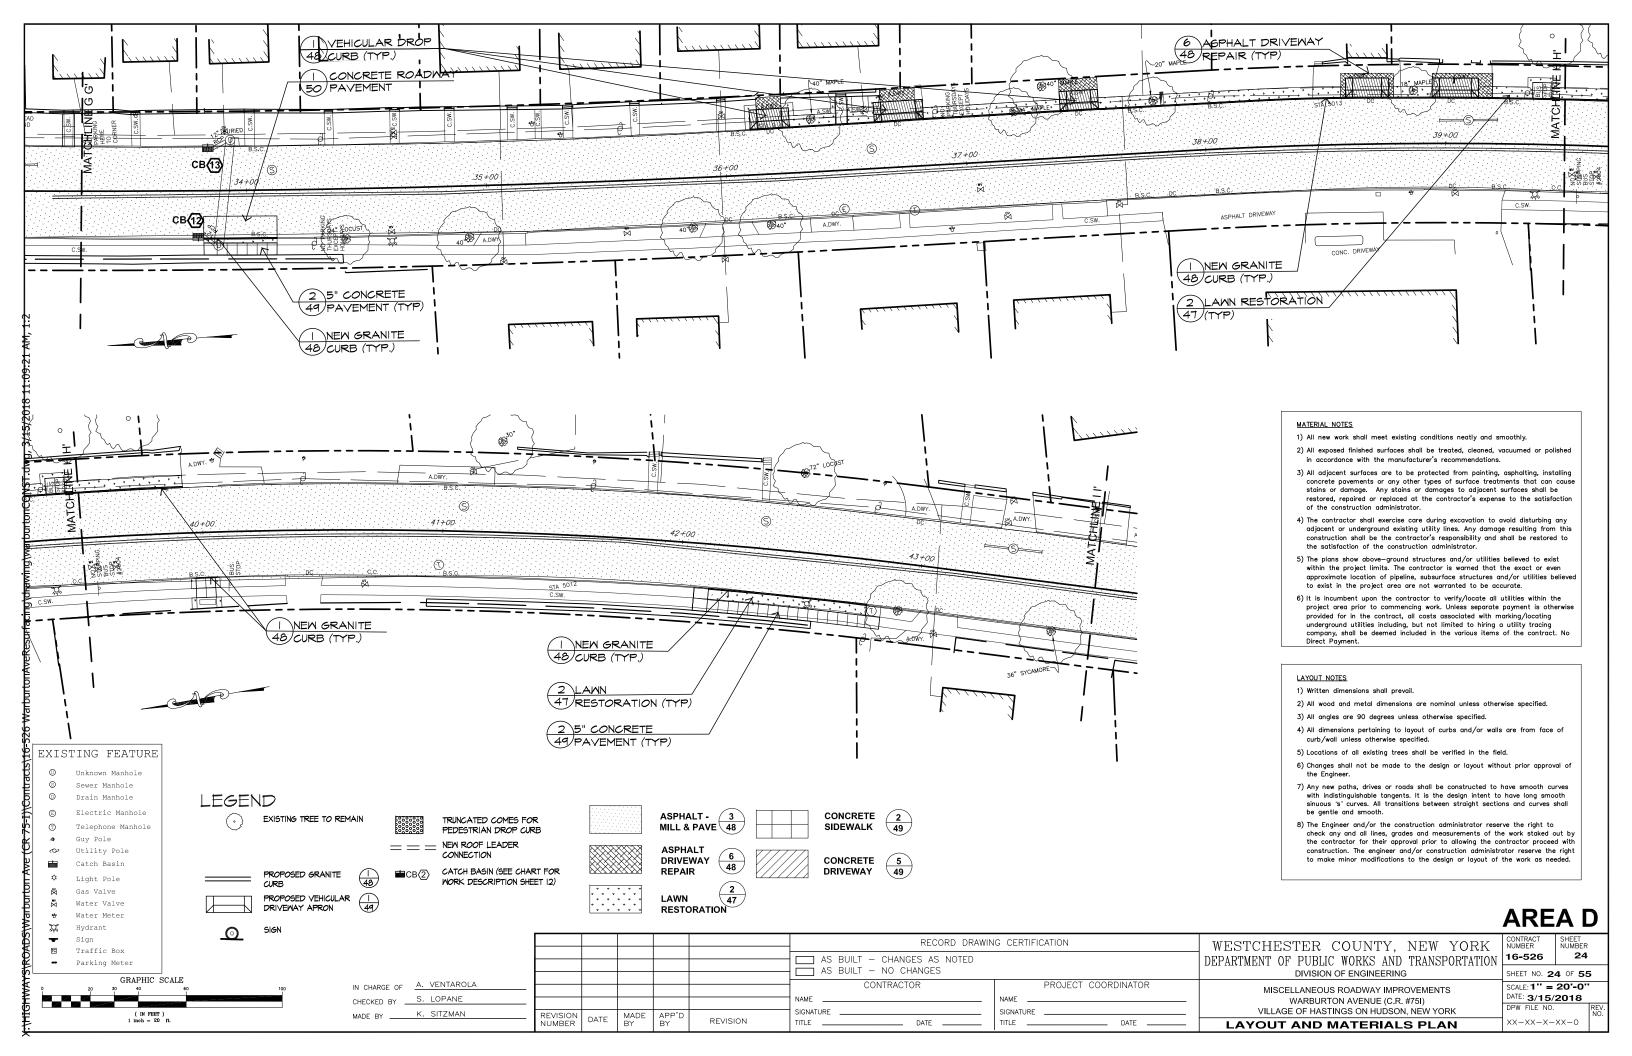


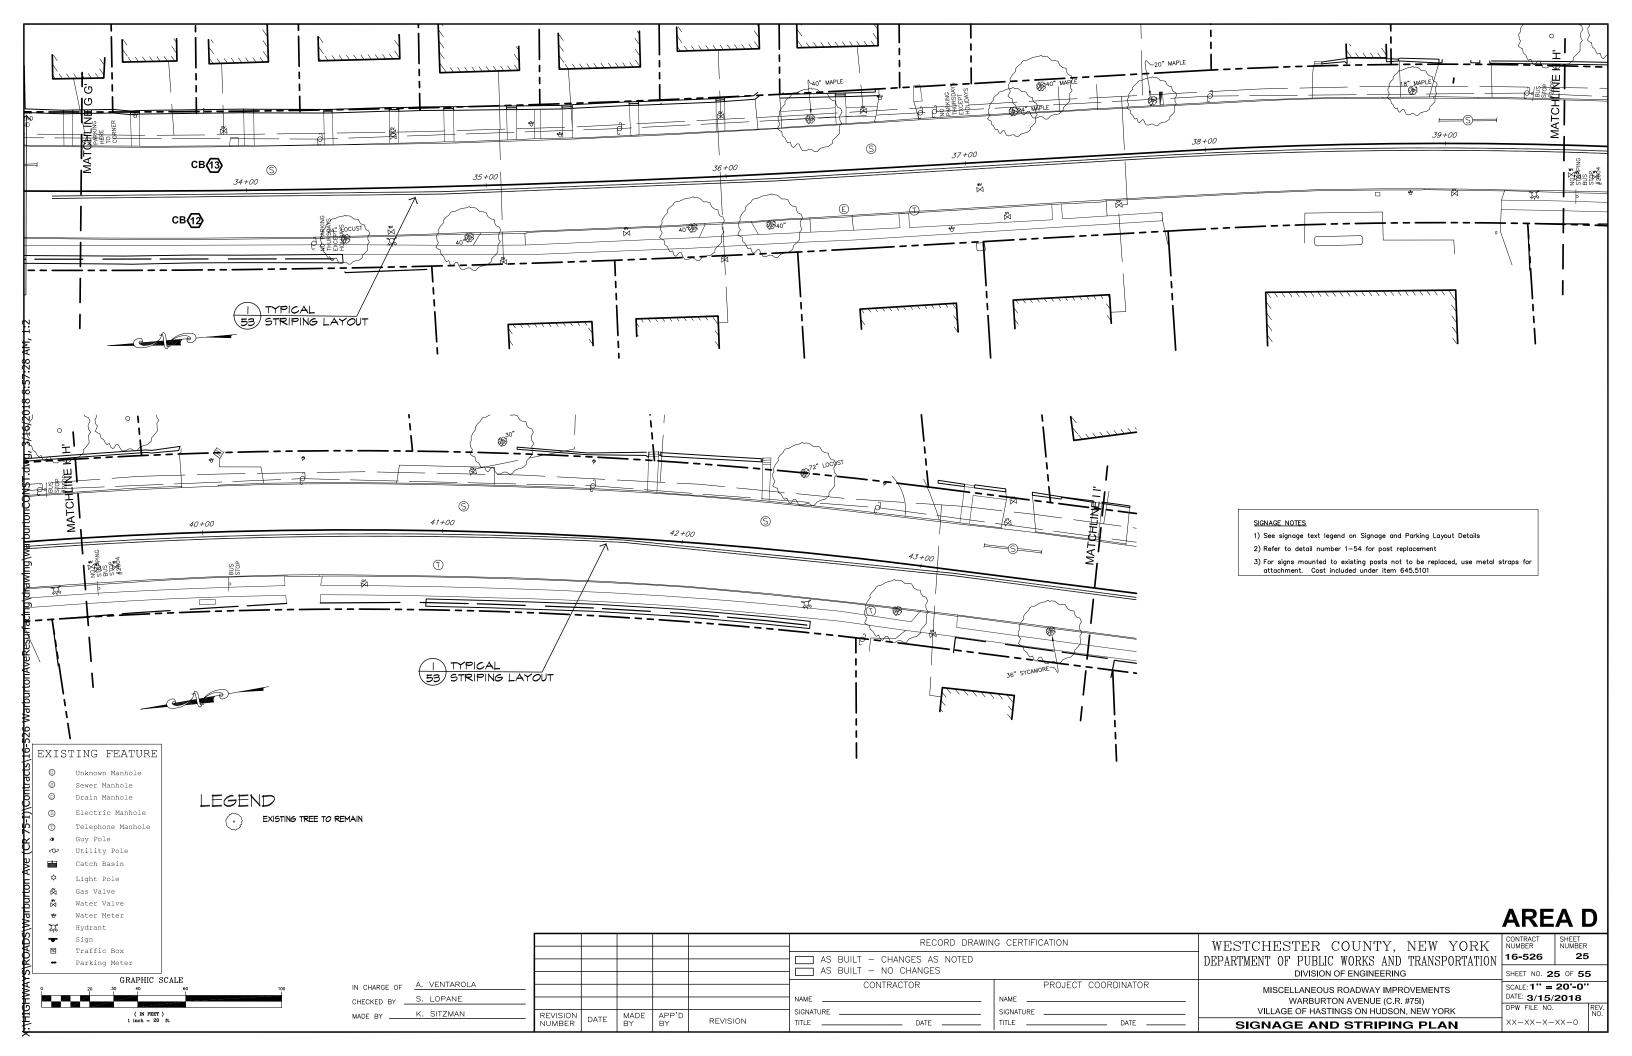


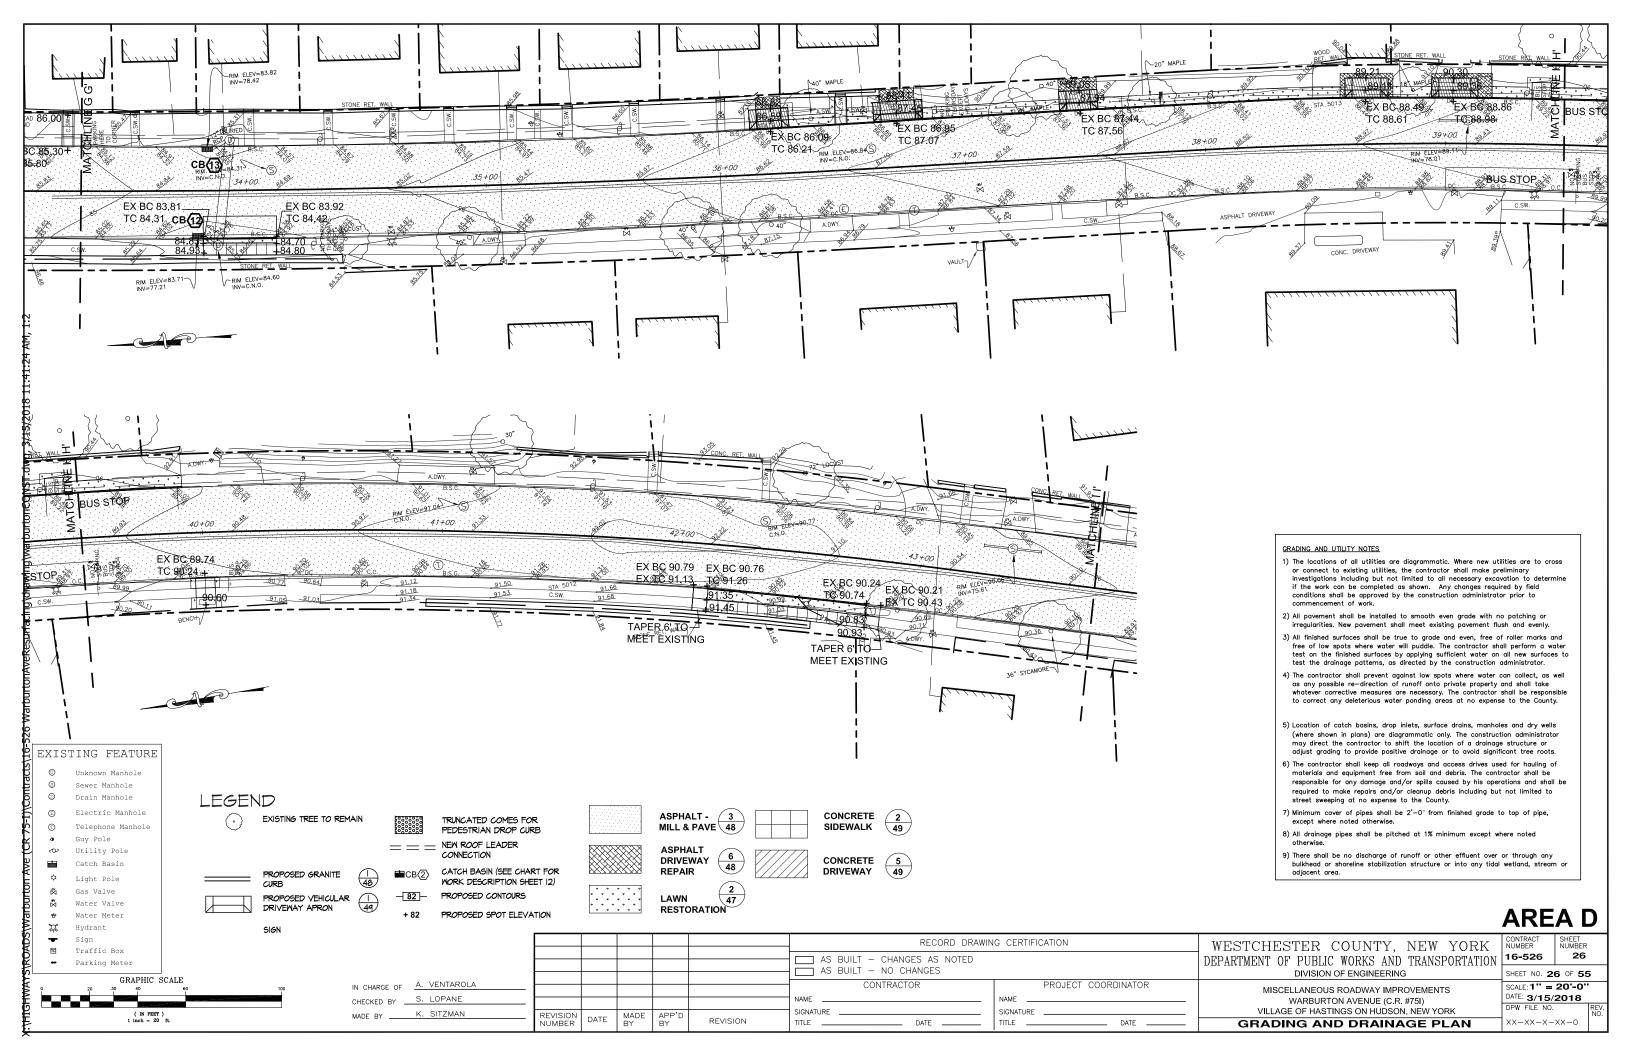


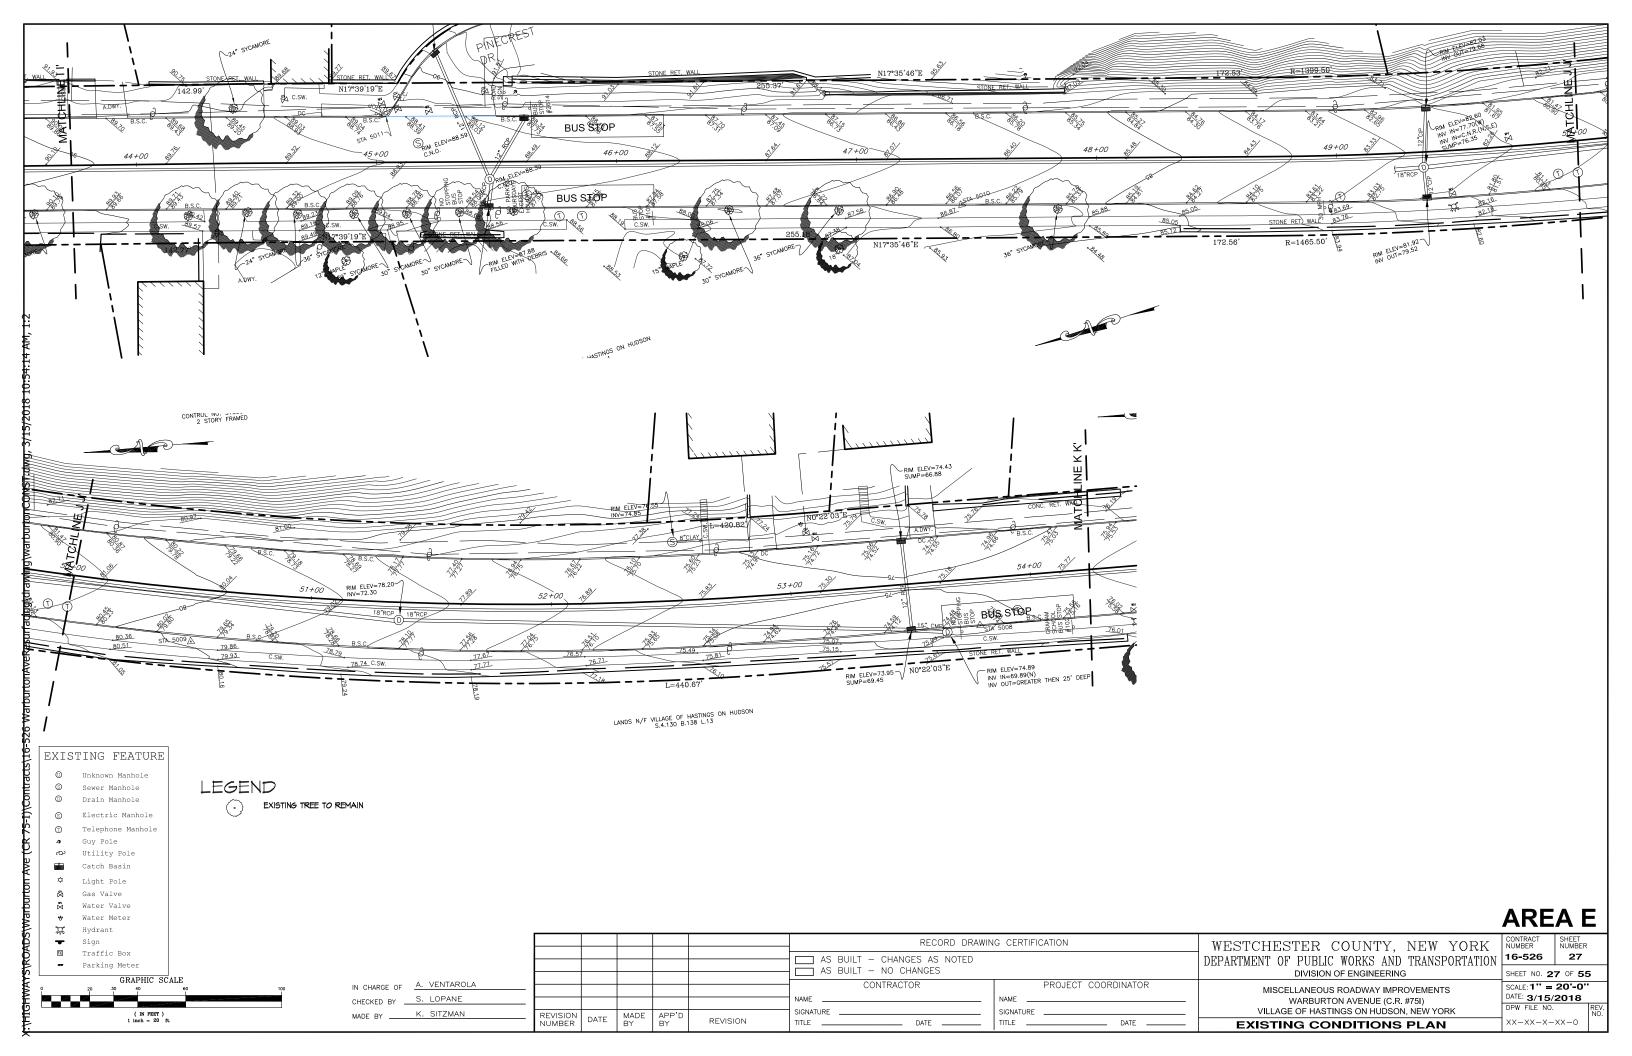


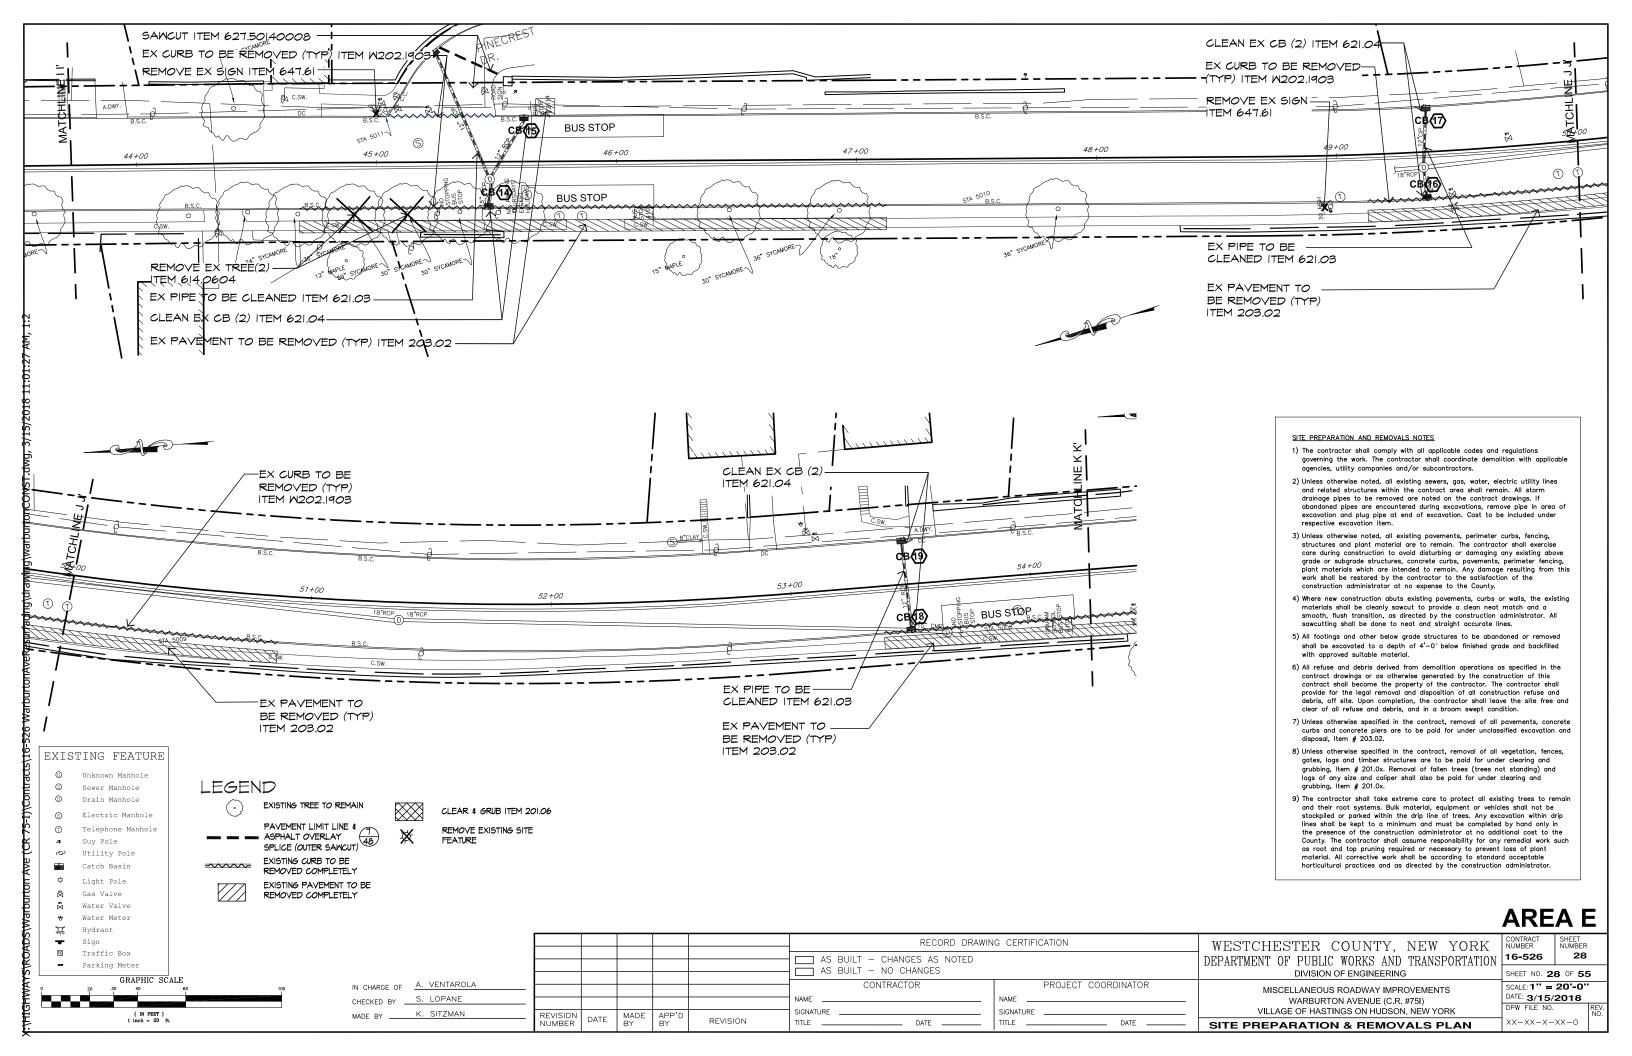


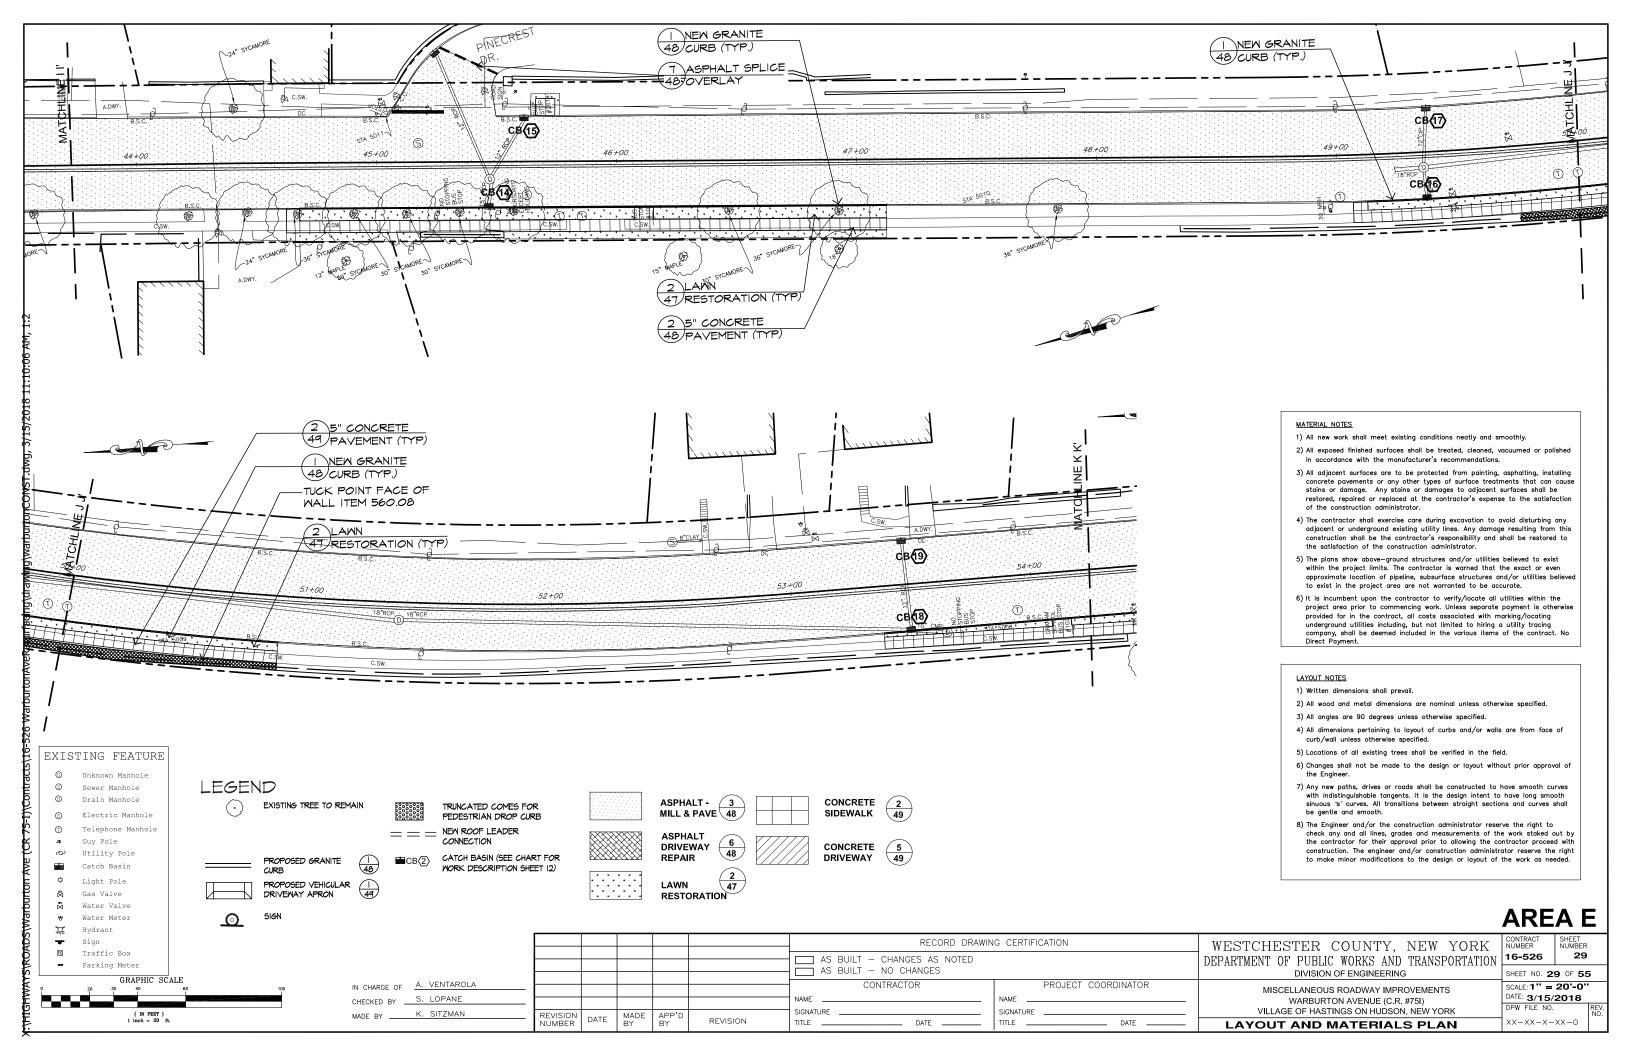


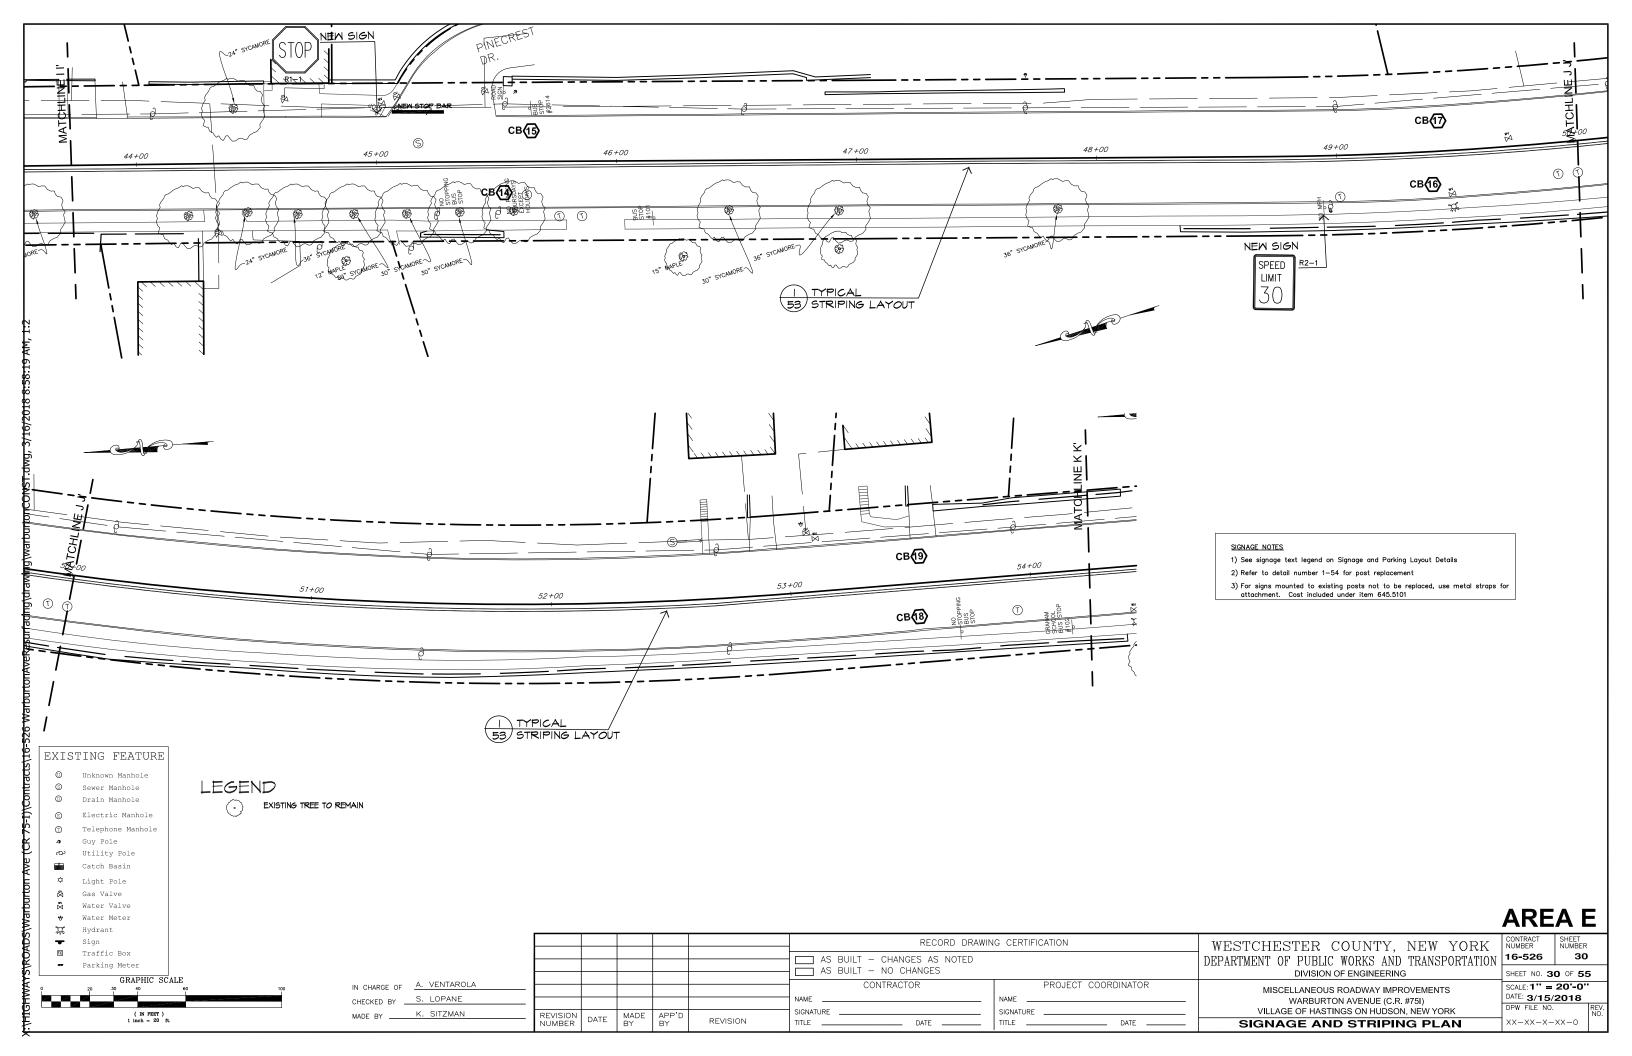


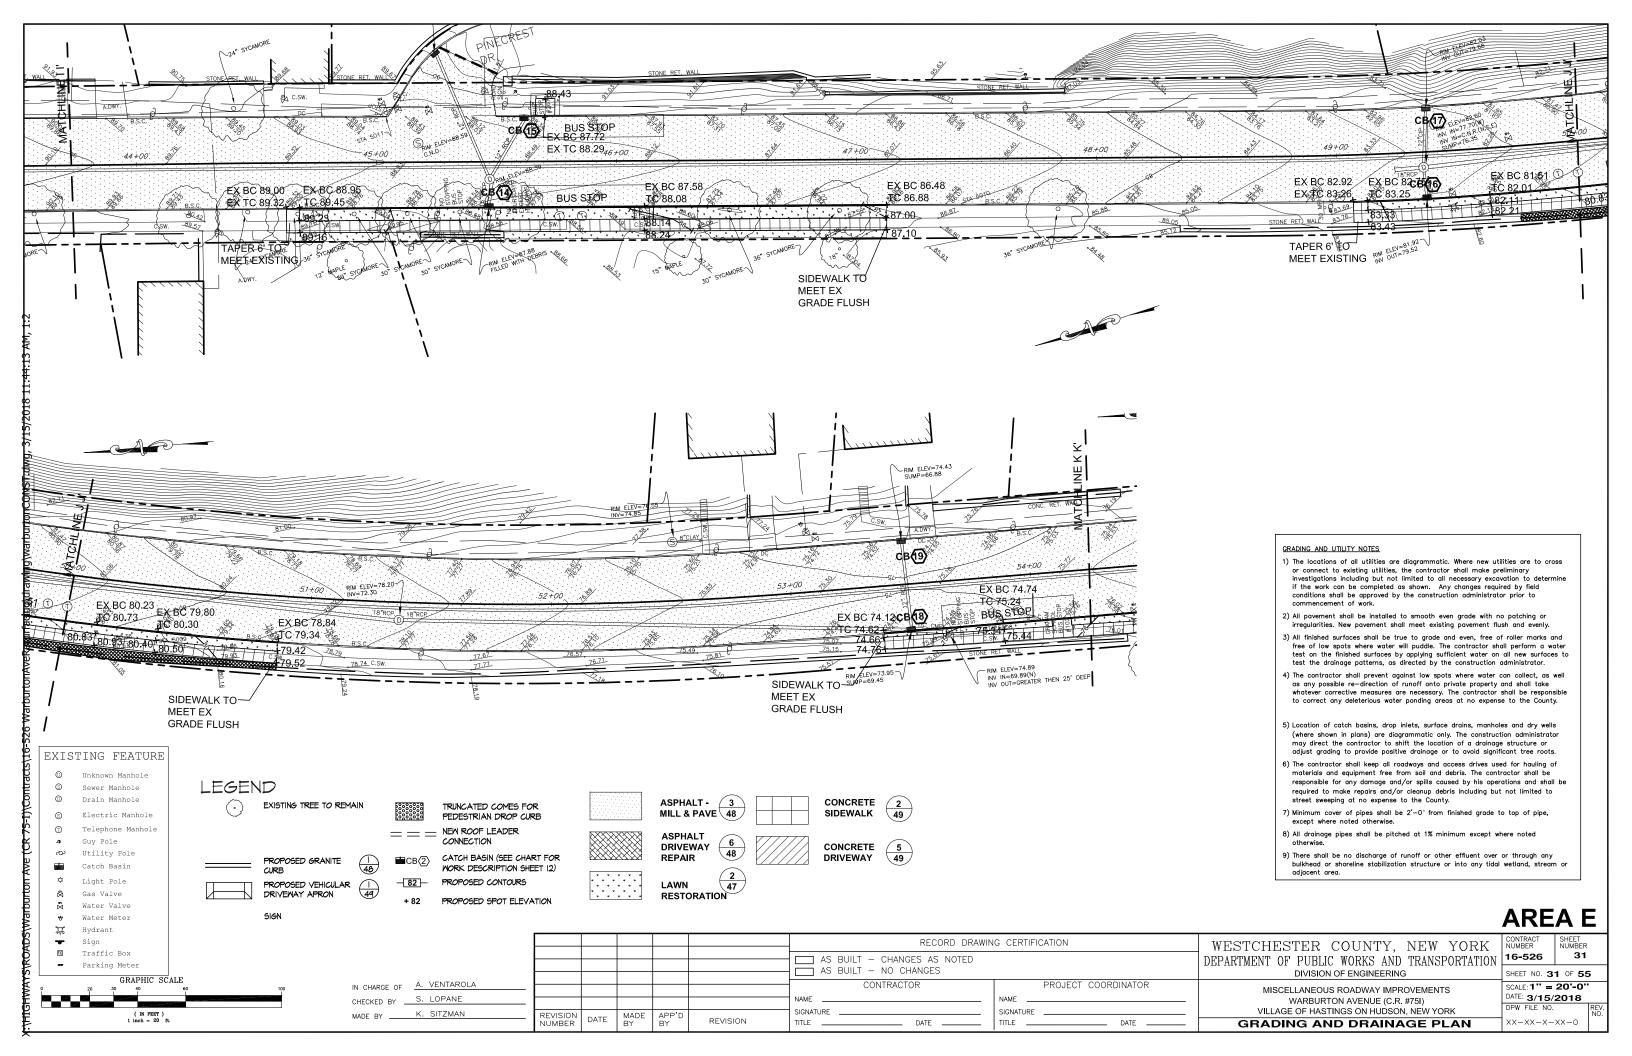


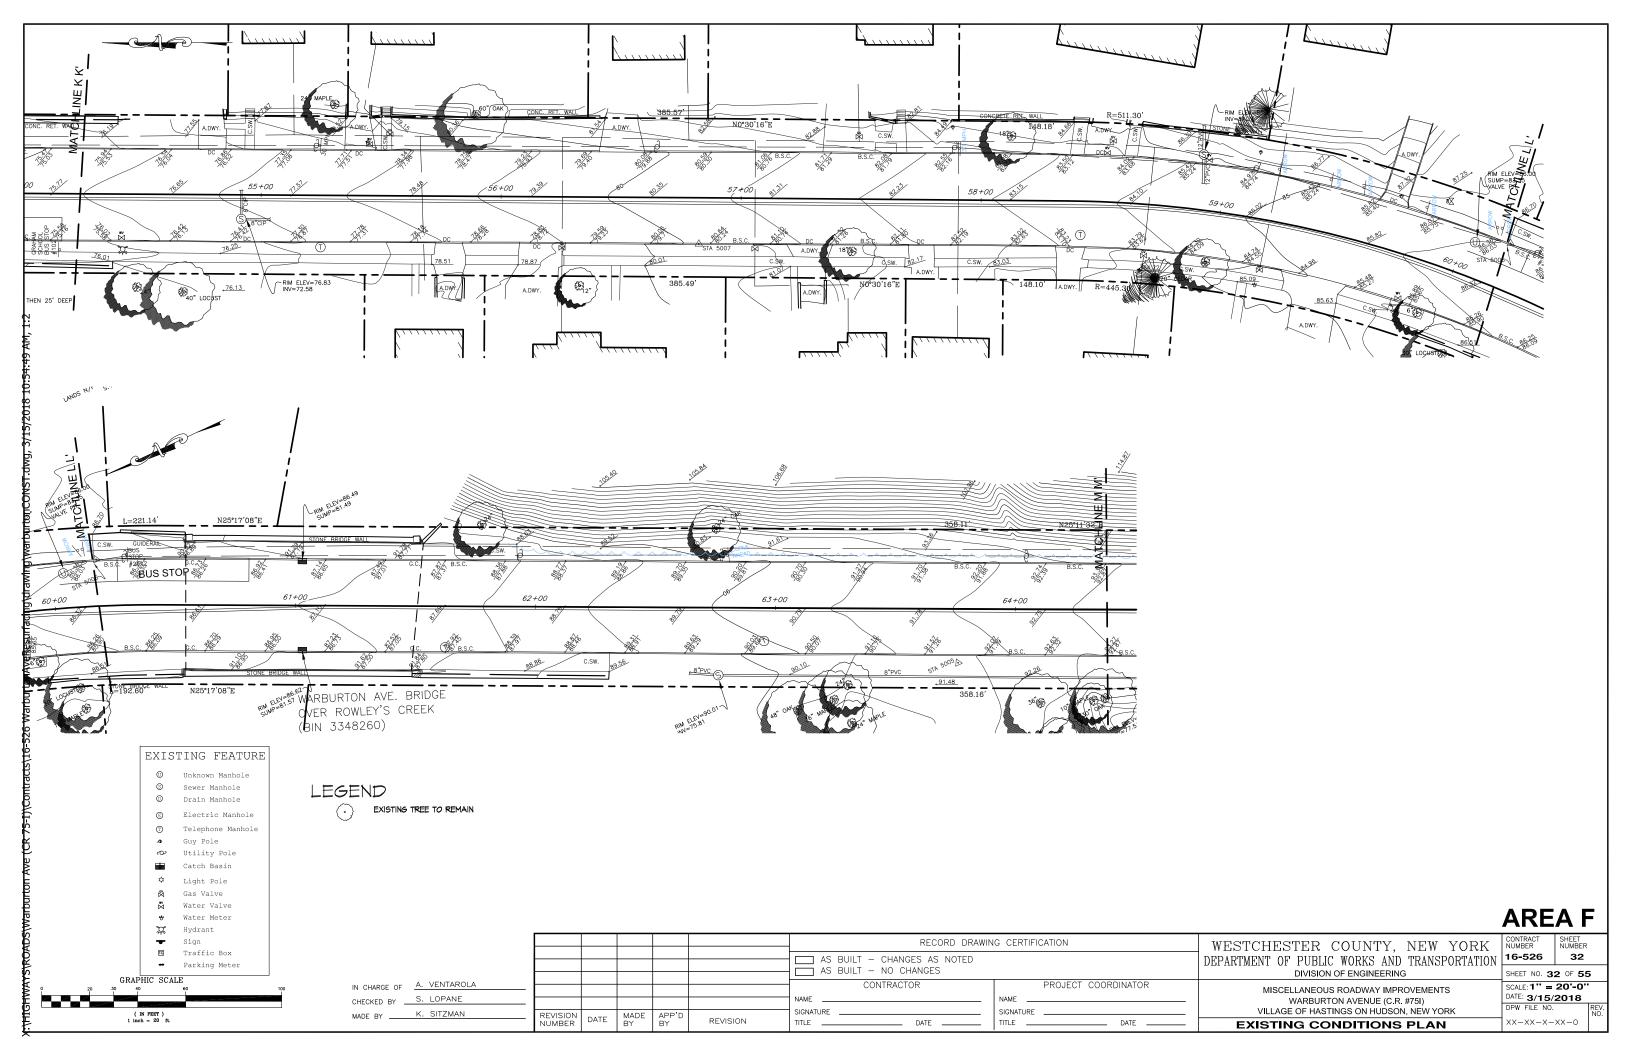


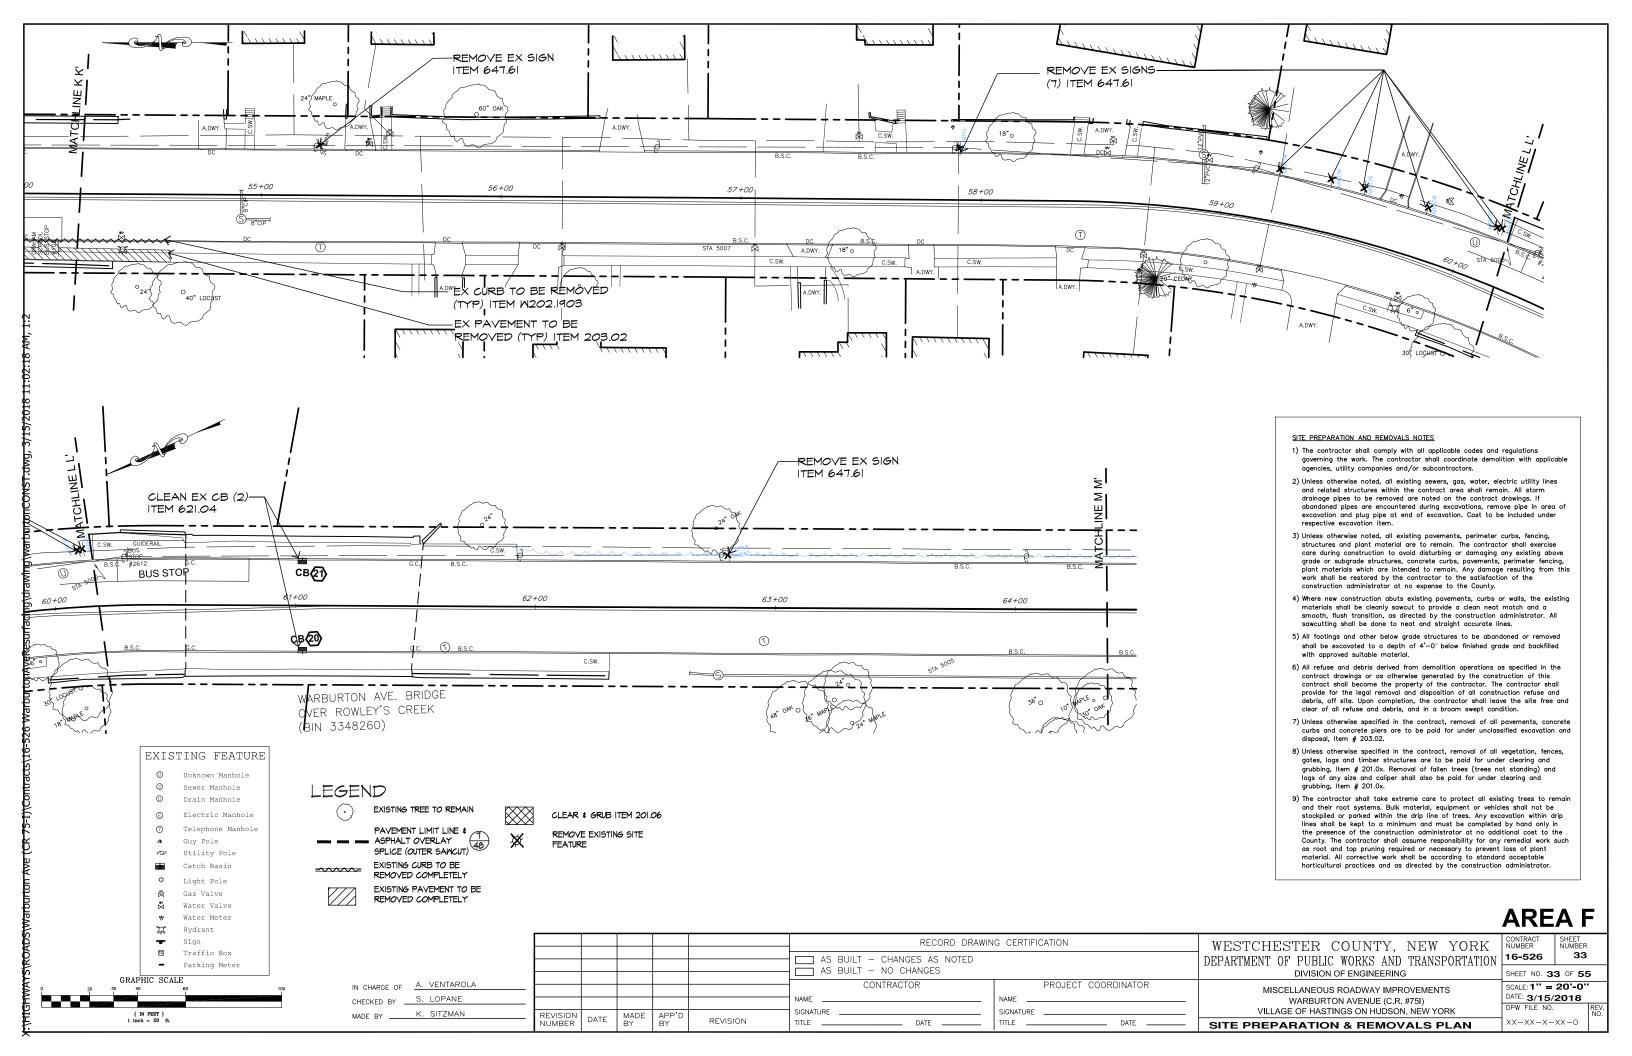


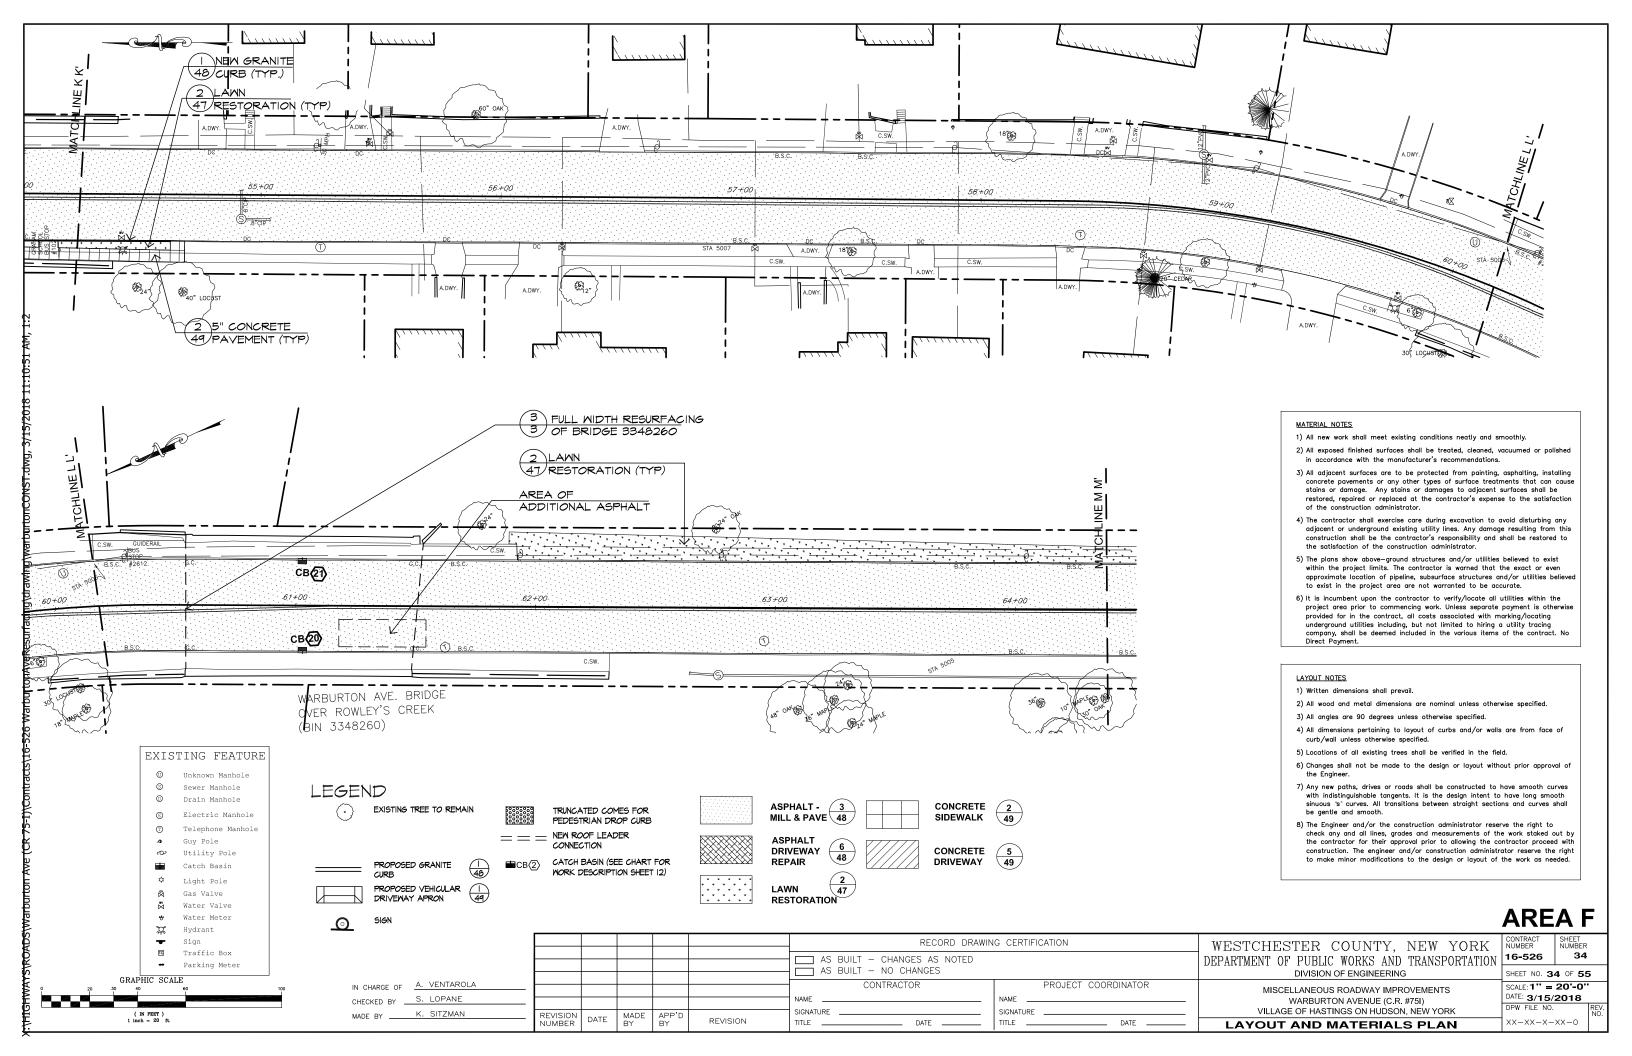


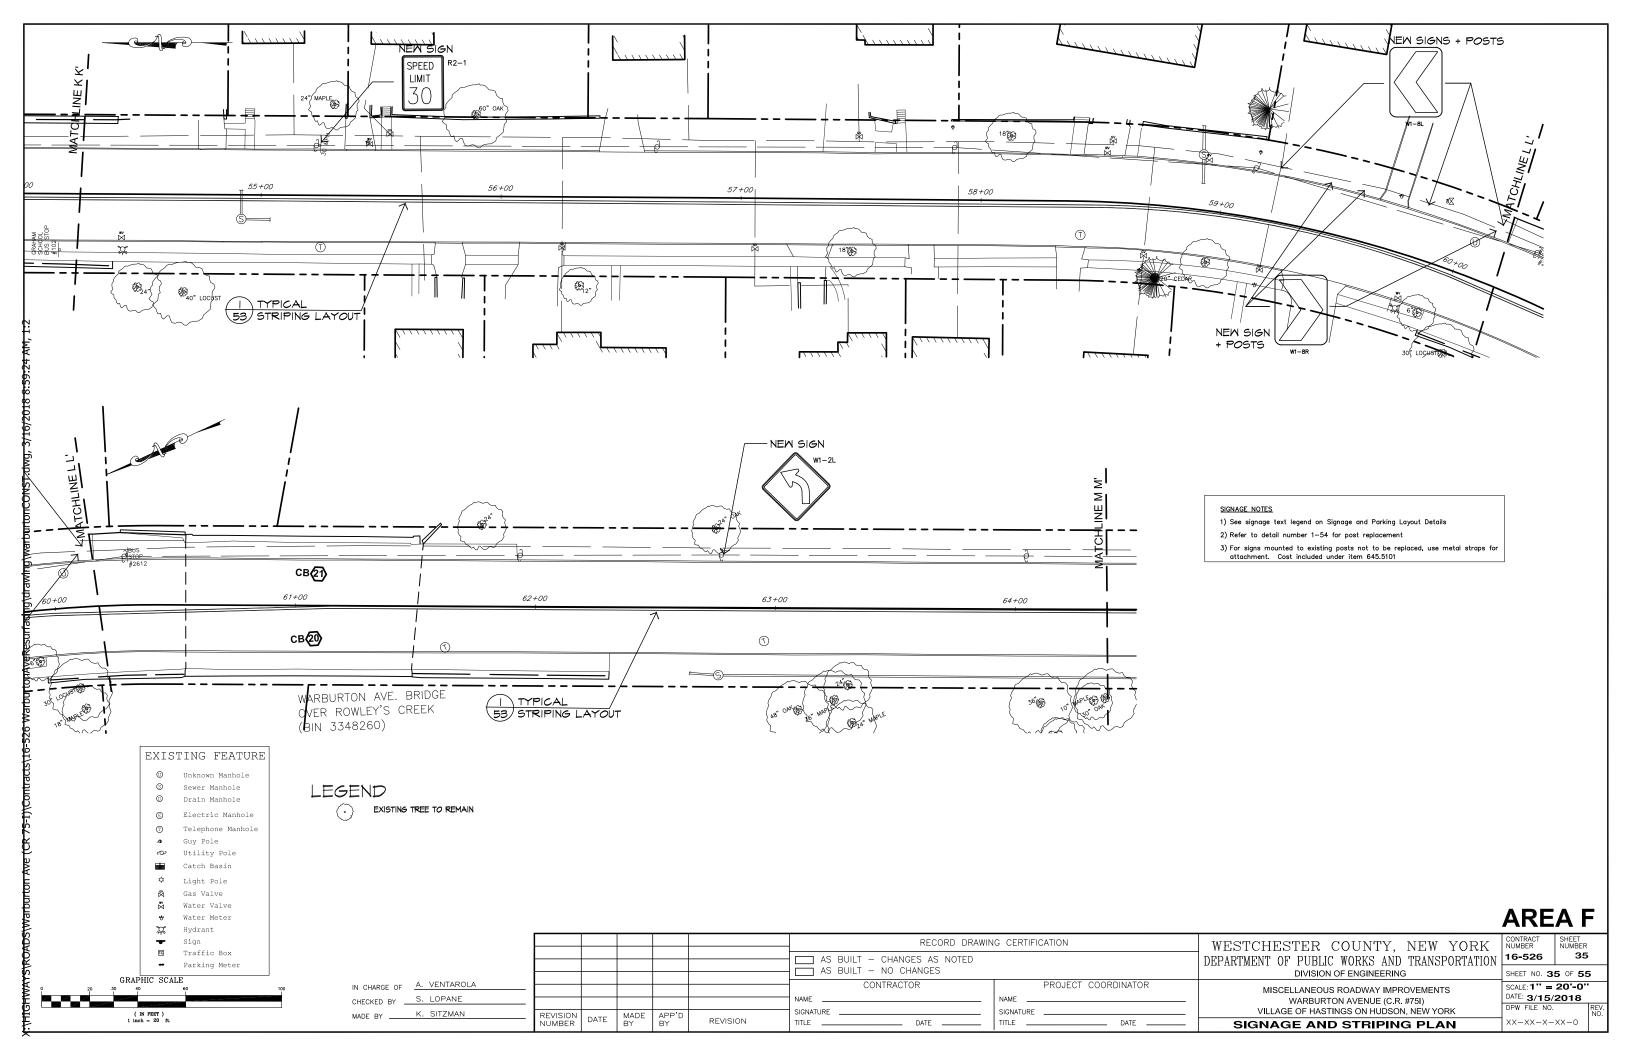


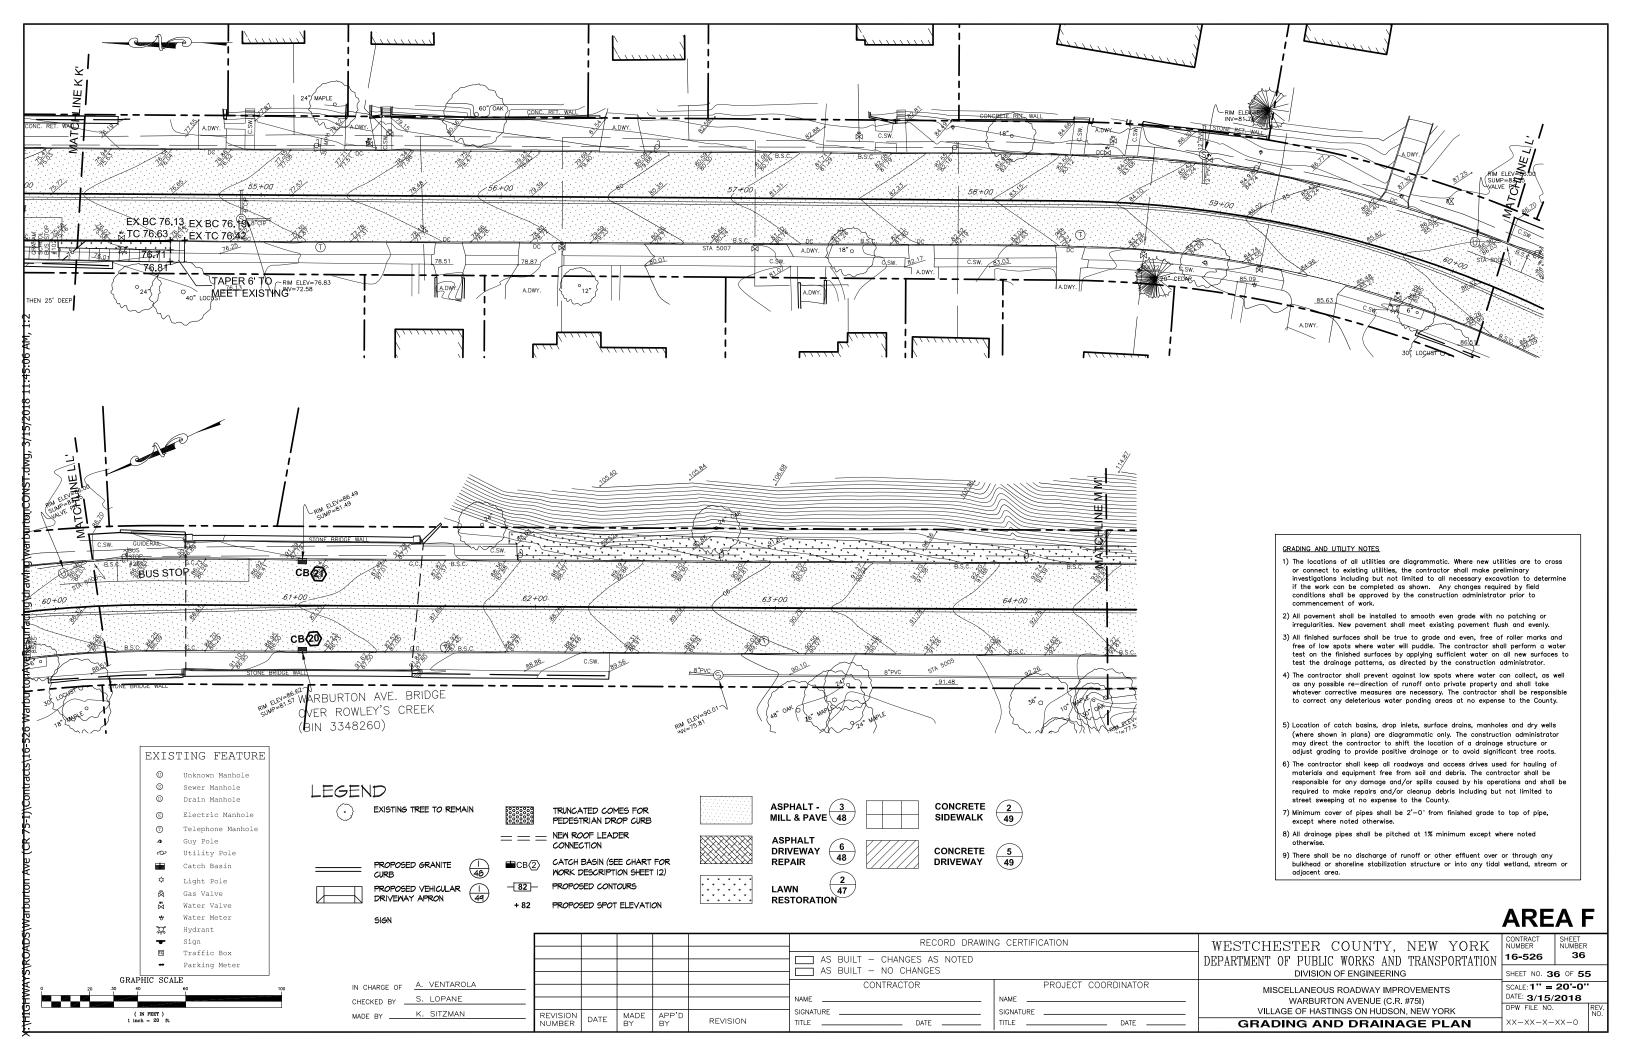


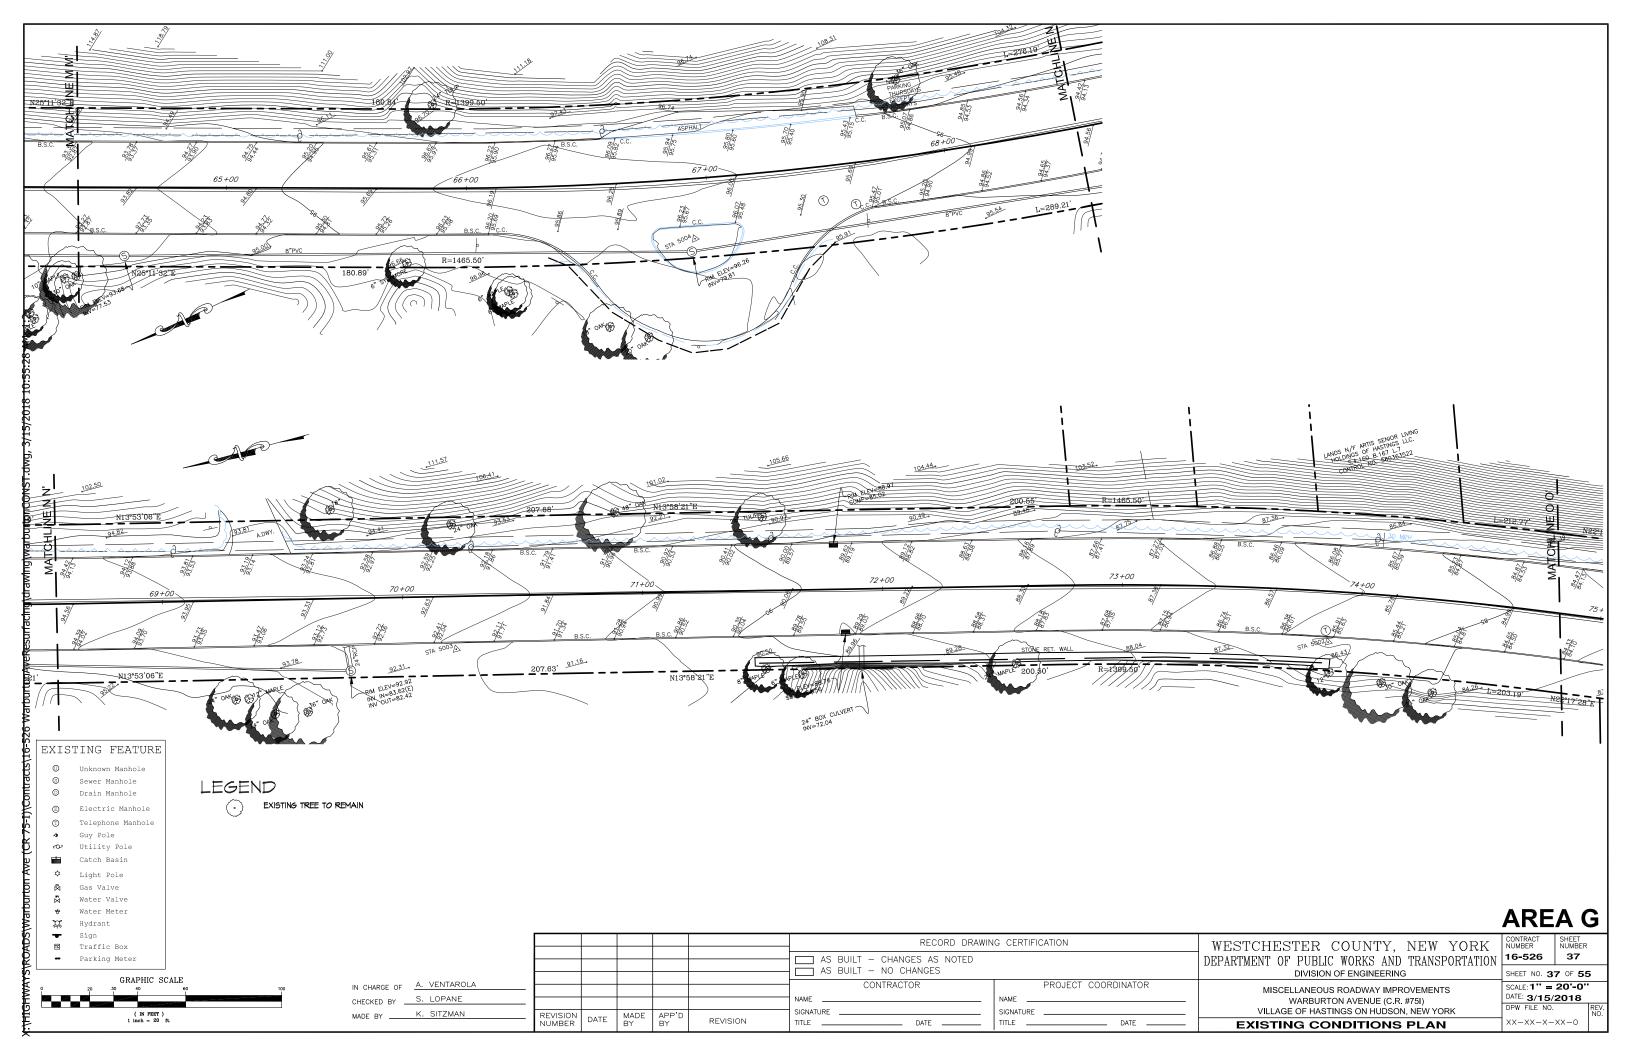


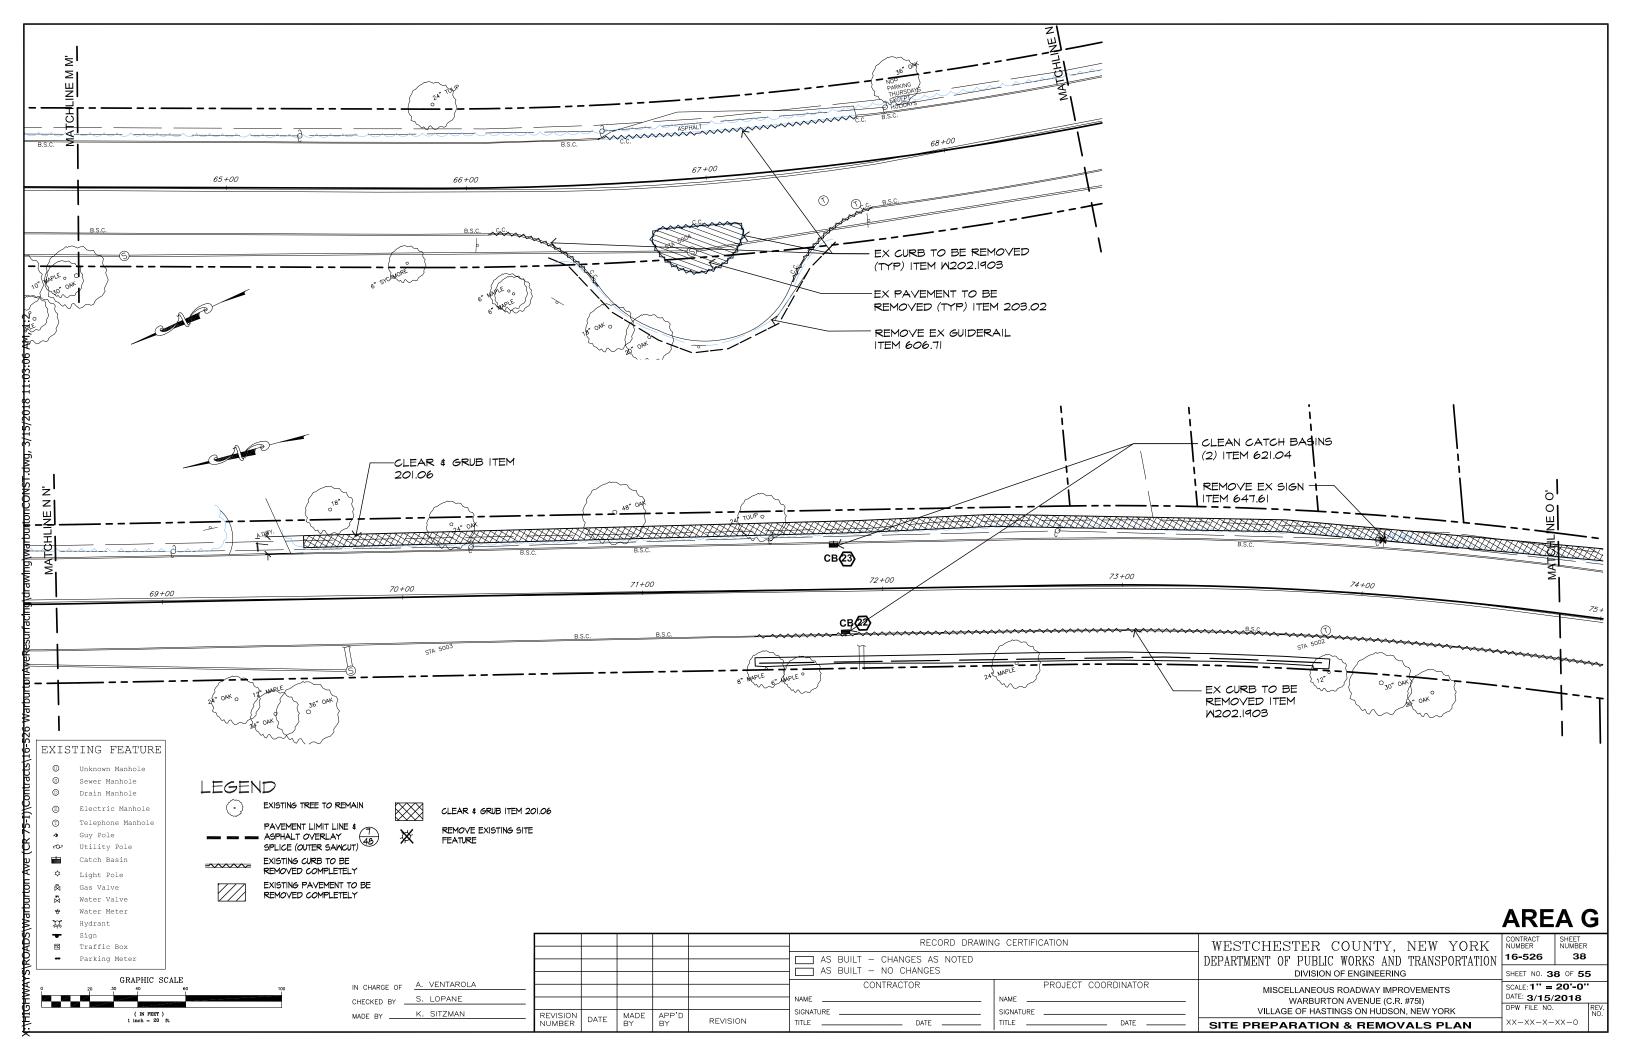

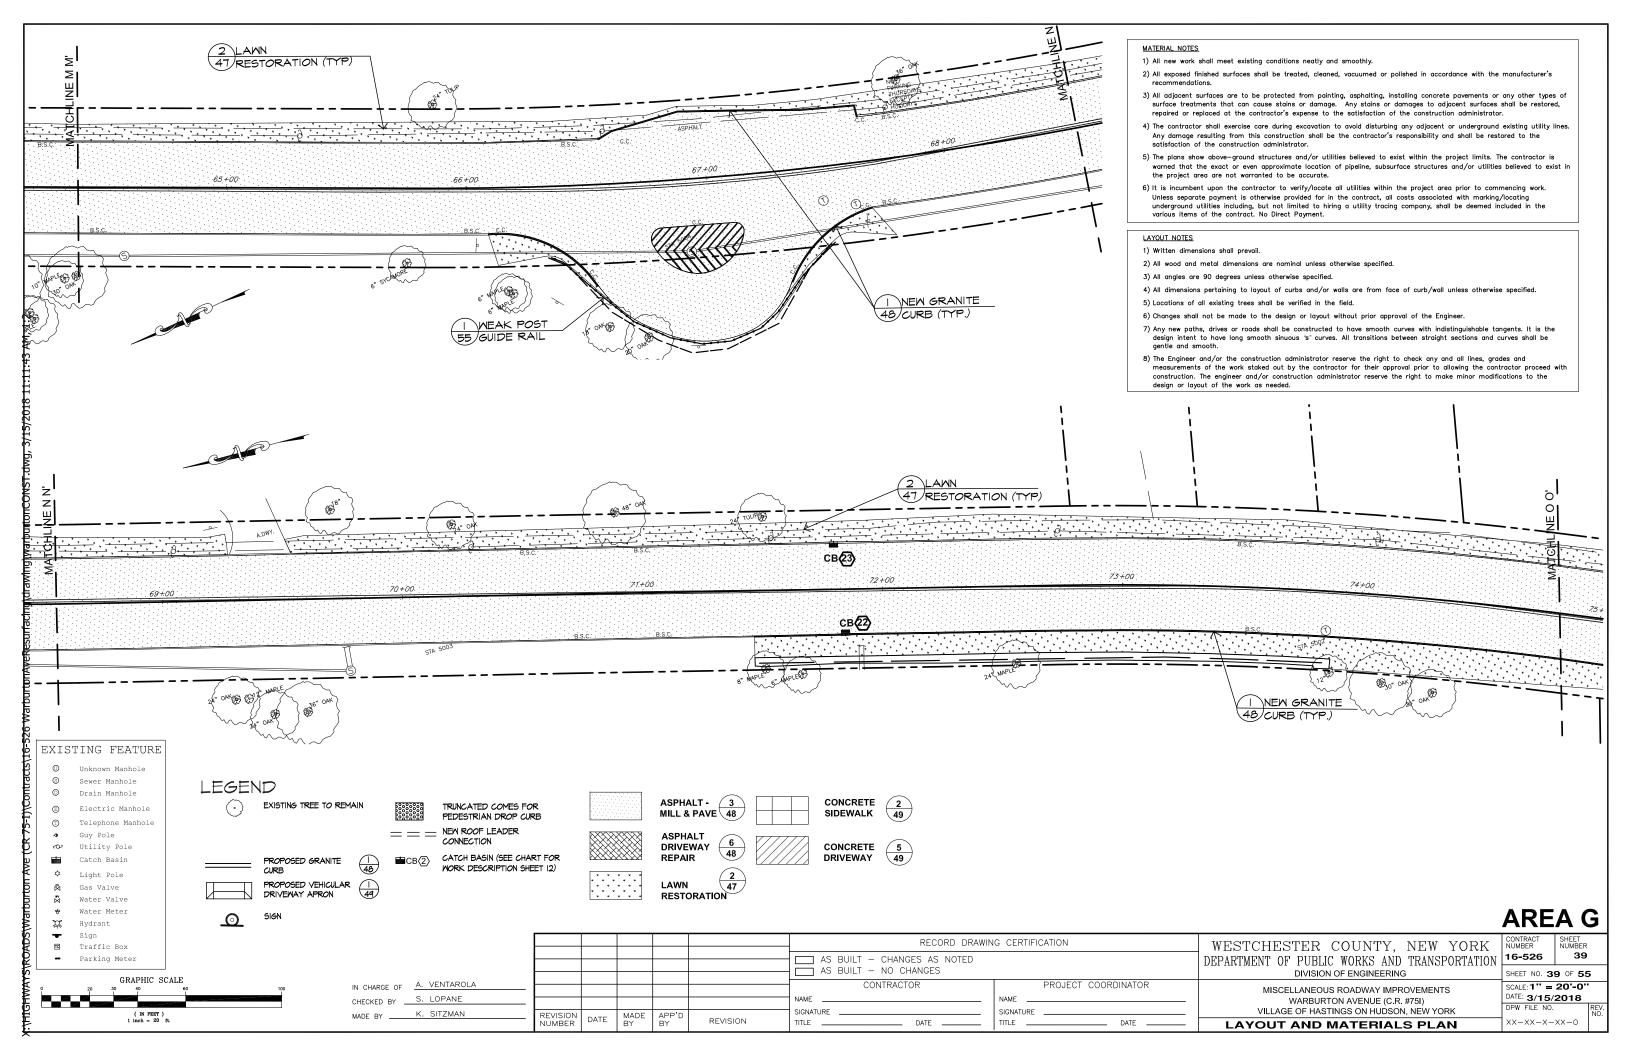

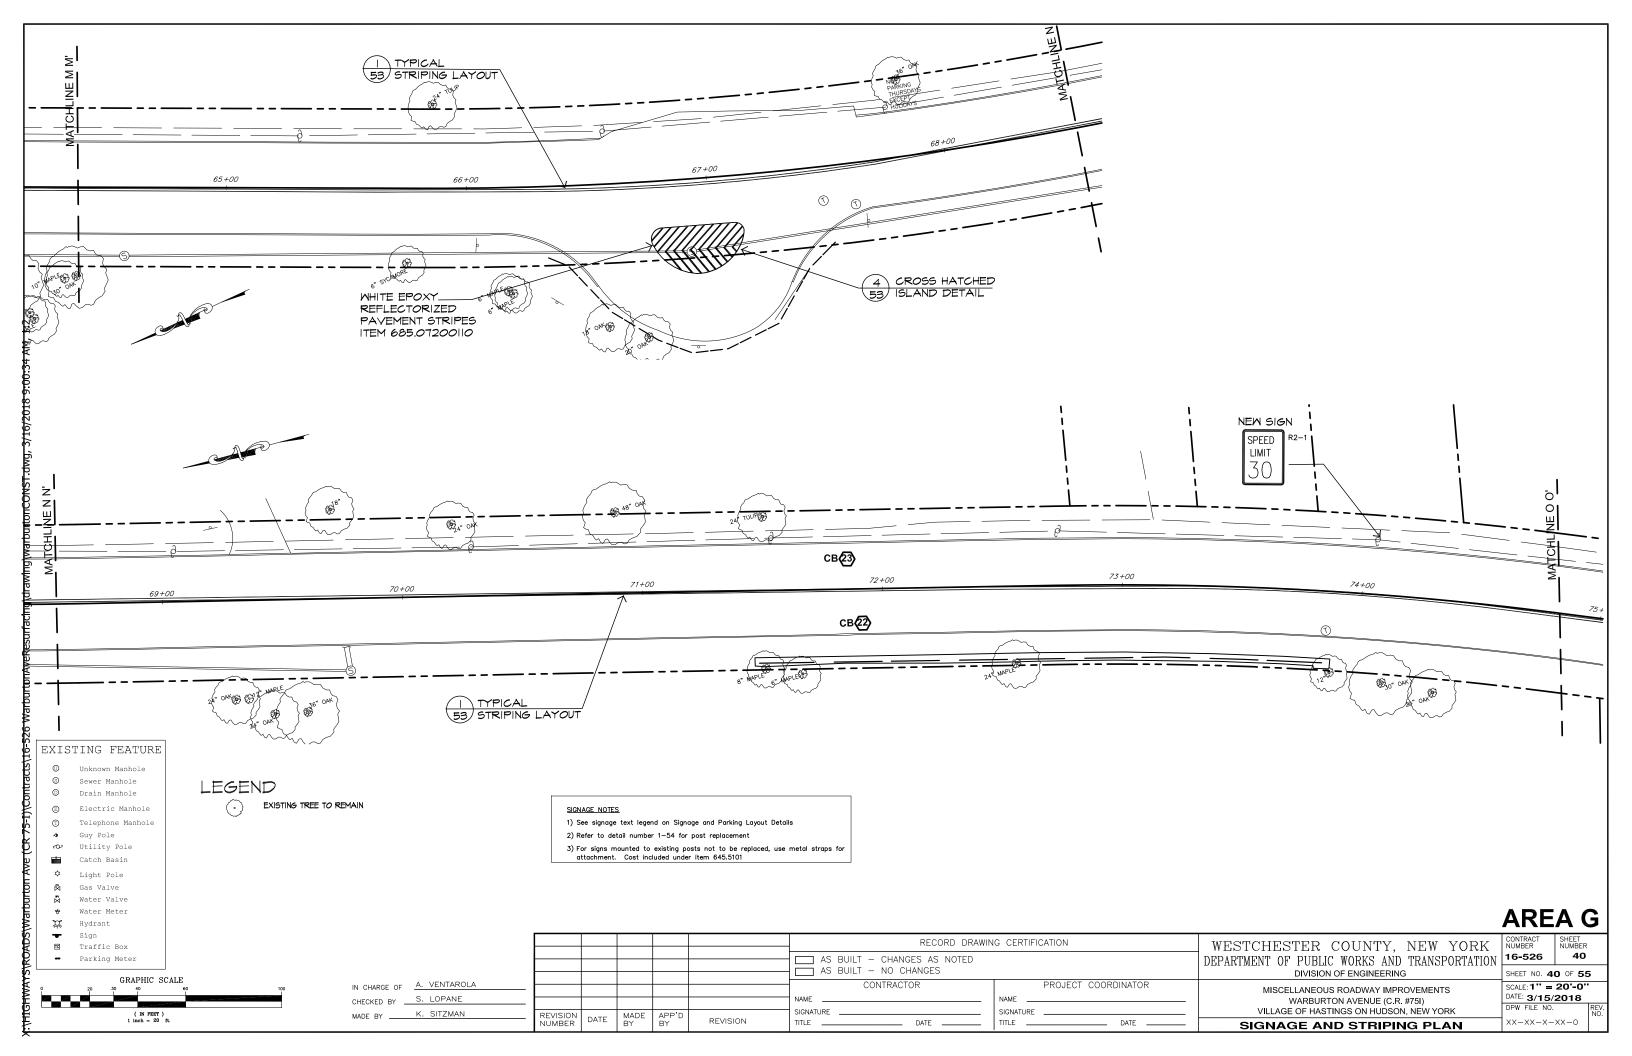

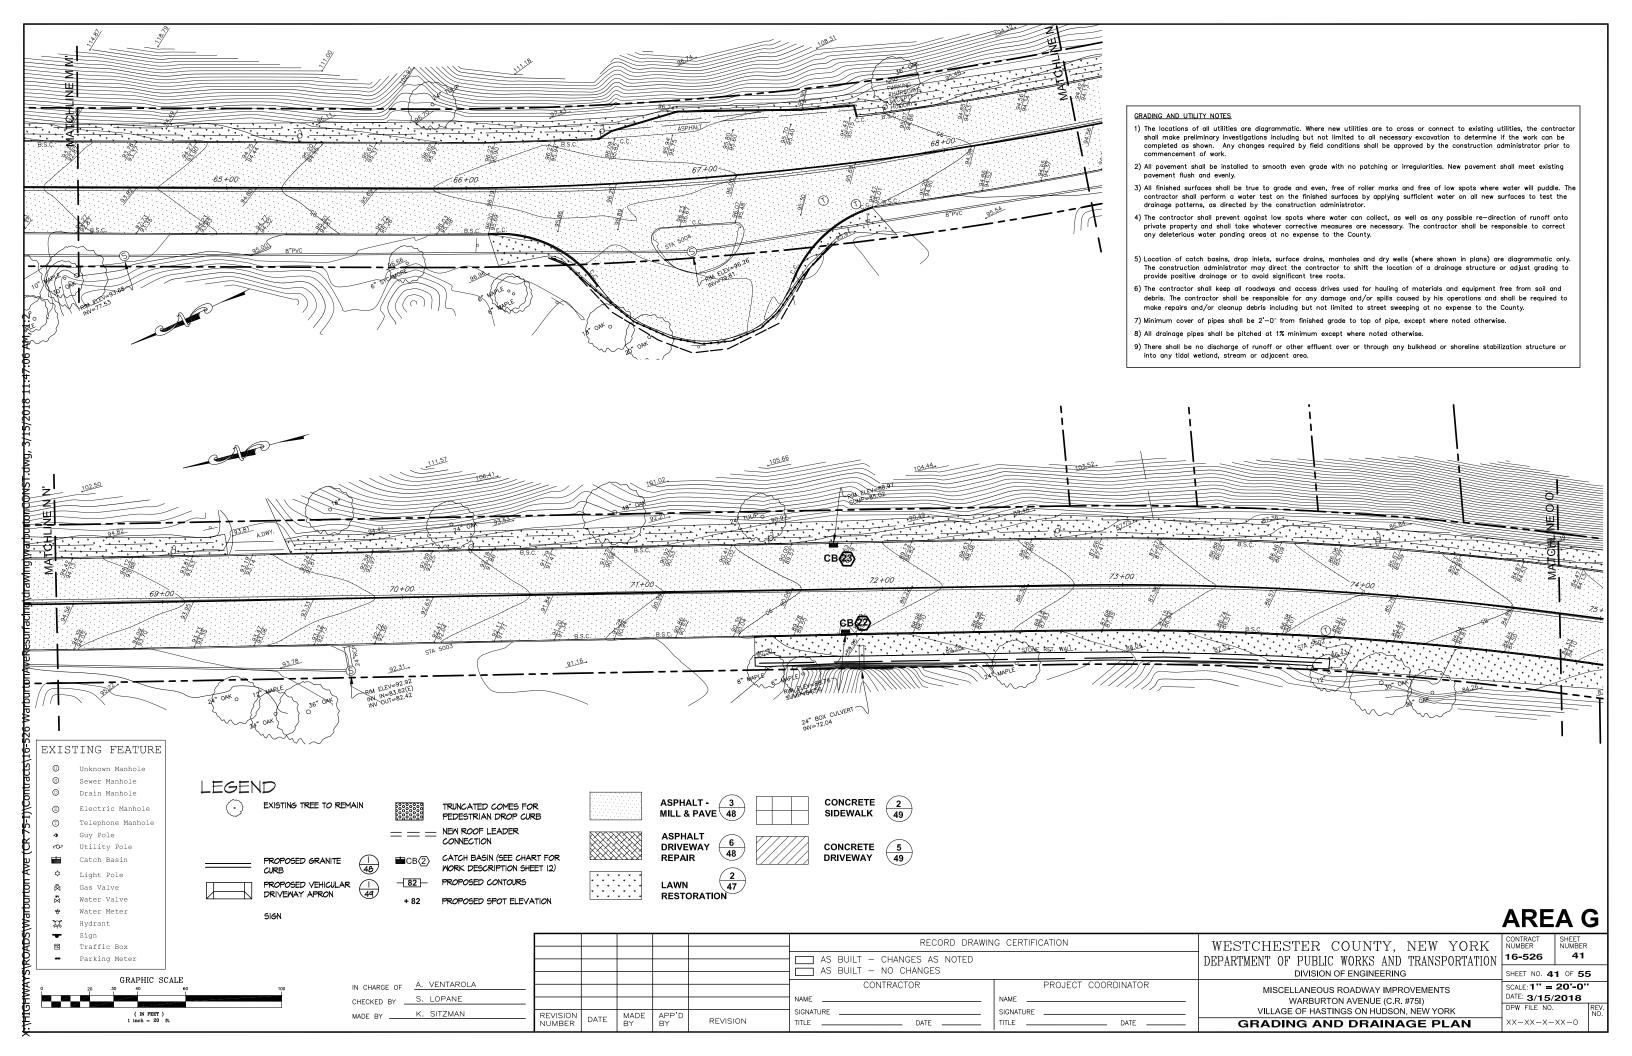


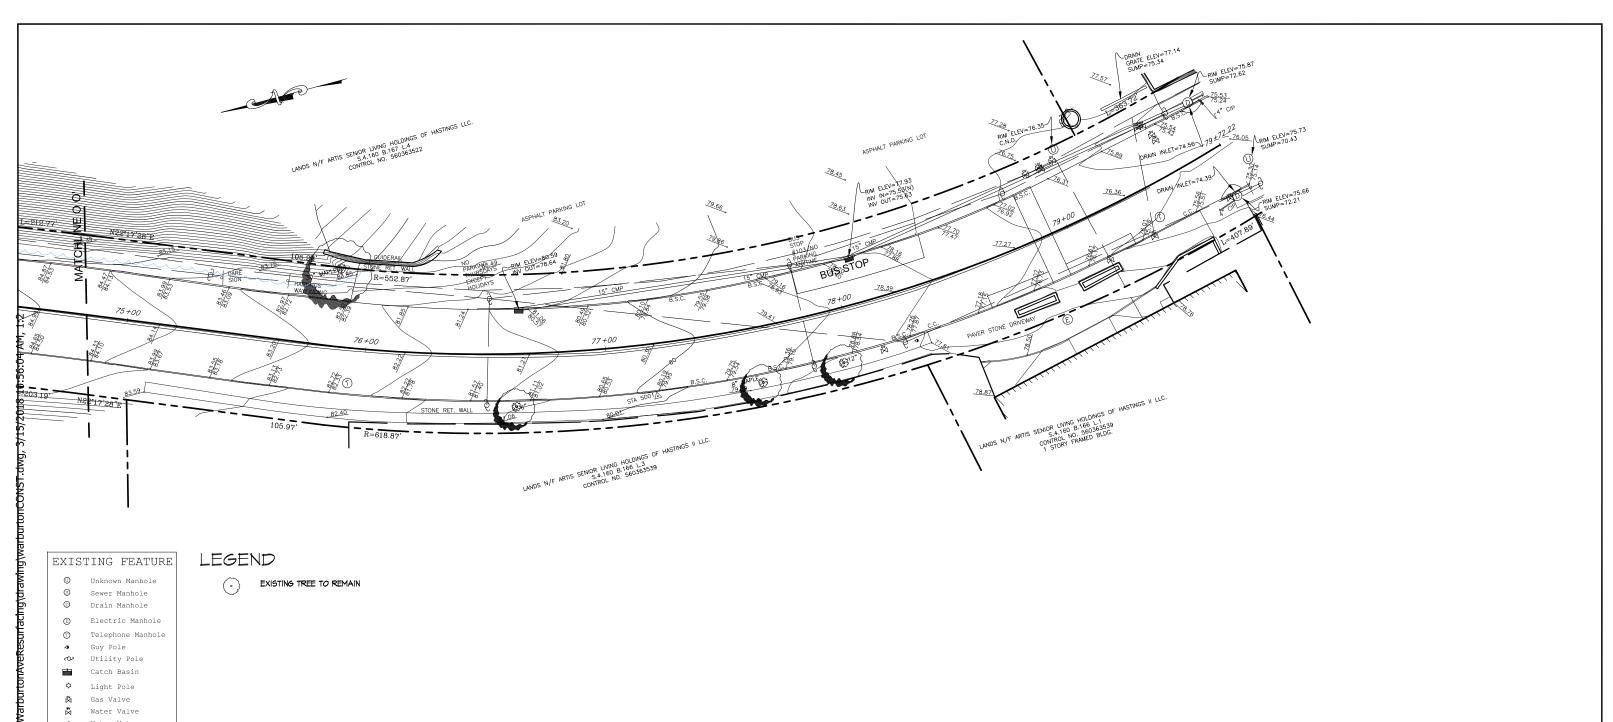



Water Meter Hydrant


Sign Traffic Box Parking Meter


AREA H

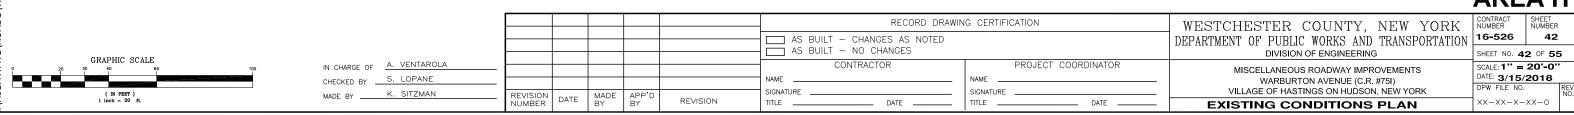


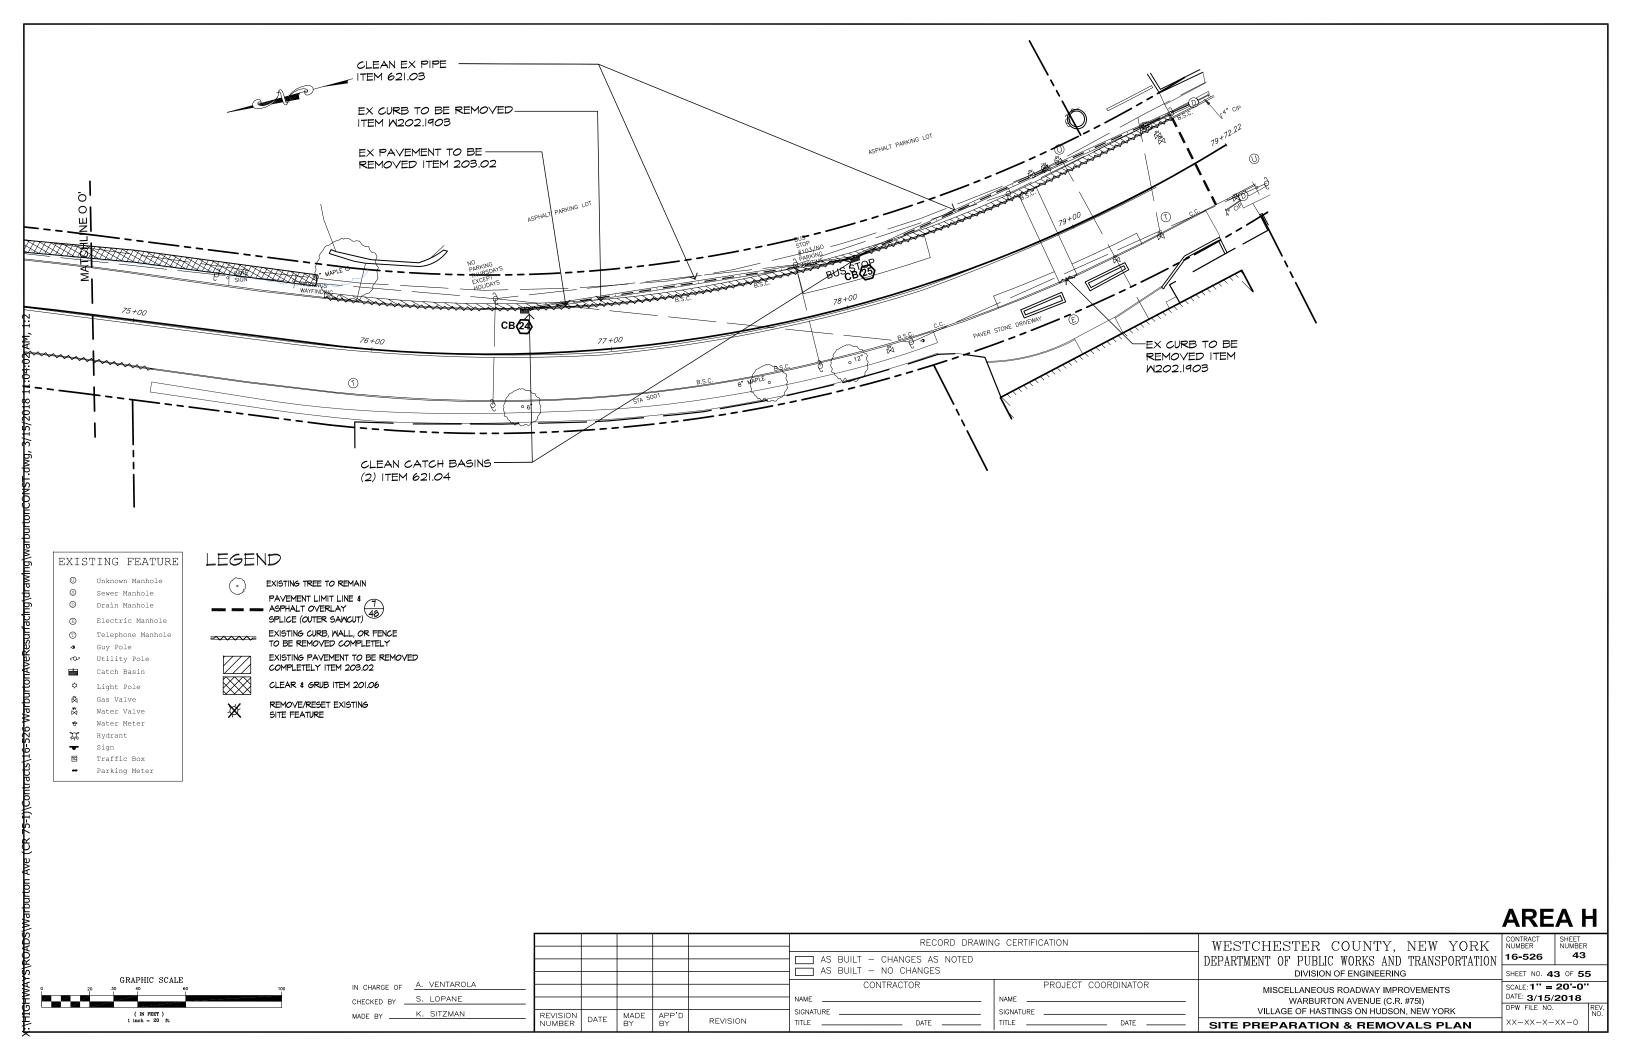

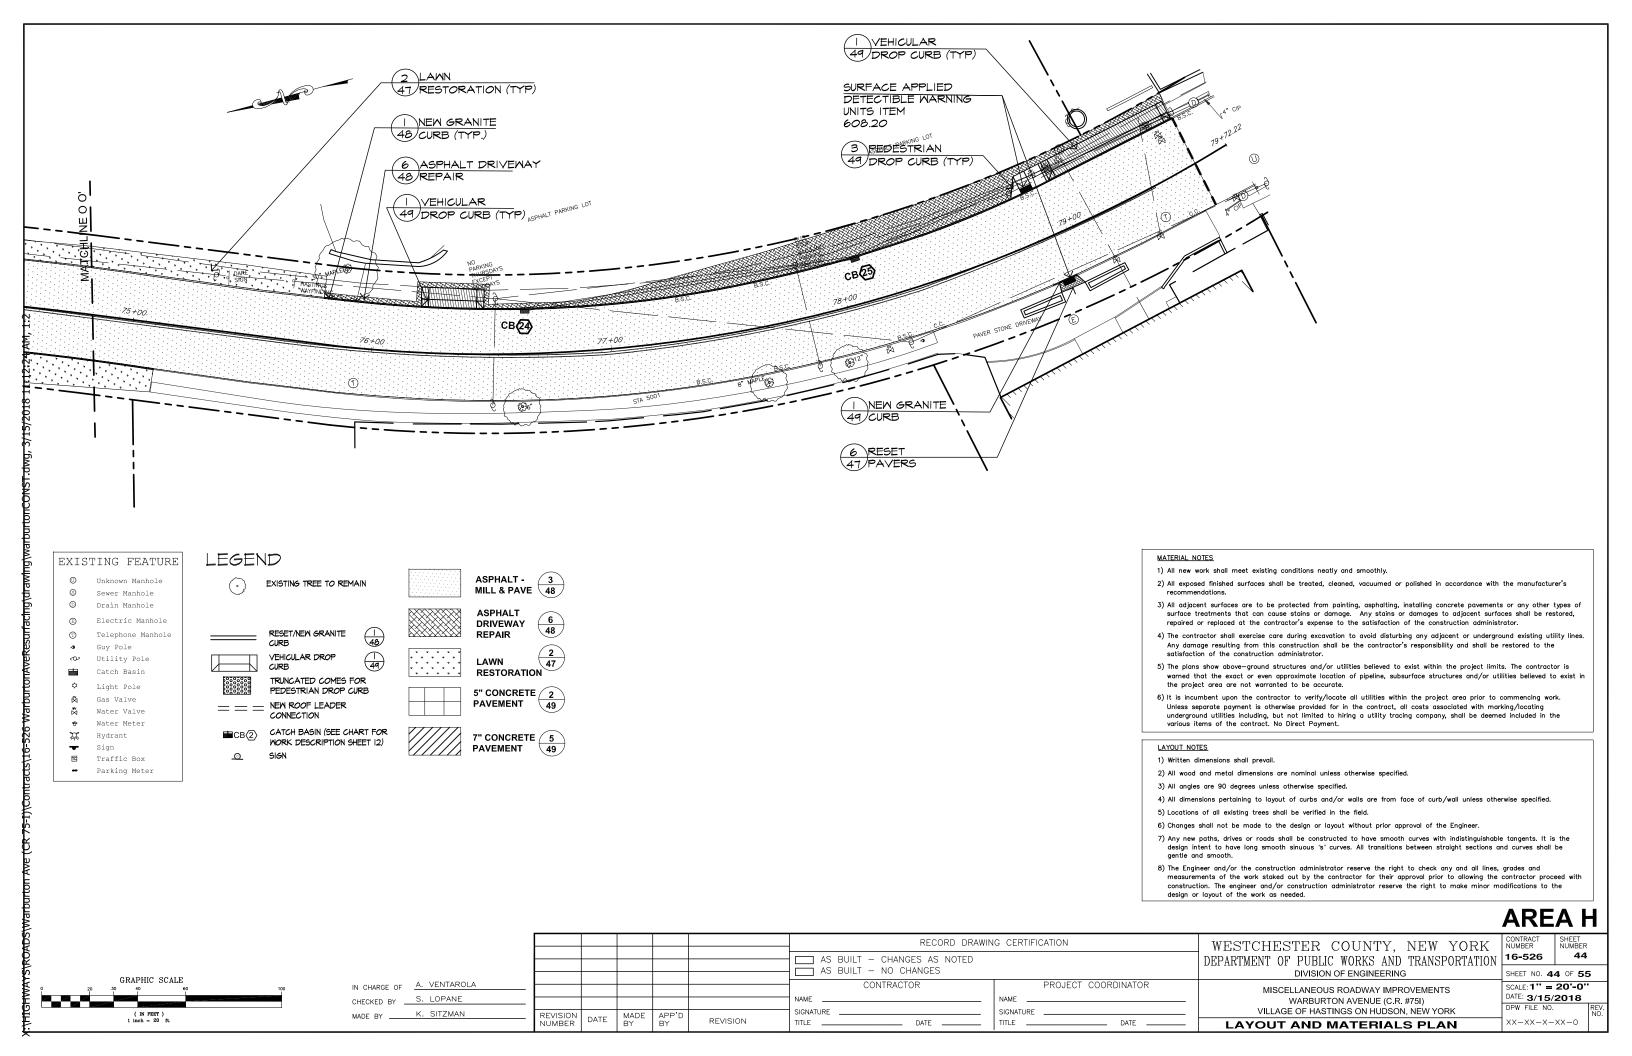

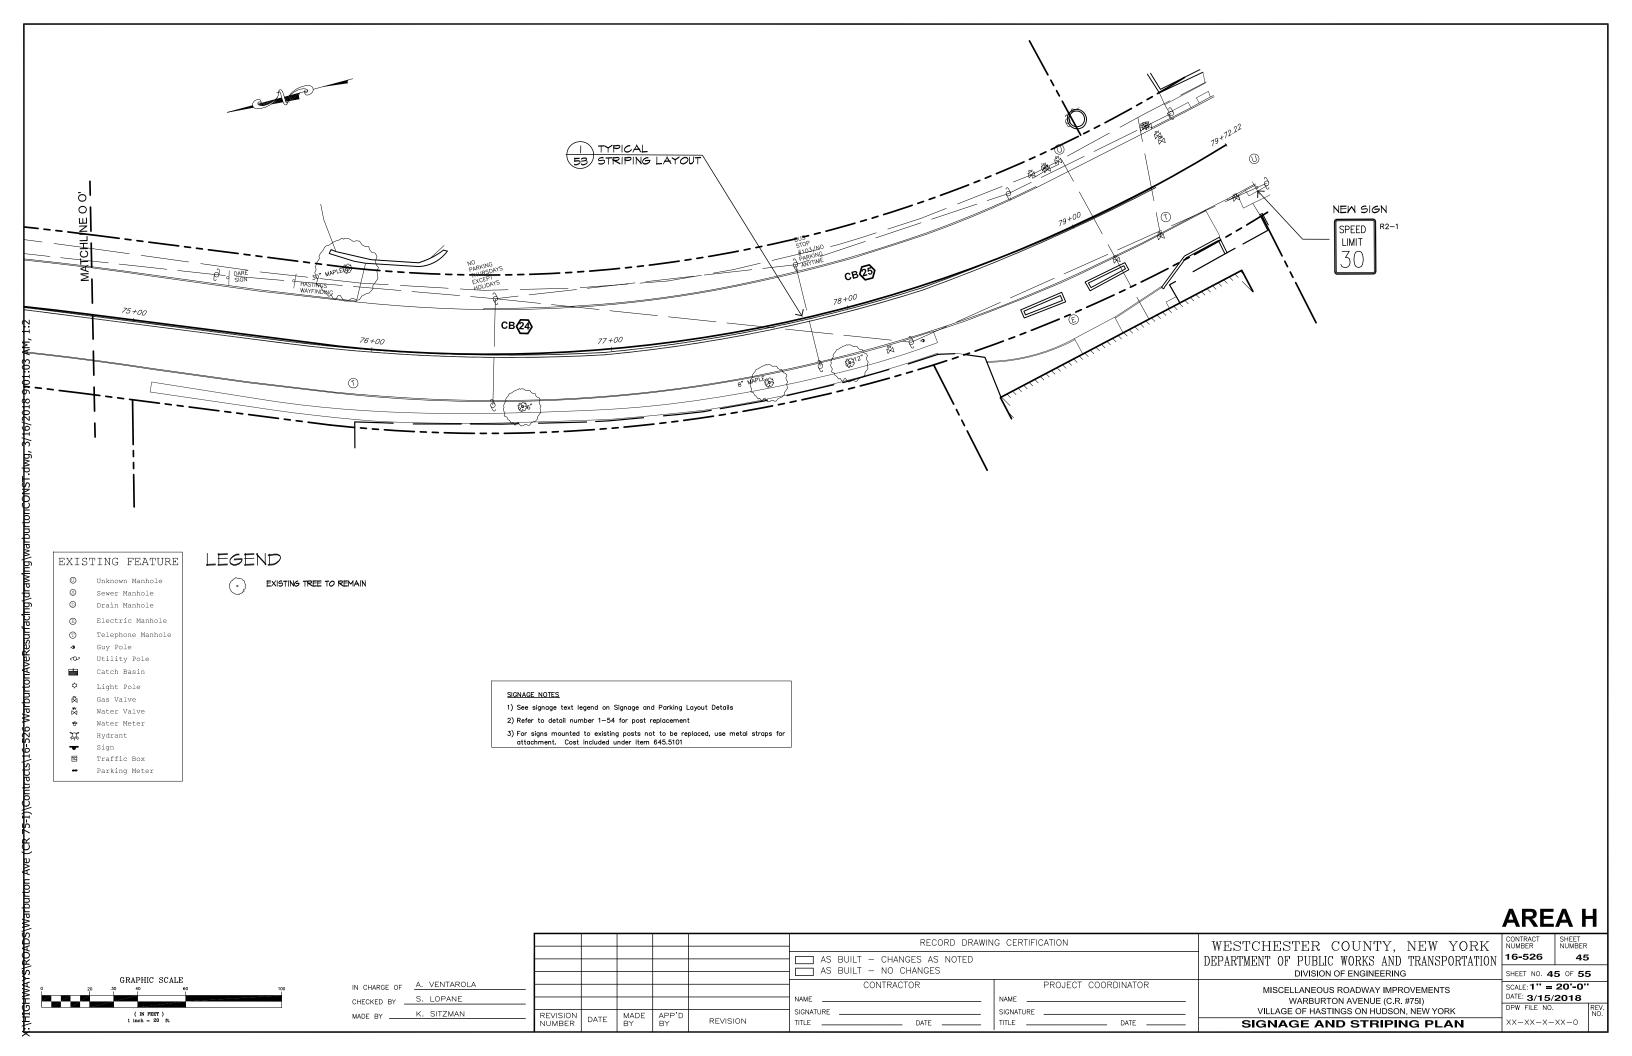


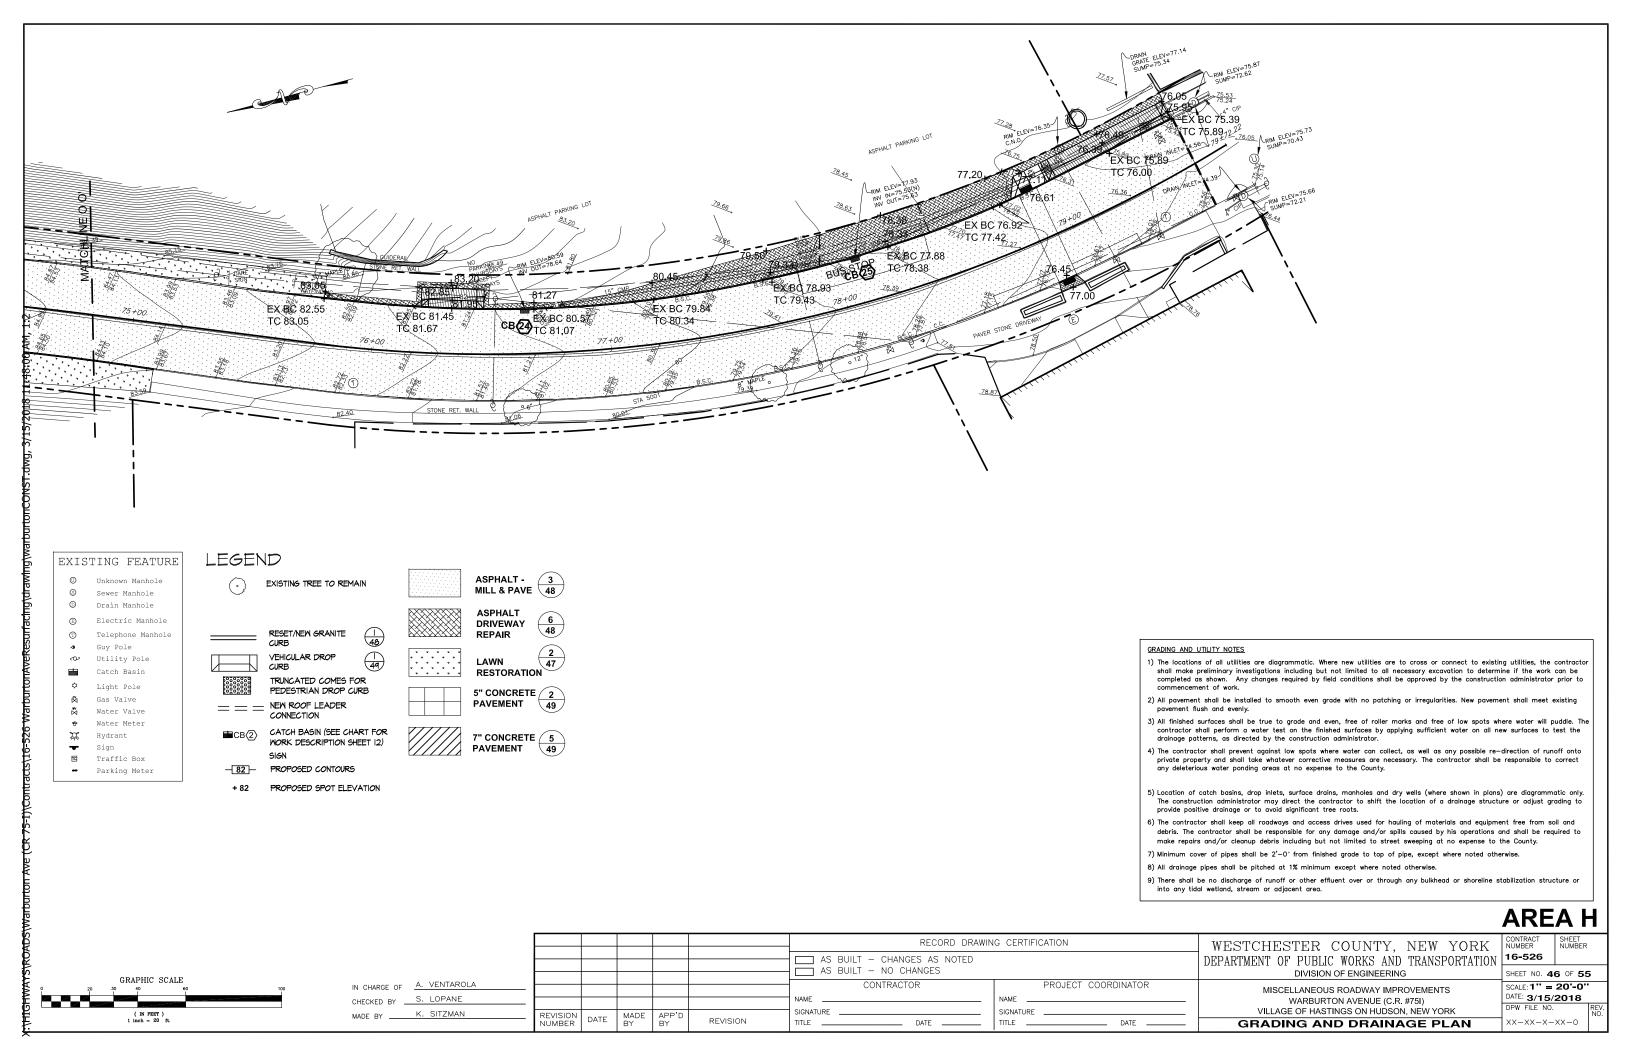

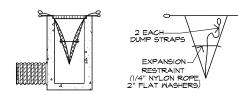

INSTALLATION DETAIL

BAG DETAIL

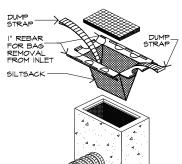

NOTES:


THE CONTRACTOR IS RESPONSIBLE FOR CLEANING AND MAINTAINING THE SILT-SACKS THROUGHOUT THE JOB. THIS INCLUDES REPLACEMENT OF THE SACK BECOMES DAMAGED.


- 2. ADDITIONALLY, THE CONTRACTOR IS REQUIRED TO CLEAN ANY SEDEMENTATION
 RELEASED OUT OF THE CONTRACT LIMIT LINE
 WHICH IS A RESULT OF THE CONSTRUCTION OF THIS JOB.
- 3. SILT SACK SHALL BE INSTALLED ON ALL NEW AND/OR RELOCATED CATCH BASINS AFTER INSTALLATION/RELOCATION AND SHALL BE MAINTAINTED THROUGHOUT THE LIFE OF THE PROJECT.

1 SEDIMENT FILTER BAG

NOT TO SCALE




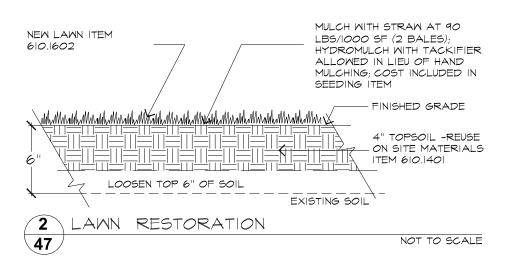

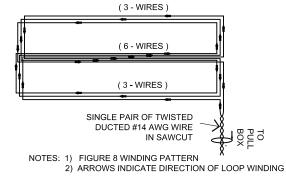


QUADRUPOLE LOOP DETECTOR WINDING PATTERN

NOT TO SCALE

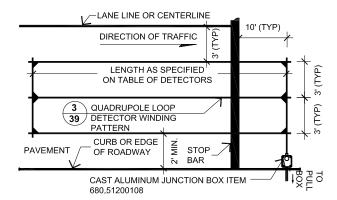


4 QUADRUPOLE LOOP 47 INSTALLATION DETAILS SCALE 4" = 1'-0"


TABLE OF DETECTORS										
SIGNAL NO.	DETECTOR NO.	TYPE	MODE	SIZE	NO OF TURNS					
30	3A, 13A	QUAD	PRESENCE	2 - 3' X 20'	3-6-3					
30	3B, 13B	LOOP	PRESENCE	6' X 30'	3					
48	3-6A	QUAD	PRESENCE	2- 3' X 40'	3-6-3					

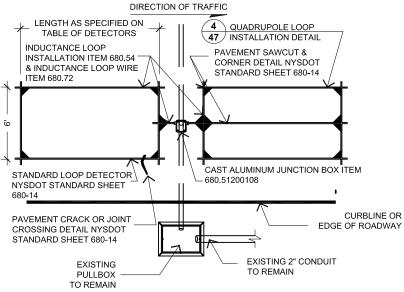



VEHICLE DETECTOR INSTALLATION (DUAL PRESENCE LOOPS) SCALE $\frac{1}{4}$ " = 1'-0"

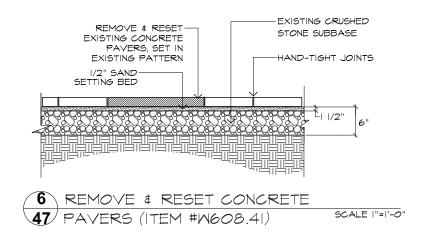

						RECORD DRAWIN	IG CERTIFICATION	WESTCHESTER COUNTY, NEW YORK	CONTRACT NUMBER	SHEET NUMBER
						AS BUILT — CHANGES AS NOTED		DEPARTMENT OF PUBLIC WORKS AND TRANSPORTATION	16-526	47
						AS BUILT - NO CHANGES		DIVISION OF ENGINEERING	SHEET NO. 4	
IN CHARGE OF A. VENTAROLA						CONTRACTOR	PROJECT COORDINATOR	MISCELLANEOUS ROADWAY IMPROVEMENTS	SCALE: AS S	
CHECKED BY S. LOPANE						NAME	NAME	WARBURTON AVENUE (C.R. #751) VILLAGE OF HASTINGS ON HUDSON, NEW YORK	DPW FILE NO.	
MADE BY K. SITZMAN	REVISION NUMBER	DATE	MADE BY	APP'D BY	REVISION	SIGNATURE DATE	SIGNATURE DATE	SITE PREPARATION & RESTORATION DETAILS		-XX-0 NO.

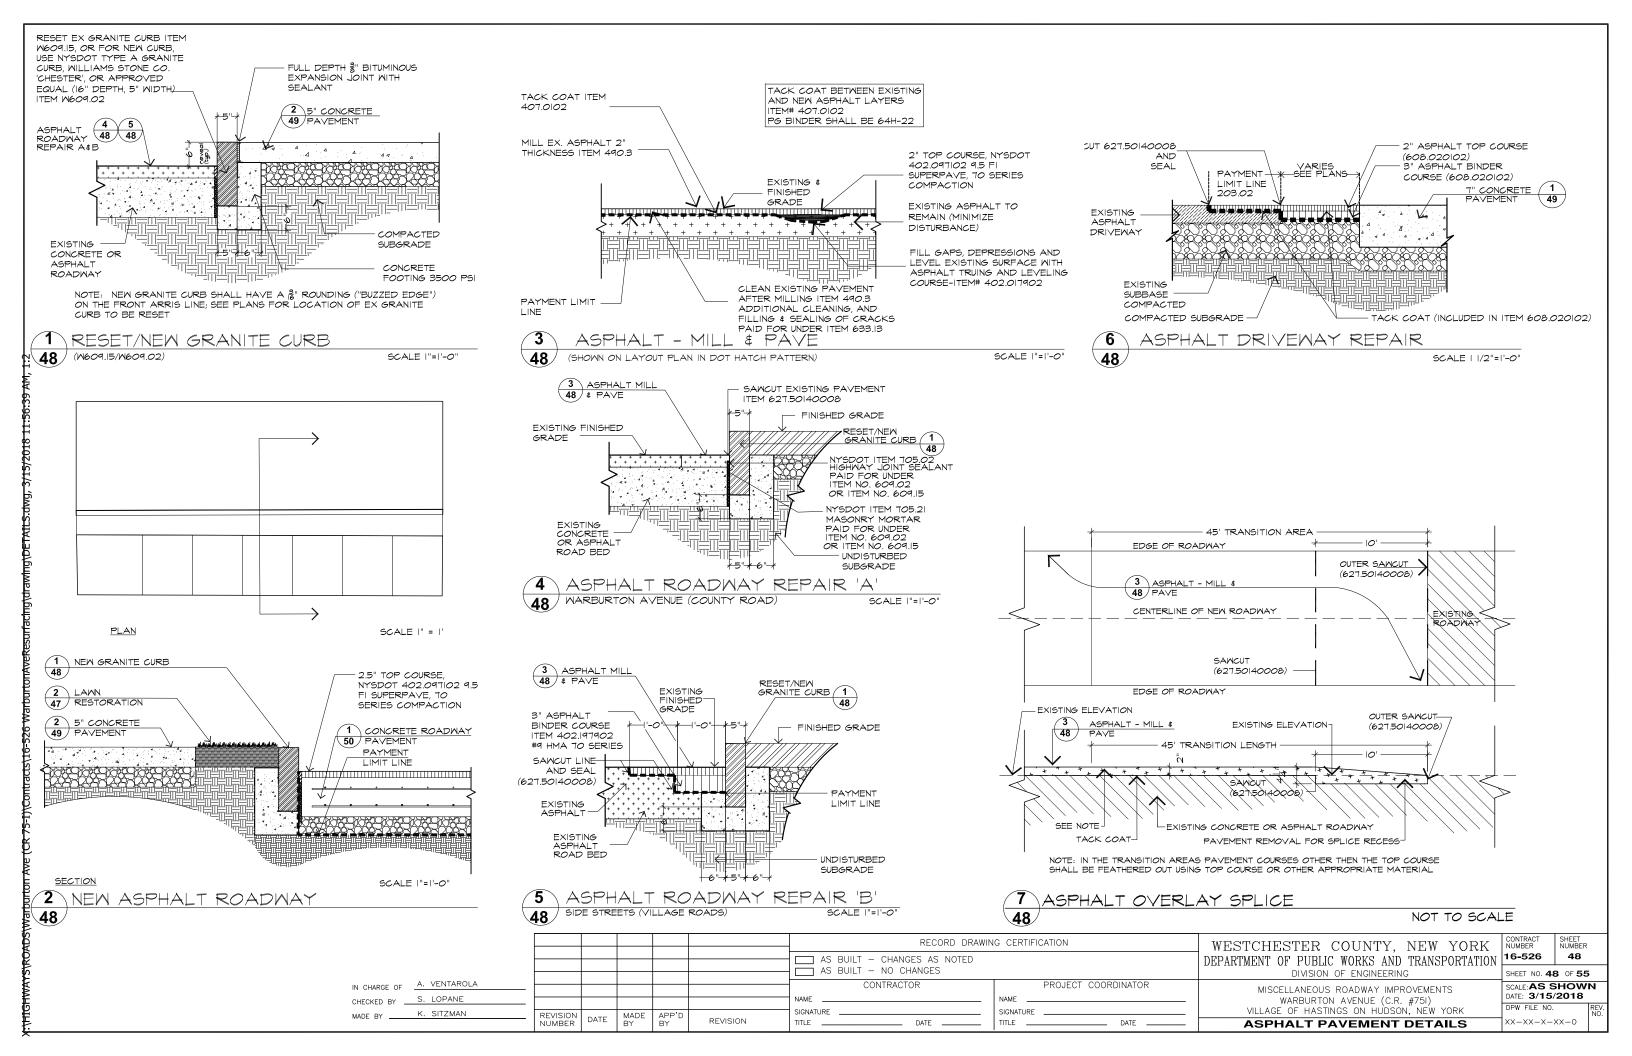

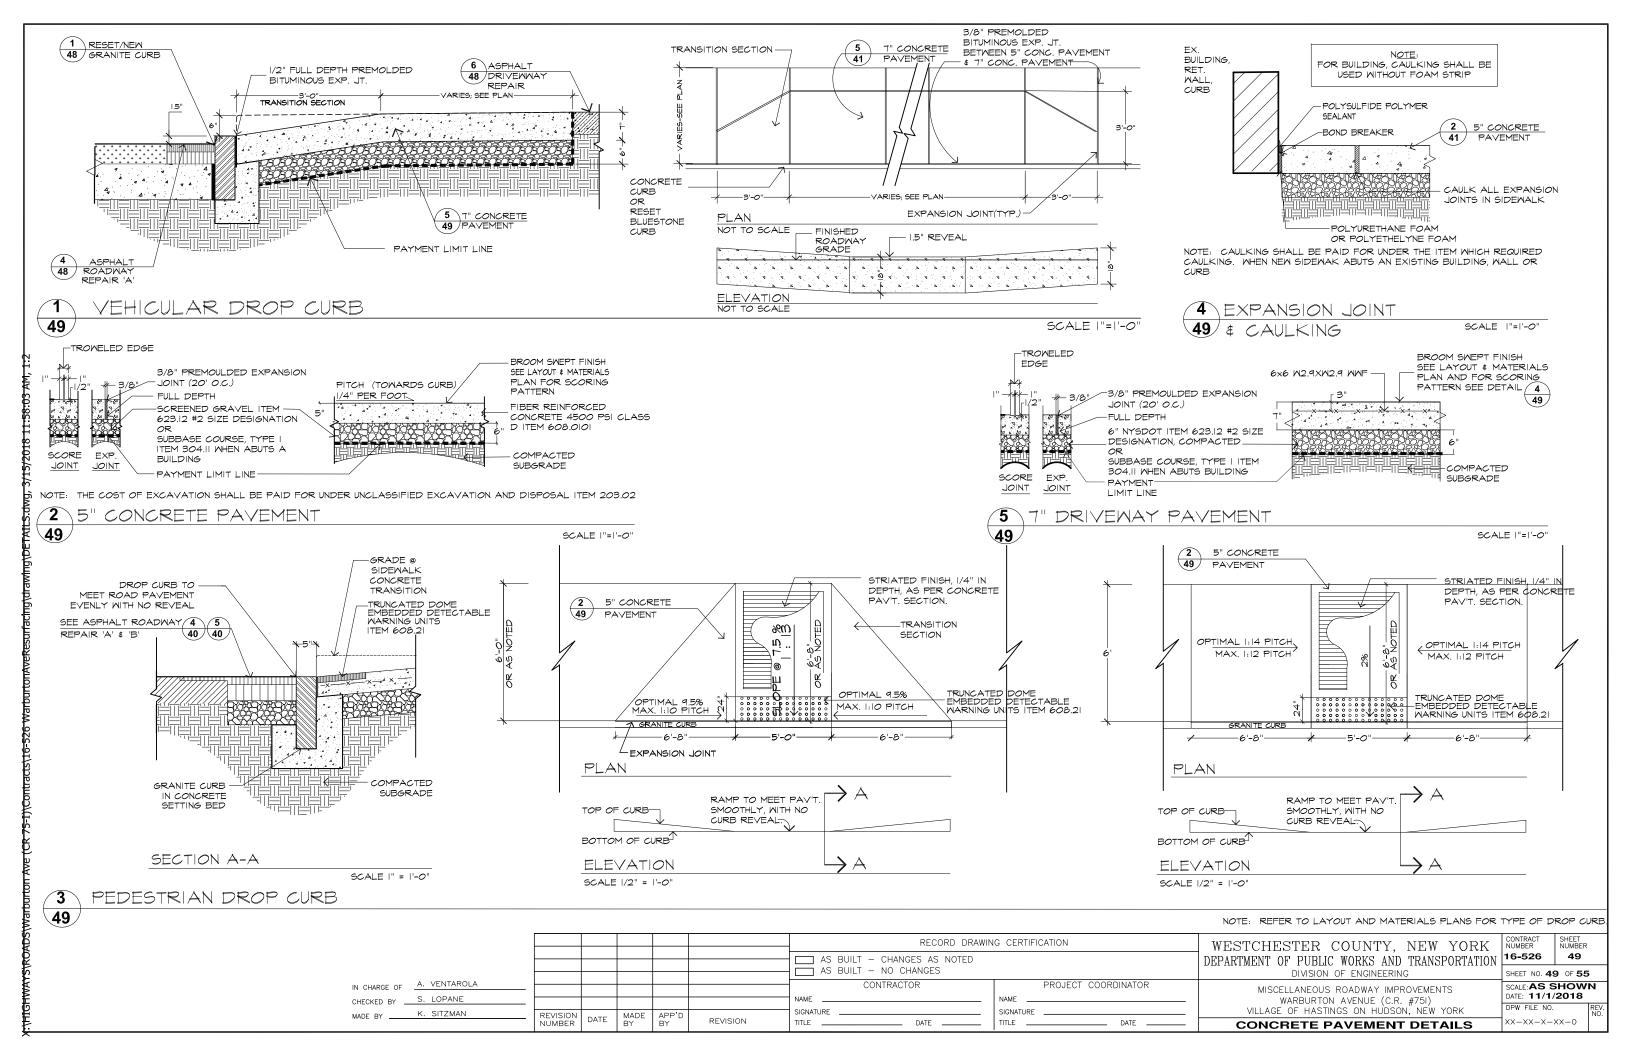

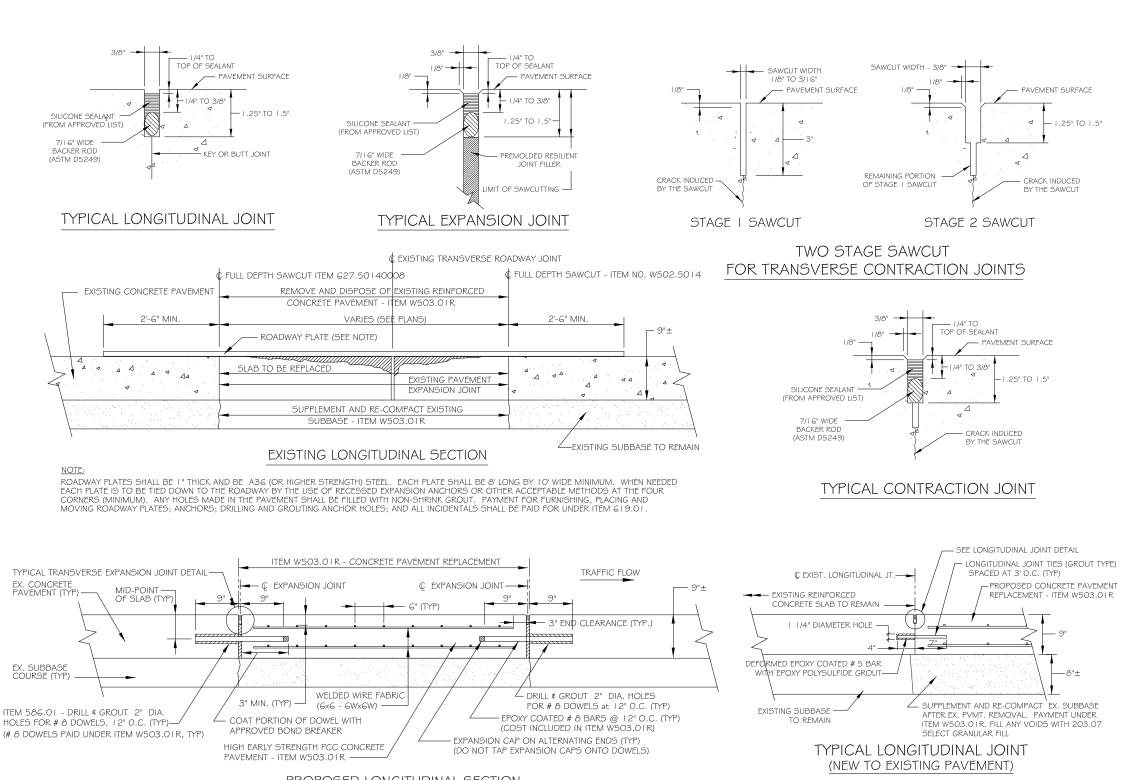

PROPOSED LONGITUDINAL SECTION


CONCRETE ROADWAY PAVEMENT (ITEM W503.01R)
(SEE NYSDOT STANDARD SHEETS FOR ADDITIONAL DETAILS ON LONGITUDINAL AND TRANSVERSE TIES)


NOT TO SCALE

		RECORD DRAWIN	IG CERTIFICATION	WESTCHESTER COUNTY, NEW YORK	CONTRACT SHEET NUMBER NUMBER
		AS BUILT - CHANGES AS NOTED			16-526 50
		AS BUILT - NO CHANGES		DIVISION OF ENGINEERING	SHEET NO. 50 OF 55
IN CHARGE OF A. VENTAROLA CHECKED BY S. LOPANE		CONTRACTOR NAME	PROJECT COORDINATOR		SCALE: AS SHOWN DATE: 3/14/2018
MADE BY K. SITZMAN	REVISION DATE MADE APP'D	SIGNATURE	SIGNATURE	VILLAGE OF HASTINGS ON HUDSON, NEW YORK	DPW FILE NO. REV. NO.
	NUMBER DATE BY BY REVISION	TITLE DATE	TITLE DATE	CONCRETE REPAIR DETAILS	XX-XX-X-XX-0

l			Existing Drain Inl	let Dra	ainage Chart				
		Cleaning (Item 621.04)	Work	Filter	Size of Frame	Size of Grate	Comments		
	CB #1	Yes	Replace Grate with Bicycle Safe Grate (Item W604.0203)		31 1/2" x 19 1/2"	18" x 30"	Model #		
	CB #2	Yes	Protect & Preserve		49 1/2" x 24"	47 1/2" x 22"			
	CB #3	Yes	Protect & Preserve						
	CB #4	Yes	Protect & Preserve						
	CB #5	Yes	Protect & Preserve						
Ł	CB #6	Yes	Protect & Preserve						
Į.	CB #7	Yes	Protect & Preserve						
È			Manhole Slab Replacement						
þ	CB #8	Yes	(Item W604.0202); Alter Drainage			•	Catch Basin Frame,		
ŧ		'	Structure - Replace Grate Item Grate and Curb Piece I				/lodel #2617		
3/15/2018 11:59	\vdash		W604.0203	<u> </u>			Catch Basin		
K	2/0	Furnisł	h and Install Replacement Drain Ir	Frame, Grate					
F	CB #9	i uninc.	and Curb Piece						
Ř,			Piece (Item W60	Model # 2617					
þ	CB #10	Yes	Protect & Preserve						
K	CB #11	Yes	Protect & Preserve						
₽	CB #12	Yes	Protect & Preserve						
awit	CB #13	Yes	Preserve & Protect						
	CB #14	Yes	Preserve & Protect				Basin filled with debris		
Ē	CB #15	Yes	Preserve & Protect						
Res	CB #16	Yes	Preserve & Protect						
K	CB #17	Yes	Preserve & Protect						
B	CB #18		Preserve & Protect						
Variet	CB #19		Preserve & Protect						
Ē	CB #20	Yes	Preserve & Protect						
j d	CB #21	Yes	Preserve & Protect						
E	CB #22	Yes	Preserve & Protect						
Ħ	CB #23	Yes	Preserve & Protect						
þ	CB #24	Yes	Replace Grate with Bicycle Safe				Model # 2617		
ŧ			Grate (Item W604.0203)	<u> </u>			1		
ve (CR 75-I)\Contrac	CB #25	Yes	Replace Grate with Bicycle Safe Grate (Item W604.0203)				Model # 2617		
þ	Not	es: All dra	ain inlets to be cleaned. Model nu	ımber	s refer to Cam	pbell Foundry,	, or approved		

Notes: All drain inlets to be cleaned. Model numbers refer to Campbell Foundry, or approved equal. New Catch Basins Chart on Sheet 26

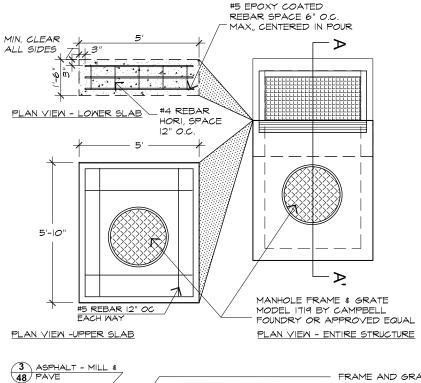


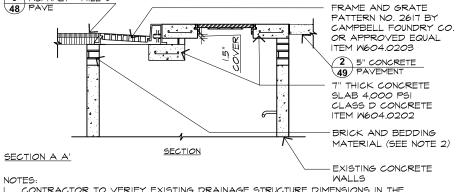

CONTRACTOR TO VERIFY EXISTING DRAINAGE STRUCTURE DIMENSIONS IN THE

2. BEDDING MATERIAL SHALL BE CONCRETE REPAIR (NYSDOT 701-04) OR CONCRETE GROUTING (NYSDOT 701-05) MATERIAL.



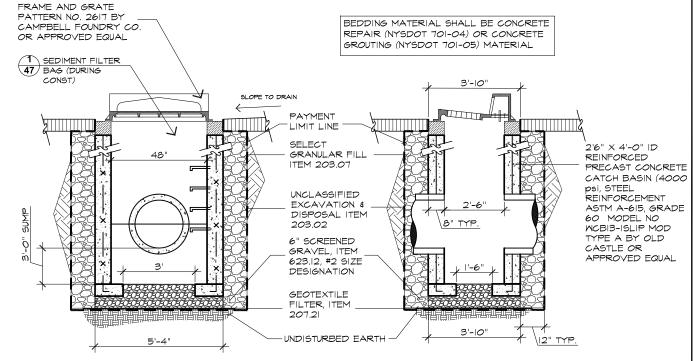

- NOTES:

 I. CATCH BASIN AND FRAME AND GRATE SHALL MEET REQUIREMENTS FOR H20 LOADING.


 2. CATCH BASIN STRUCTURE, FRAME AND GRATE BRICKWORK AND GROUTING SHALL BE INCLUDED IN ITEM W604.0201
- 3. ALL NEW CATCH BASINS SHALL BE FITTED WITH A FILTER. SEE THE DRAINAGE CHART FOR SPECIFICS.


2 NEW CATCH BASIN WITH CURB PIECE


51 (N604.0201)

SCALE 1/2" = 1'-0"


					RECORD DRAWI	NG CERTIFICATION	WESTCHESTER COUNTY, NEW YORK DEPARTMENT OF PUBLIC WORKS AND TRANSPORTATION	1.0 -00	SHEET NUMBER 51
IN CHARGE OF A. VENTAROLA CHECKED BY S. LOPANE MADE BY K. SITZMAN	REVISION NUMBER DATE	MADE BY	APP'D BY	REVISION	AS BUILT — NO CHANGES CONTRACTOR NAME SIGNATURE TITLE DATE	PROJECT COORDINATOR NAME SIGNATURE TITLE DATE	DIVISION OF ENGINEERING MISCELLANEOUS ROADWAY IMPROVEMENTS WARBURTON AVENUE (C.R. #751) VILLAGE OF HASTINGS ON HUDSON, NEW YORK	SHEET NO. 5 SCALE: AS S DATE: 3/15, DPW FILE NO. XX-XX-X-	SHOWN 5/2018 . REV. NO.

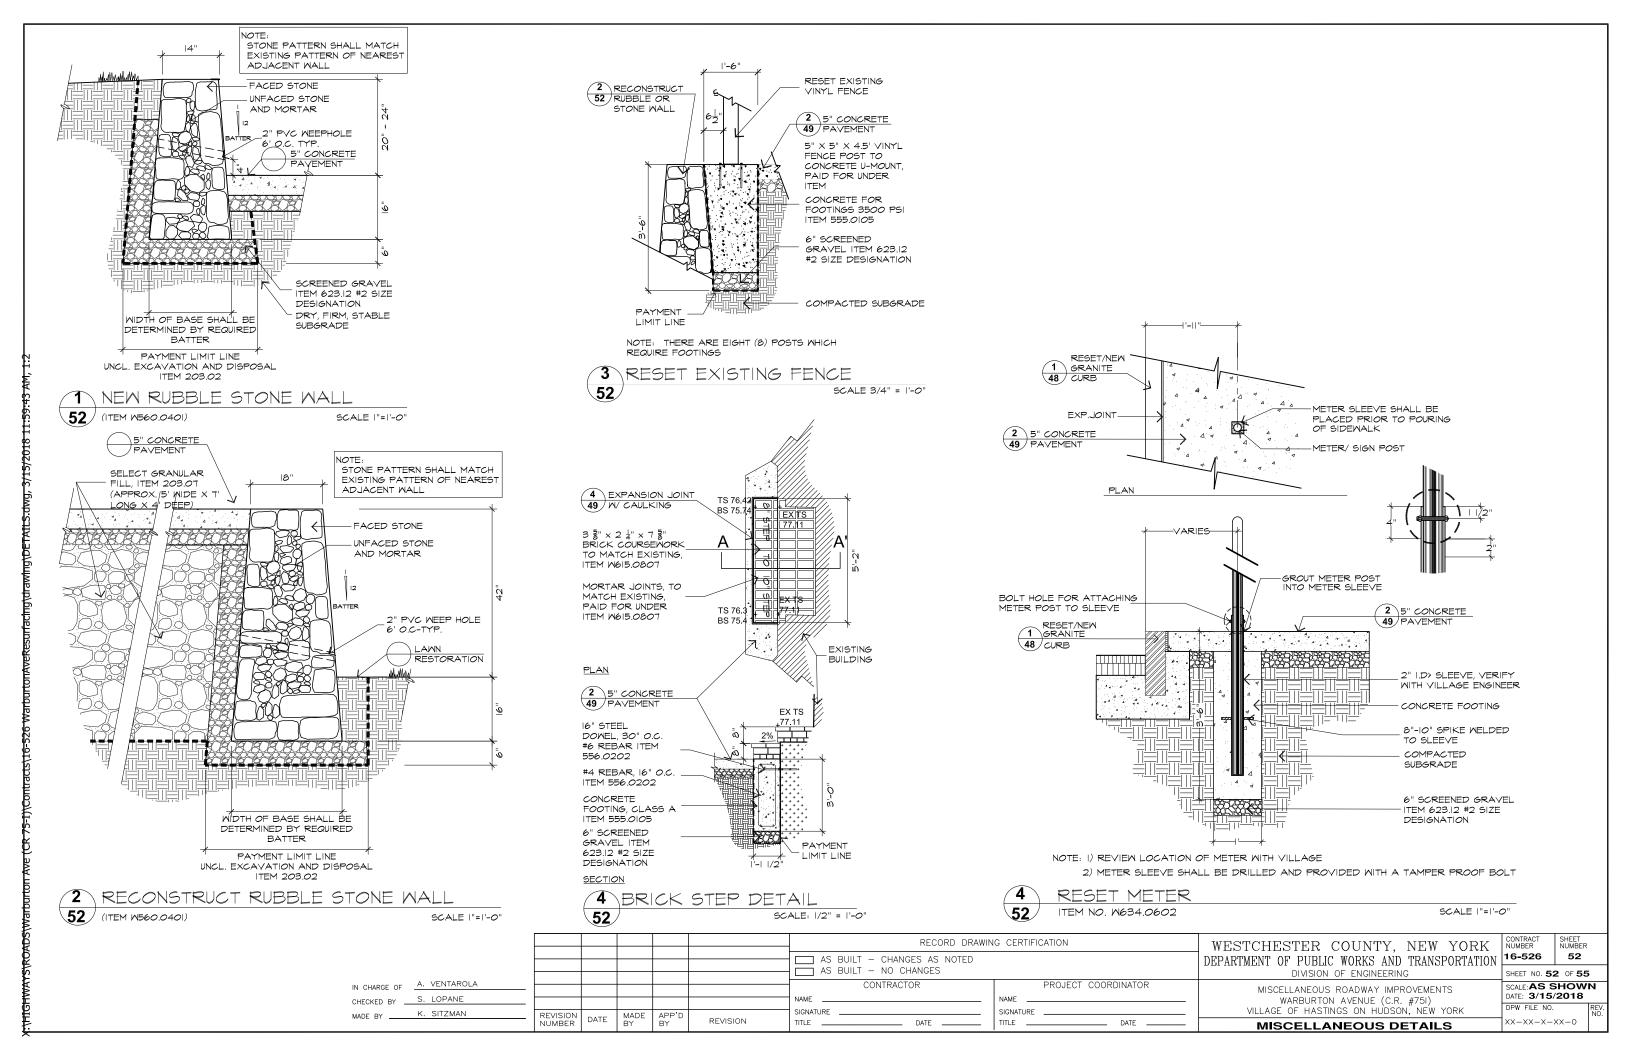

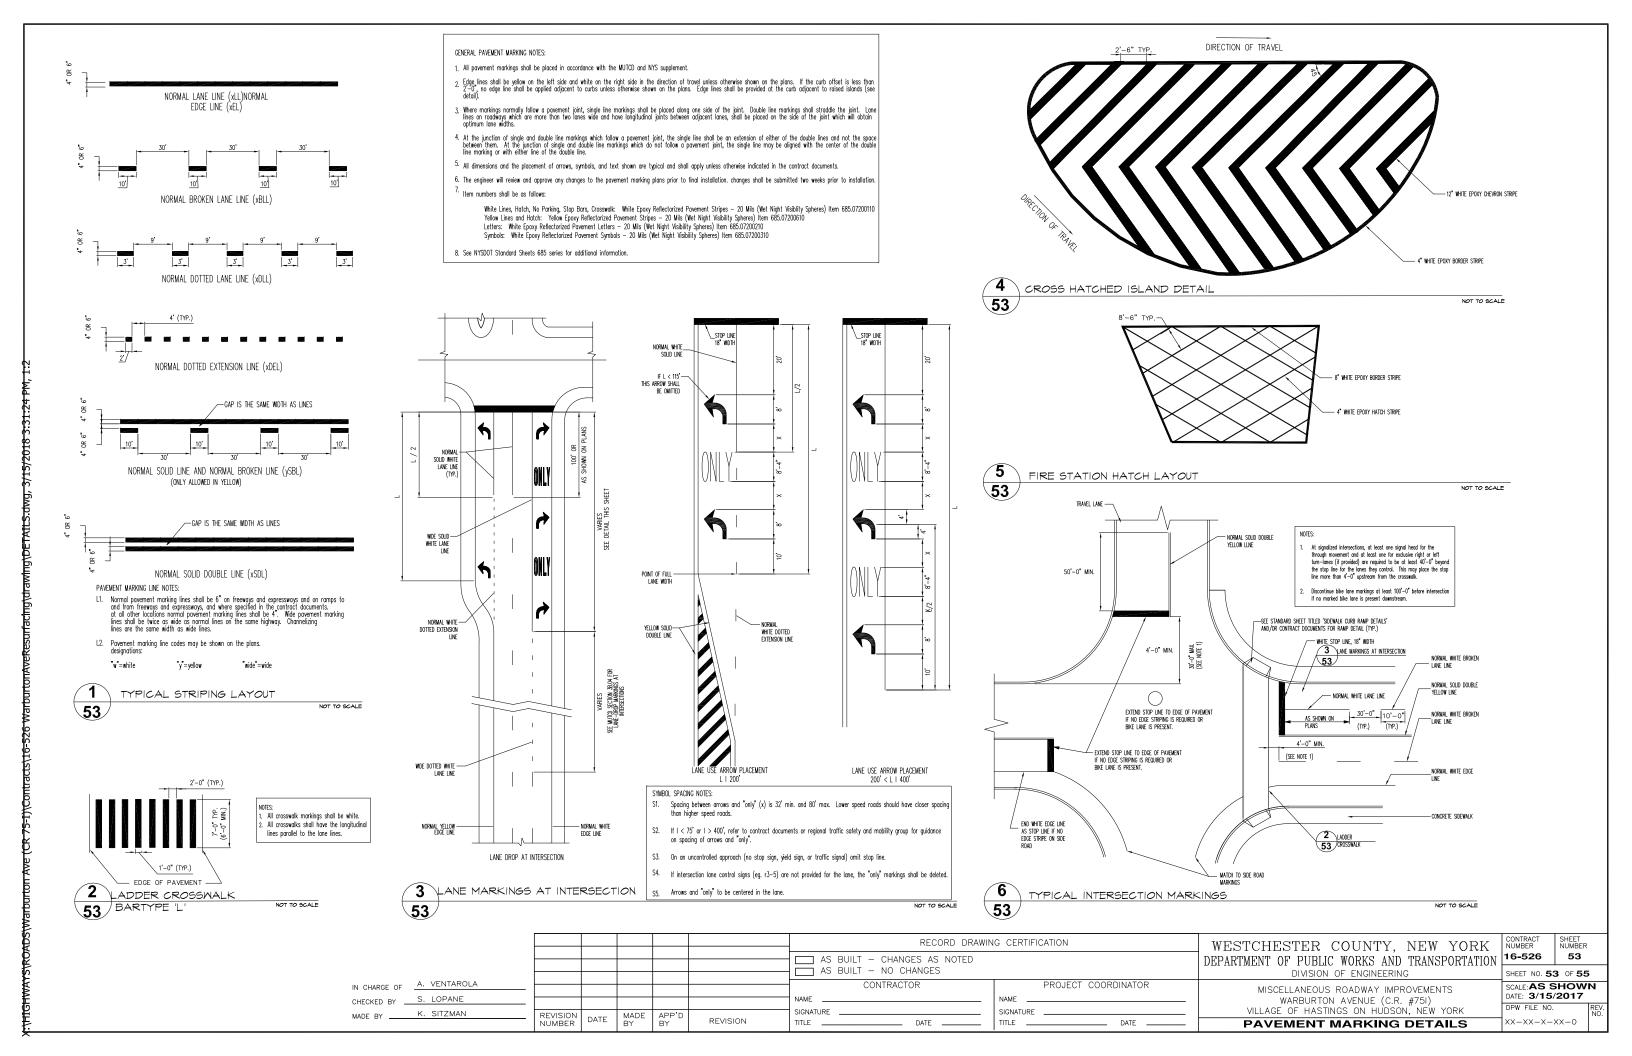


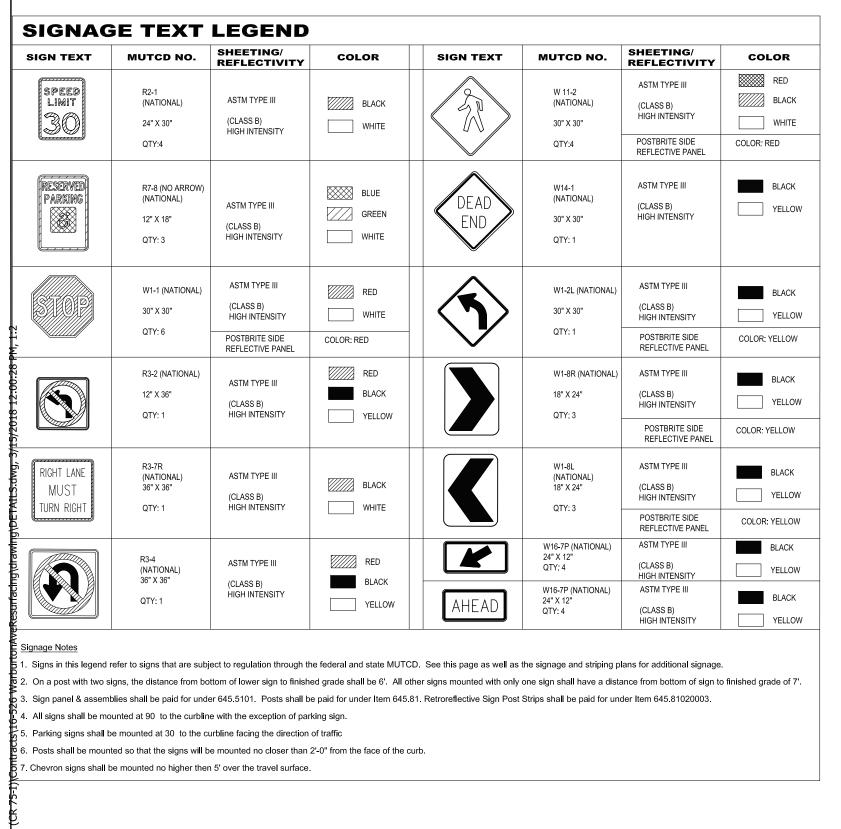

IN CHARGE OF
CHECKED BY ____
MADE BY ____

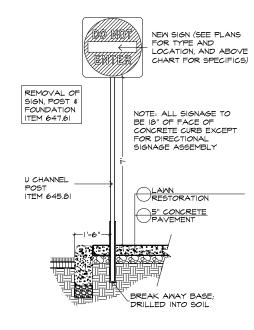




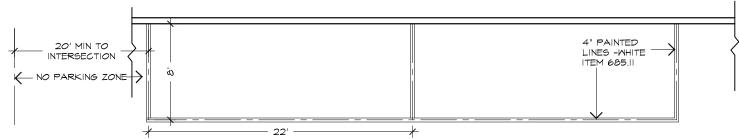

PARALLEL PARKING LAYOUT

1/4" = 1'-0"

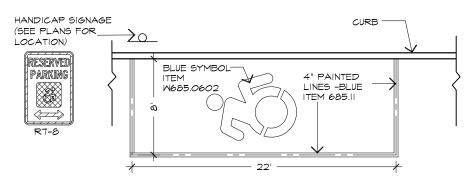

3 HANDICAP PARALLEL PARKING LAYOUT

1/4" = 1'-0"

						RECORD DRAWII	NG CERTIFICATION	WESTCHESTER COUNTY, NEW YORK	CONTRACT NUMBER	SHEET NUMBER
						AS BUILT — CHANGES AS NOTED AS BUILT — NO CHANGES		DEPARTMENT OF PUBLIC WORKS AND TRANSPORTATION DIVISION OF ENGINEERING	16-526 SHEET NO. 54	54 1 OF 55
S. LOPANE						CONTRACTOR NAME	PROJECT COORDINATOR NAME SIGNATURE	MISCELLANEOUS ROADWAY IMPROVEMENTS WARBURTON AVENUE (C.R. #751) VILLAGE OF HASTINGS ON HUDSON, NEW YORK	SCALE: AS SI DATE: 3/14/2 DPW FILE NO.	2018
K. SITZMAN	REVISION NUMBER	DATE	MADE BY	APP'D BY	REVISION	TITLE DATE	TITLE DATE	SIGNAGE & PARKING LAYOUT DETAILS	××-××-×	(X-0 NO

