

- FREE FROM HARD CLODS, STIFF CLAY, HARD PLAN, SODS, ASHES, SLAG, CONCRETE, TAR RESIDUES, TARRED PAPER,

OUTDOOR LIGHTING NOTES:


- 1. ALL LIGHTING WORK SHALL BE DONE IN ACCORDANCE WITH NATIONAL ELECTRIC CODE AND IN ACCORDANCE WITH THE STANDARDS AND REQUIREMENTS OF THE VILLAGE OF HASTINGS. INCLUDING PERMITS AND REQUIRED INSPECTIONS
- 2. ALL FIXTURES SHALL BE FULL CUTOFF; SHALL BE COMPLIANT WITH DARK SKY RECOMMENDATIONS; OR FITTED WITH SHROUDS TO SHIELD THE LIGHT SOURCE.
- 3. THE CONTRACTOR SHALL FURNISH AND INSTALL ALL FIXTURES. OUTLETS AND SWITCHES LISTED AND SHOWN ON PLANS. SIZE AND PROVIDE ALL TRANSFORMERS AND JUNCTION BOXES NECESSARY TO COMPLETE THE WORK, INCLUDING CONDUIT. WIRE, FITTINGS, EXCAVATION. BACKFILL, ETC. REQUIRED TO MAKE A COMPLETE FUNCTIONING SYSTEM. ALL FIXTURES SHALL BE SUPPLIED WITH LAMPS. THE LEAST WATT LAMP SHALL BE SUPPLIED . SUBJECT TO THE OWNERS'S APPROVAL. RE-LAMPING WITH MAXIMUM WATT LAMPS MAY BE REQUIRED.
- 4. THE CONTRACTOR SHALL FURNISH AND INSTALL ALL CONDUITS NECESSARY FOR A COMPLETE INSTALLATION. THIS INCLUDES SIZING GALVANIZED STEEL AND PVC WITH ALL ASSOCIATED FITTINGS, COUPLINGS AND BUSHINGS. ALL LINE VOLTAGE SHALL BE IN CONDUIT WITH A MINIMUM COVER OF 24 INCHES AND A MINIMUM OF 12 INCHES OF COMPACTED SAND AROUND IT AND AS PER CODE. METALLIC CAUTION TAPE SHALL BE PLACED 6 INCHES BELOW FINISHED GRADE.
- 5. ALL WIRING AND TRENCHING TO TREE TRUNKS BENEATH TREE CANOPIES TO BE RADIAL TO TREE TRUNK AND APPROVED BY L.A. PRIOR TO GROUND DISTURBANCE. TRENCHING WITHIN THE TREE CANOPY SHALL BE EXCAVATED WITH AN AIR SPADE TOOL TO MINIMIZE ROOT DAMAGE. CARE IS TO BE TAKEN TO PREVENT EXPOSED TREE ROOTS FROM DRYING.
- 6. FINAL SWITCH LOCATIONS TO BE APPROVED BY OWNER. CONTRACTOR SHALL VERIFY AND COORDINATE NEW SWITCHES WITH EXISTING INTERIOR LIGHTING. DRAWING SHOWS PROPOSED LANDSCAPE LIGHTING AND DOES NOT SHOW EXISTING ARCHITECTURAL LIGHTING
- 7. FINAL FIXTURE PLACEMENT TO BE APPROVED BY THE LANDSCAPE ARCHITECT & OWNER AFTER NIGHTTIME DEMONSTRATION OF INITIAL PLACEMENT.
- 8. ALL PATH LIGHTS TO BE LOCATED 12" BACK FROM EDGE OF PAVING UNLESS OTHERWISE DIRECTED BY THE LANDSCAPE ARCHITECT.
- 9. LOCATIONS OF TRANSFORMERS, JUNCTION BOXES FIXTURES AND OUTLETS ARE A GRAPHIC REPRESENTATION AND MAY NOT SHOW PRECISE LOCATION. FINAL LOCATIONS TO BE APPROVED BY OWNER PRIOR TO INSTALLATION. ACTUAL WIRING ROUTES ARE NOT SHOWN ON THIS PLAN. WIRING ROUTES INDICATED ARE A GRAPHIC REPRESENTATION OF CONNECTIONS AND GROUPINGS OF LIGHTS FOR SWITCHING. L.A. TO APPROVE WIRING ROUTES PRIOR TO GROUND DISTURBANCE. ALL LINE VOLTAGE RUNS IN CONDUIT MINIMUM 18 INCHES DEEP OR AS PER LOCAL CODE..
- 10. STAKE MOUNTED LIGHTS TO BE MOVABLE WITHIN A SIX (6) FOOT RADIUS OF INSTALLED LOCATION.
- 11. TRANSFORMERS FOR LOW VOLTAGE LIGHTING AND JUNCTION BOXES NOT SHOWN. CONTRACTOR TO DETERMINE NUMBER REQUIRED AND COORDINATE THEIR LOCATION WITH THE LANDSCAPE ARCHITECT.
- 12. WIRING SIZES ARE TO BE DETERMINED BY ELECTRICIAN TO INSURE FULLY FUNCTIONAL SYSTEM WITH NO MORE THAN A 5% VOLTAGE DROP FROM EACH TRANSFORMER TO FARTHEST FIXTURE ON LINE FROM THAT TRANSFORMER..
- 13. ALL WIRE CONNECTIONS TO BE THOROUGHLY SEALED WITH SILICONE SEALANT & WILL BE LOCATED WITHIN FIXTURE STEMS, TREE MOUNTS, OR JUNCTION BOXES WHEREVER POSSIBLE. DIRECT BURIAL OF LOW VOLTAGE CONNECTIONS WILL BE MINIMIZED. DIRECT BURIAL CONNECTIONS FOR LINE VOLTAGE WILL NOT BE PERMITTED.
- 14. REVIEW EXISTING CONDITIONS AND PROPOSED PLANTING PLANS. ELECTRICIAN TO BE RESPONSIBLE FOR RESTORING ANY SITE OR UTILITY DAMAGE CAUSED BY HIS INSTALLATION WORK.
- 15. SEE LIGHTING PLAN FOR LIGHT FIXTURE TYPE AND SPECIFICATIONS.

	DATE	2/7/2024	2/16/2024	
	DRAWING LIST	PLANNING BOARD	ARB	BUILDING DEPARTMENT
	CAPE ARCHITECTURAL DRAWINGS FF ARCHITECTS			
LC	Cover Sheet			
L1.0	Site Plan - Overall Landscape	X	Х	
L1.1	Site Plan - Main Entrance Focus	X	X	
L1.1A	Entry Wall Elevation	X	Х	
L1.2	Site Plan - The Graham-Windham Garden	X	X	
L1.3	Site Plan - Admin Entrance Focus	X	X	
L1.4	Site Plan - Northern Recreation Area	X	X	
L1.5	Site Plan - Southern Recreation Area	X	X	
L1.6	Site Plan - Parking Garage Focus	X	Х	
L1.7	Site Plan - Dudley Screening	X	Х	
L1.8	Site Plan - Landscape Details	X	Х	
L1.9	Site Plan - Additional Notes	X	Х	
L2.0	Tree Removal Plan	X	Х	
L2.1	Tree Removal Plan	Х	Х	
L2.2	Tree Removal Plan	Х	Х	
L2.3	Tree Removal Plan	Х	Х	
L2.4	Tree Removal Plan	Х	Х	
L3.0	Site Sections A	Х	Х	
L3.1	Site Sections B	Х	Х	
L3.2	Site Sections C	X	Х	
SK24012	6 Site Sections	Х	Х	
L4.0	Photometrics - Site Lighting	Х	Х	
L5.0	Photometrics - Parking Garage RCP LVL 1	Х	Х	
L5.1	Photometrics - Parking Garage RCP LVL 2	Х	Х	
L5.2	Photometrics - Parking Garage RCP LVL 3	Х	Х	
L5.3	Photometrics - Parking Garage RCP LVL 4	Х	Х	
A1.0	Architectural Renderings - Green Building	Х	Х	
A1.1	Architectural Renderings - Grey Building	Х	Х	
A1.2	Dudley St Articulation Option 1 - Green Metal	Х	Х	
A1.3	Dudley St Articulation Option 1A - Grey Metal	X	Х	
A1.4	Dudley St Articulation Option 2 - Green Metal	Х	Х	
A1.5	Dudley St Articulation Option 2A - Grey Metal	Х	Х	
A1.6	Parking Garage Rendered Sections		Х	
E1.0	Existing Photos - Overall Campus		Х	
E1.0	Existing Photos - Administration Building		X	
E1.2	Existing Photos - Cottage Buildings		X	
			~	
M1.0	Studio Building Material Board		Х	
M1.1	Site Lighting Fixture Images		X	
	Lore Fighting Lixtere images		^	

ABBREVIATIONS:

ABBREVIA	(TION3.		
B.P. B.S. B.W. BL BC BLDG. CL CMU CONC. CONT. DI DIA. DN. EA. EJ EL. ELEV. EQ. EX.JT. EXP.JT. EX.JT. EXP.JT. EX. EX.JT. EX. FL FLR. FLWR FTG. G H.B. JNT.	BOTTOM PIER BOTTOM STEP BOTTOM WALL BASE LINE BOTTOM OF CURB BUILDING CENTER LINE CONCRETE MASONRY UNIT CONCRETE CONTINUOUS DRAIN INLET DIAMETER DOWN EACH EXPANSION JOINT ELEVATION EQUAL EACH WAY EXPANSION JOINT EXPANSION JOINT EXISTING EXISTING FLOW LINE FLOOR FLOWER FOOTING GRATE ELEVATION/RIM ELEV. HOSE BIB JOINT	MANUF. MAX. MFR. MIN. MH NEC. N.I.C N.T.S NO./# OC PL R REQ'D R.O.W. SPEC. SQ. T TC T.P T.S. T.W. SPEC. SQ. T TC T.P T.S. T.W. TBD TYP. UW UG VIF W.L. W/ W/O WT	MAN MAX MAN MAN MAN MAN NECE NOT NOT NOT NOT NOT NOT PROF REQU RIGH SPEC SQU TOP TOP TOP TOP TOP TOP TOP TOP TOP TOP

LOCATION MAP:

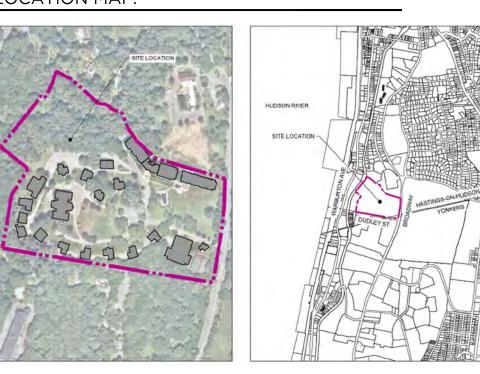

 SEE PROPOSED CIVIL DRAWINGS UNDER SEPARATE COVER - SEE PROPOSED ARCHITECTURAL AND STRUCTURAL DRAWINGS UNDER SEPARATE COVER

REFER TO OTHER DRAWINGS FOR LEGENDS AND KEYS

NUFACTURER (IMUM) NUFACTURER MUM N HOLE ESSARY IN CONTRACT TO SCALE 1BER CENTER PERTY LINE UIRED HT OF WAY CIFICATION IARE AD OF CURB PIER STAIR WALL BE DETERMINED ICAL DER WATER DERGROUND RIFY IN FIELD ATER LINE HOUT TERTABLE



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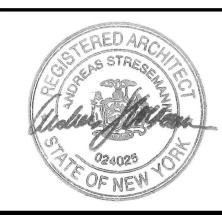
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ELECTRIC OWL STUDIOS

1 S BROADWAY HASTINGS ON HUDSON, NY

PROJECT NAME

JOB NO.: 23003 DRAWN BY: **JS** PROJ. MANAGER: AS SCALE: AS NOTED DATE: 02/07/24 DRAWING TITLE

COVER

DRAWING NO.







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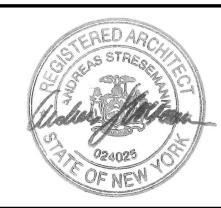
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PROJECT NAME ELECTRIC OWL STUDIOS

1 S BROAD HASTINGS	WAY ON HUDSON, N	١Y	
JOB NO.:	23003		
DRAWN B	Y: JS	PROJ. MA	ANAGER: AS
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SITE PLAN - OVERALL LANDSCAPE

DRAWING NO.



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SCALE 1" = 60' - 0" 0



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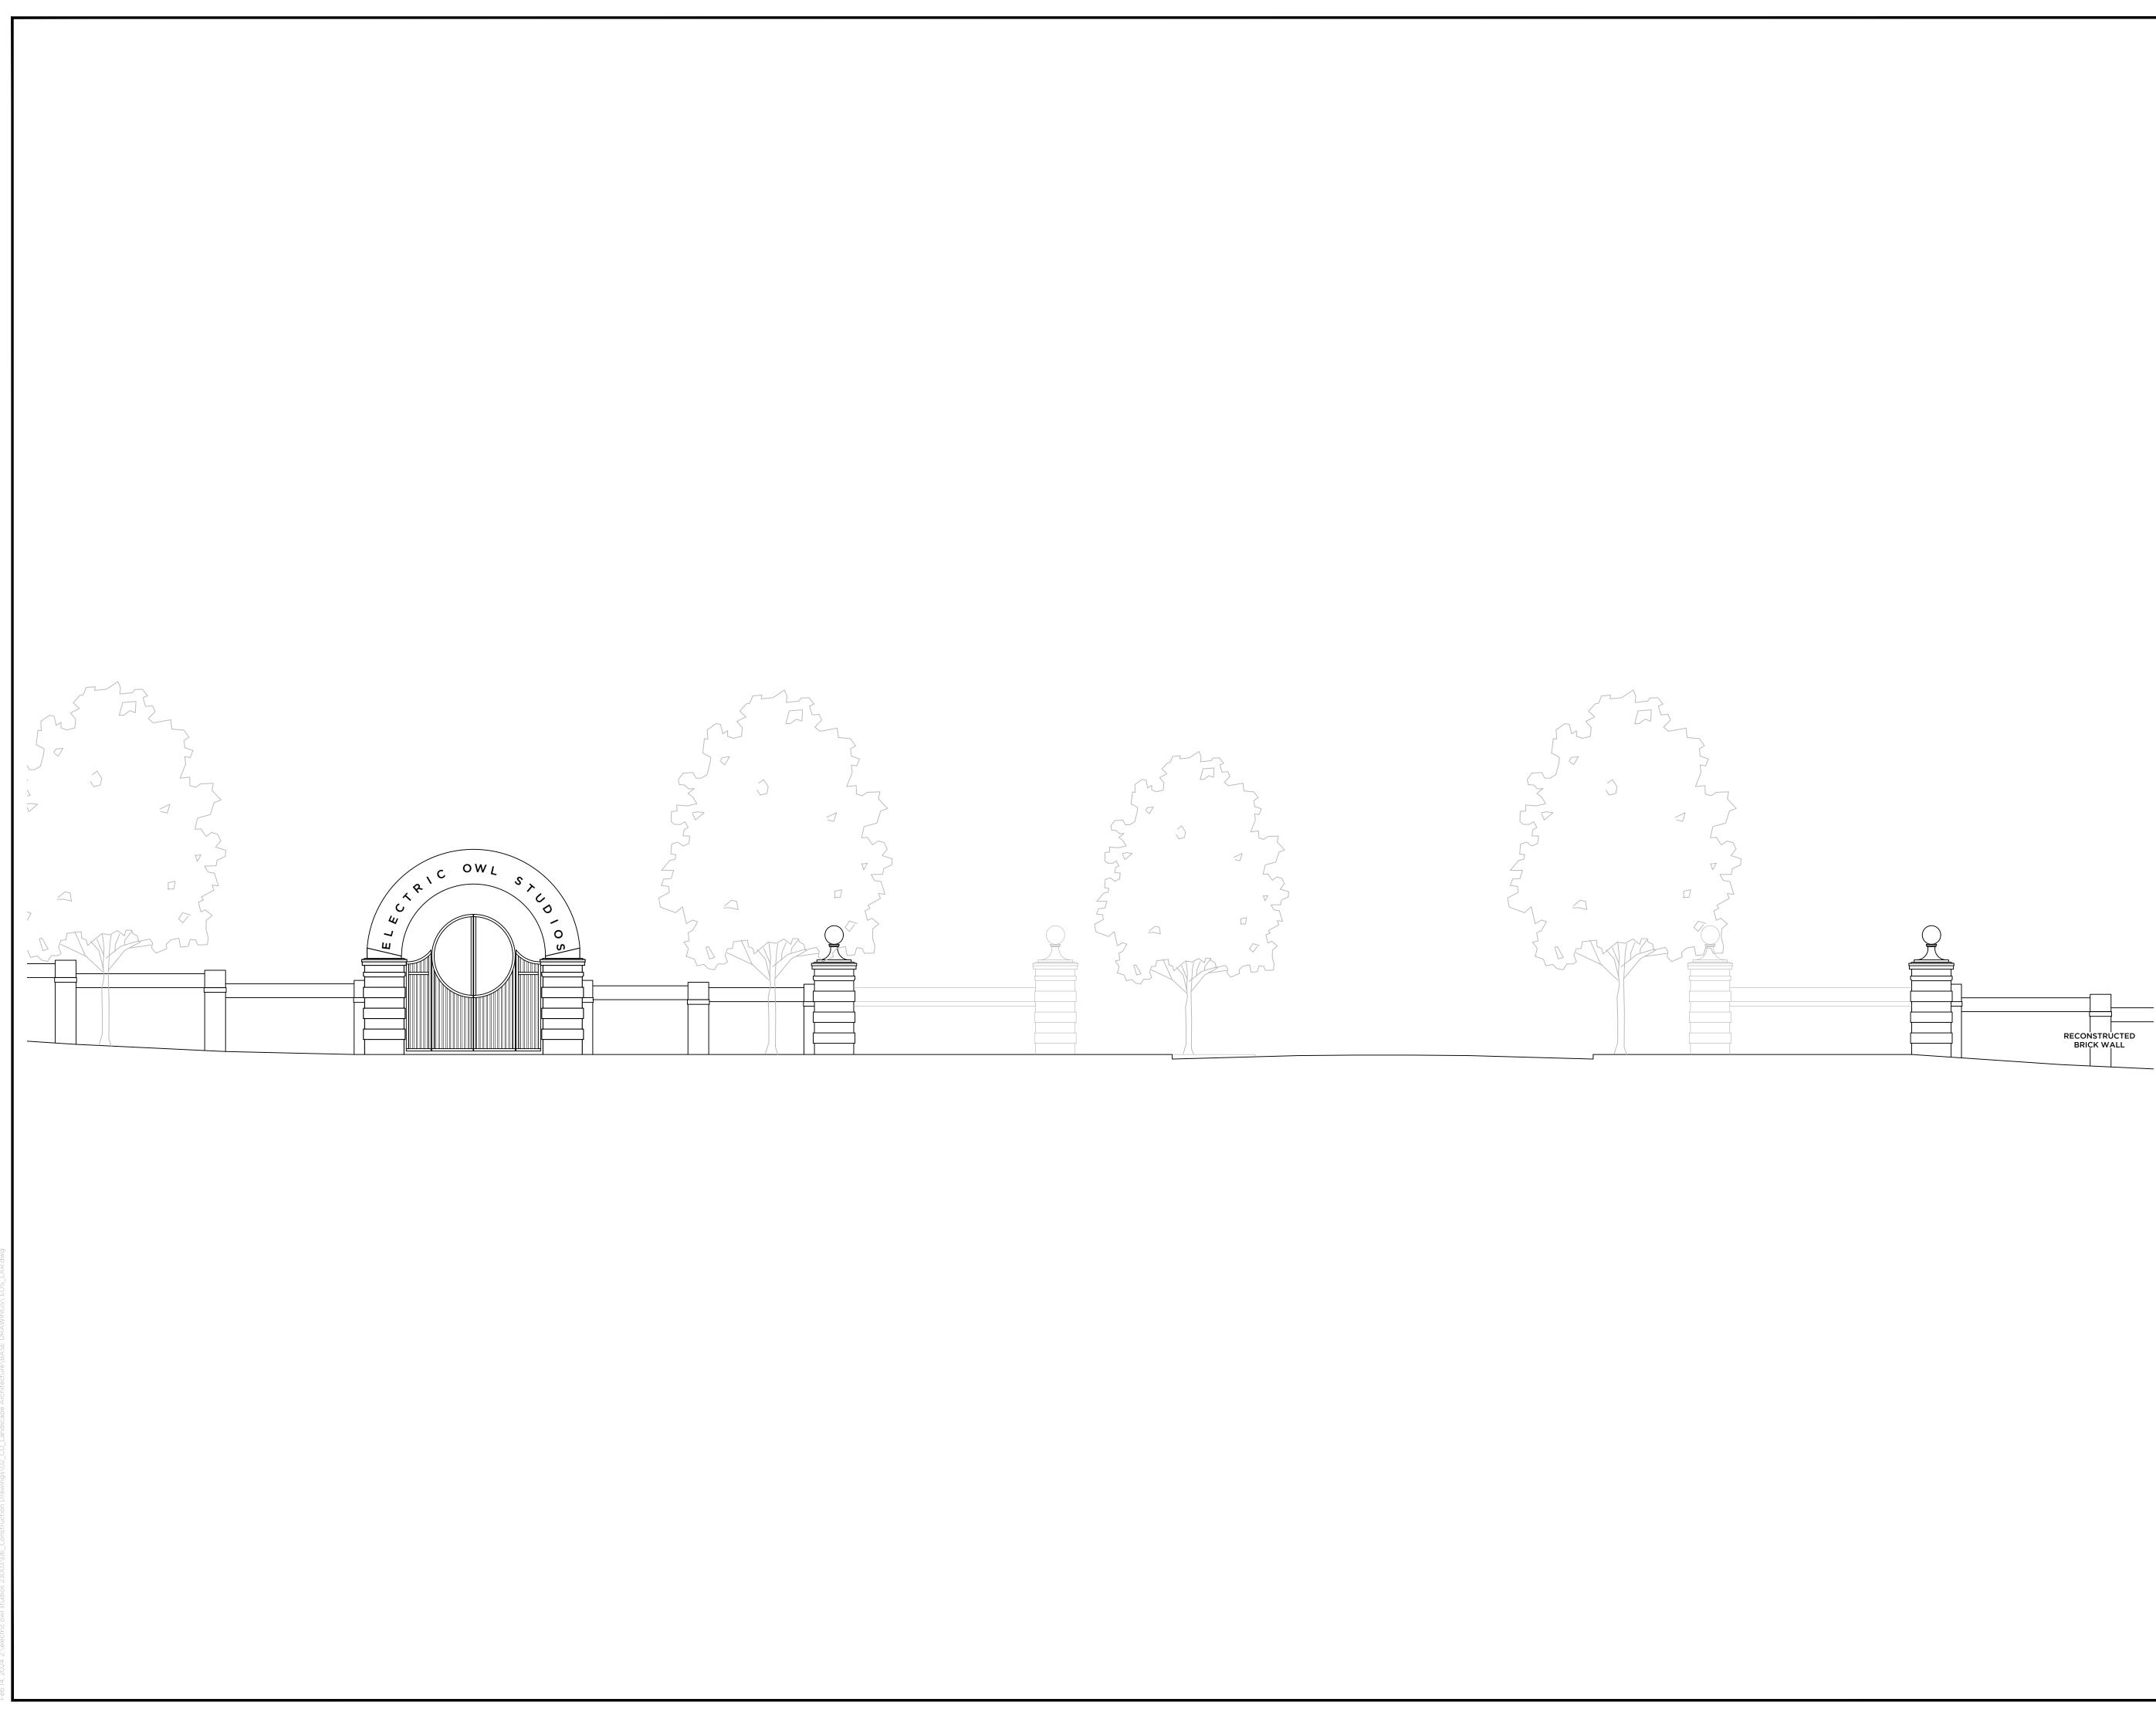
DRAWING TITLE SITE PLAN - MAIN ENTRANCE FOCUS

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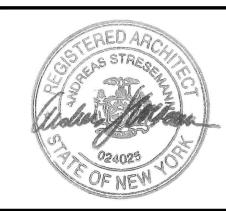
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SITE PLAN - THE GRAHAM-WINDHAM GARDEN


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North

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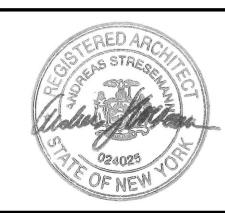
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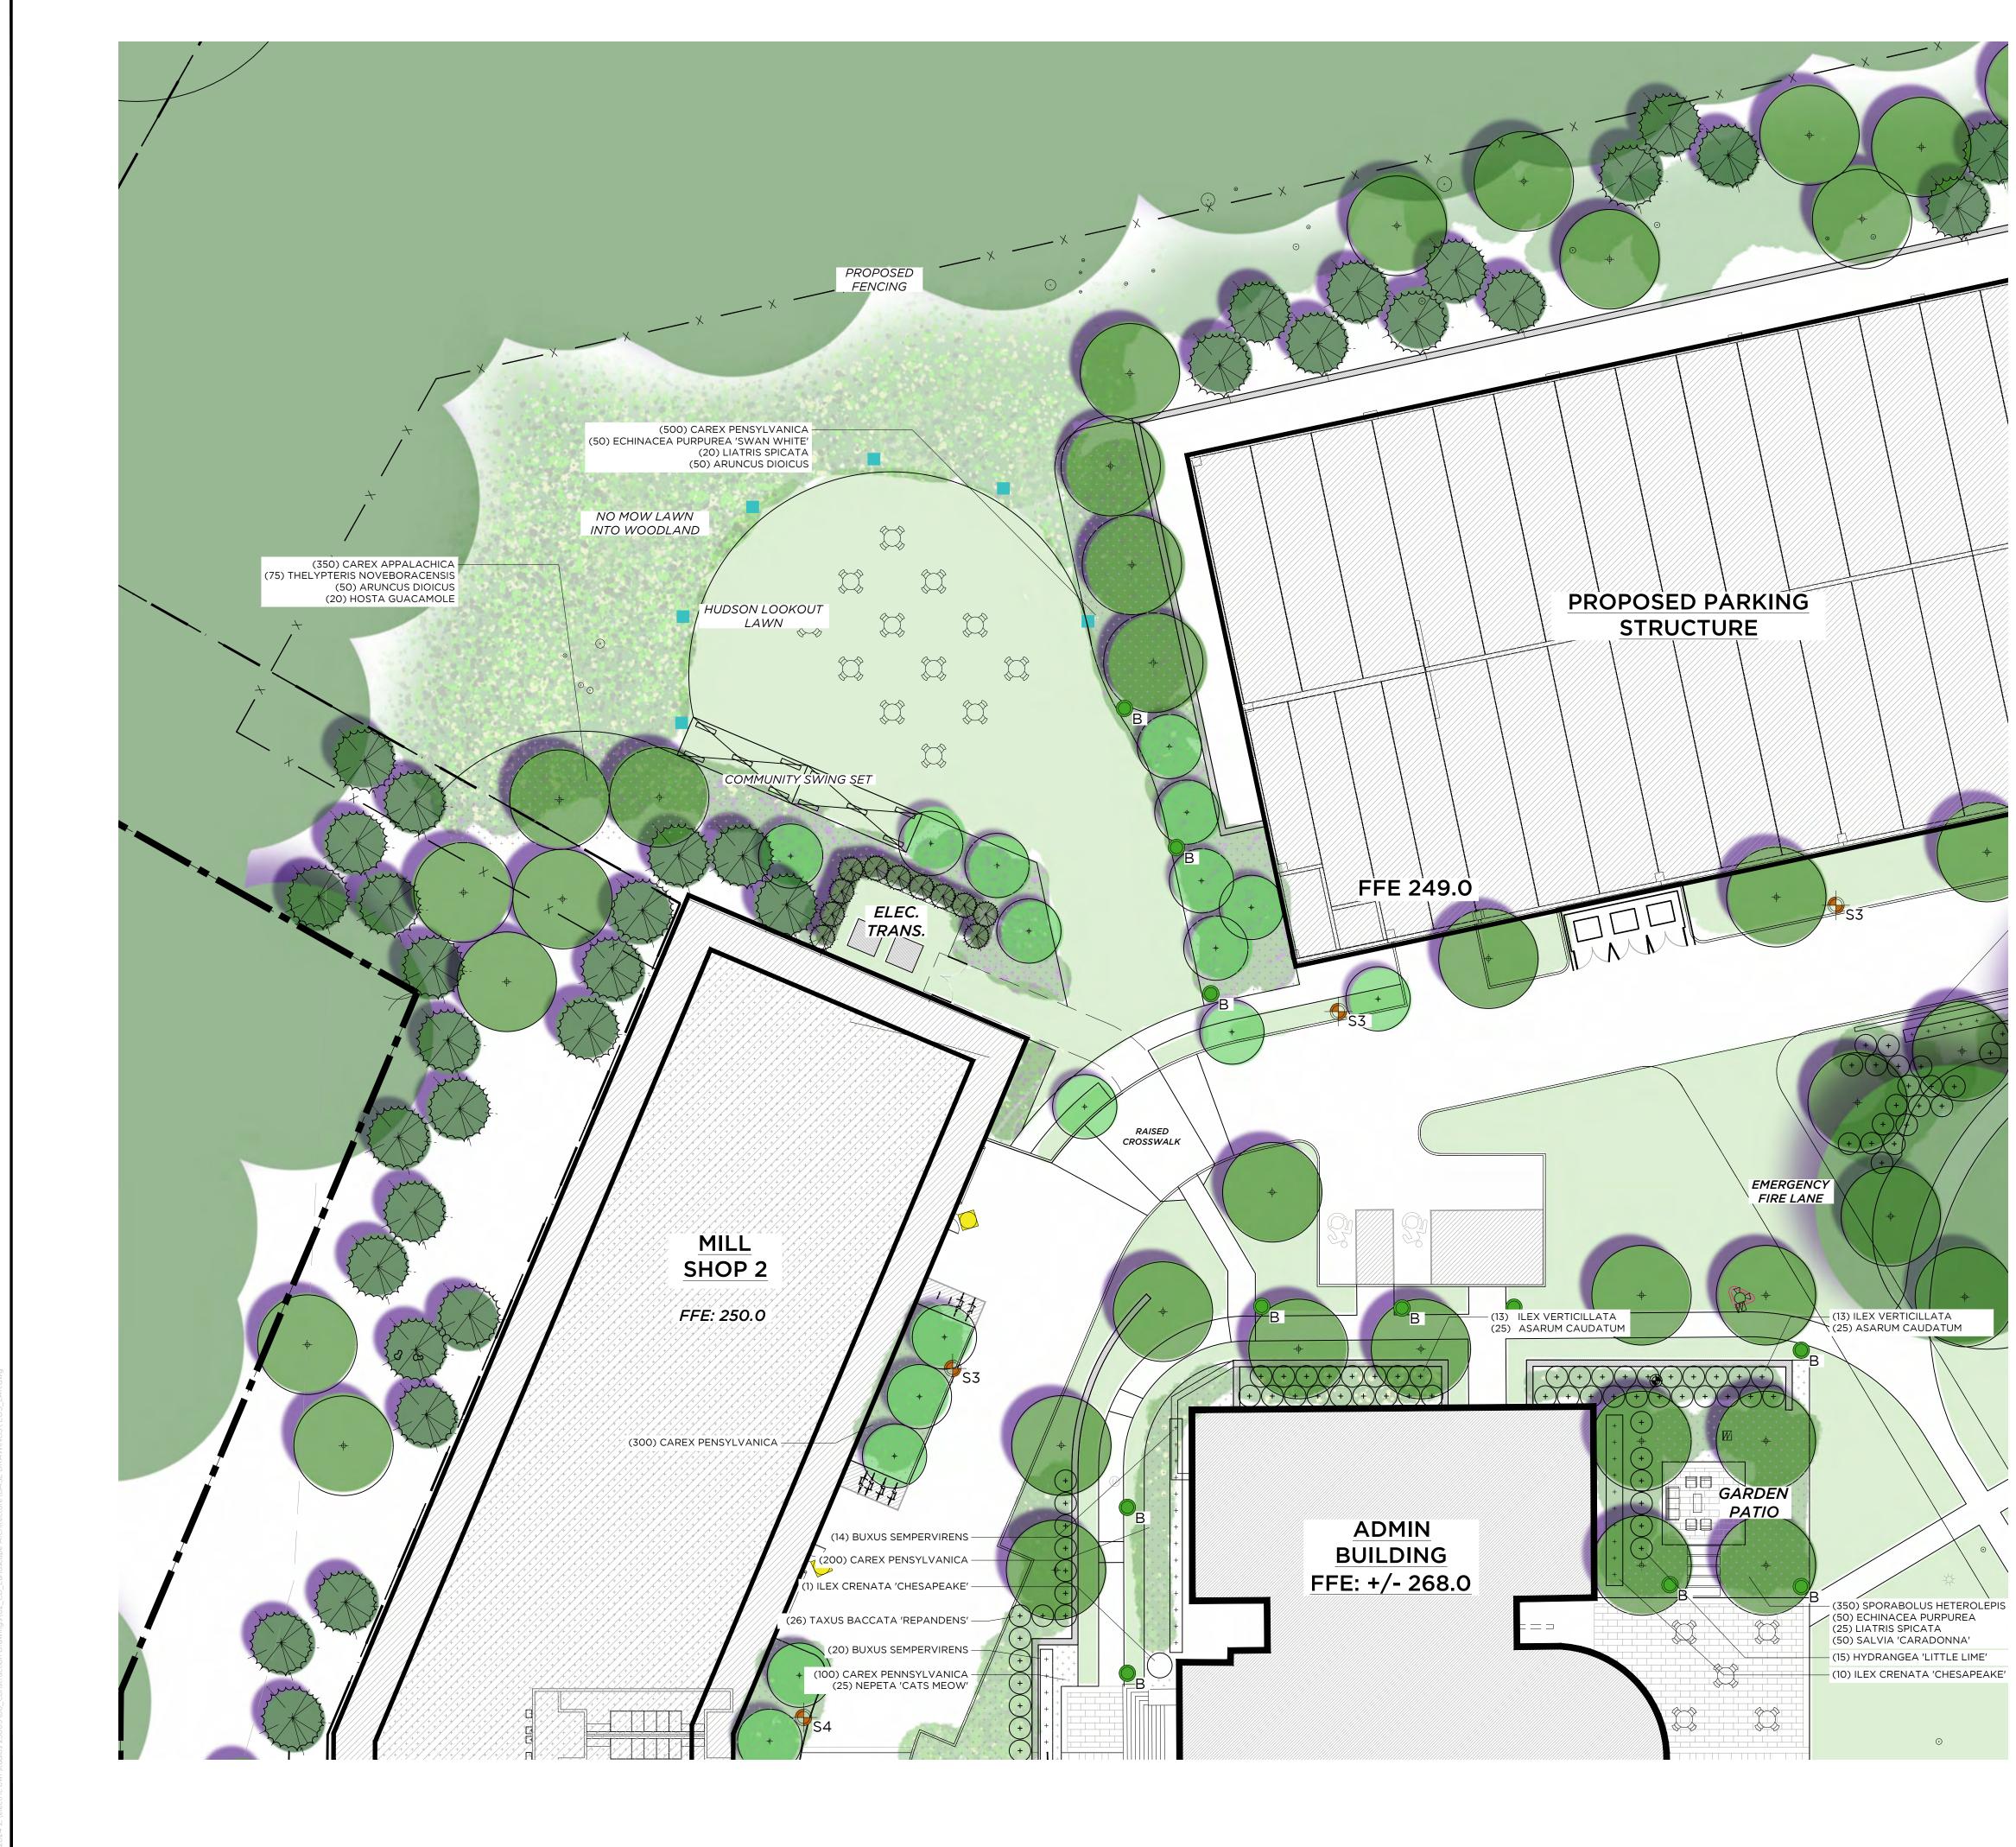
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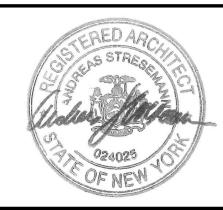
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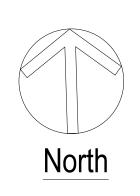
DRAWING TITLE SITE PLAN - NORTHERN

RECREATION AREA

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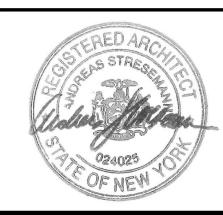
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DATE:	02/07/24	SCALE:	AS NOTED

SITE PLAN - SOUTHERN **RECREATION AREA**
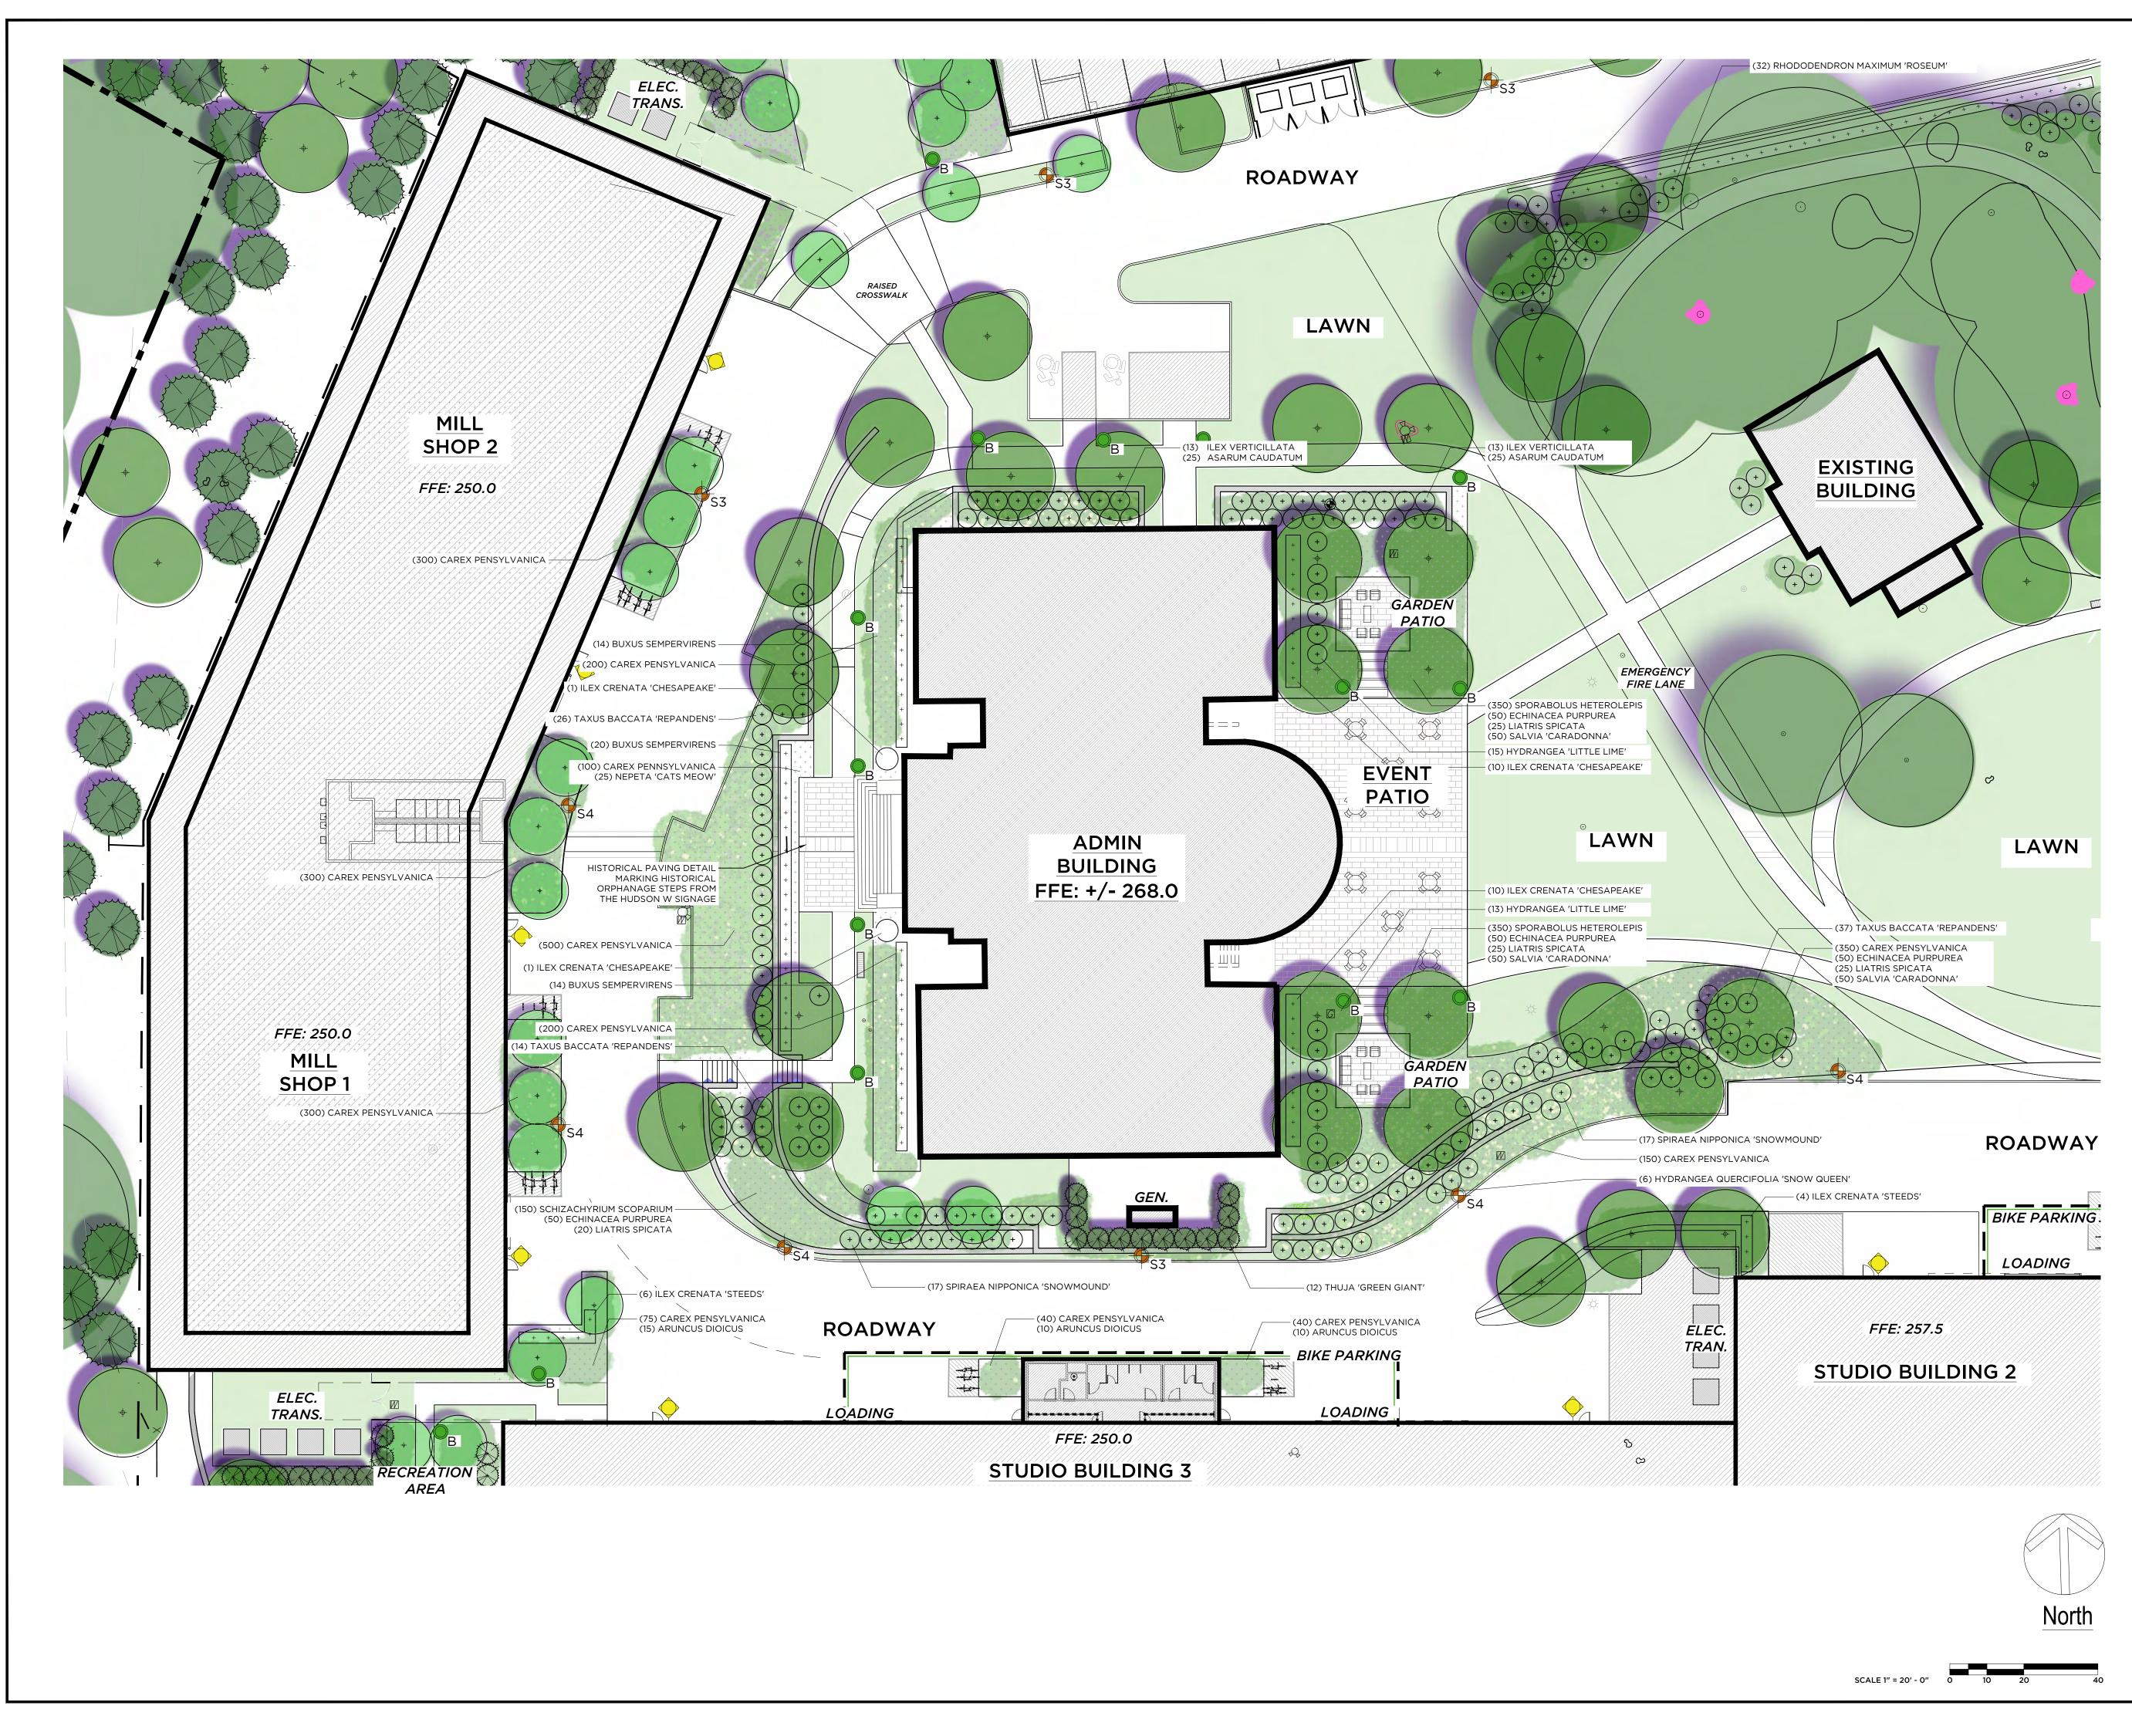
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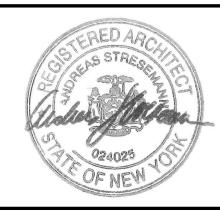
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REVISIONS

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#	DATE	REVISION DESCRIPTION	BY:

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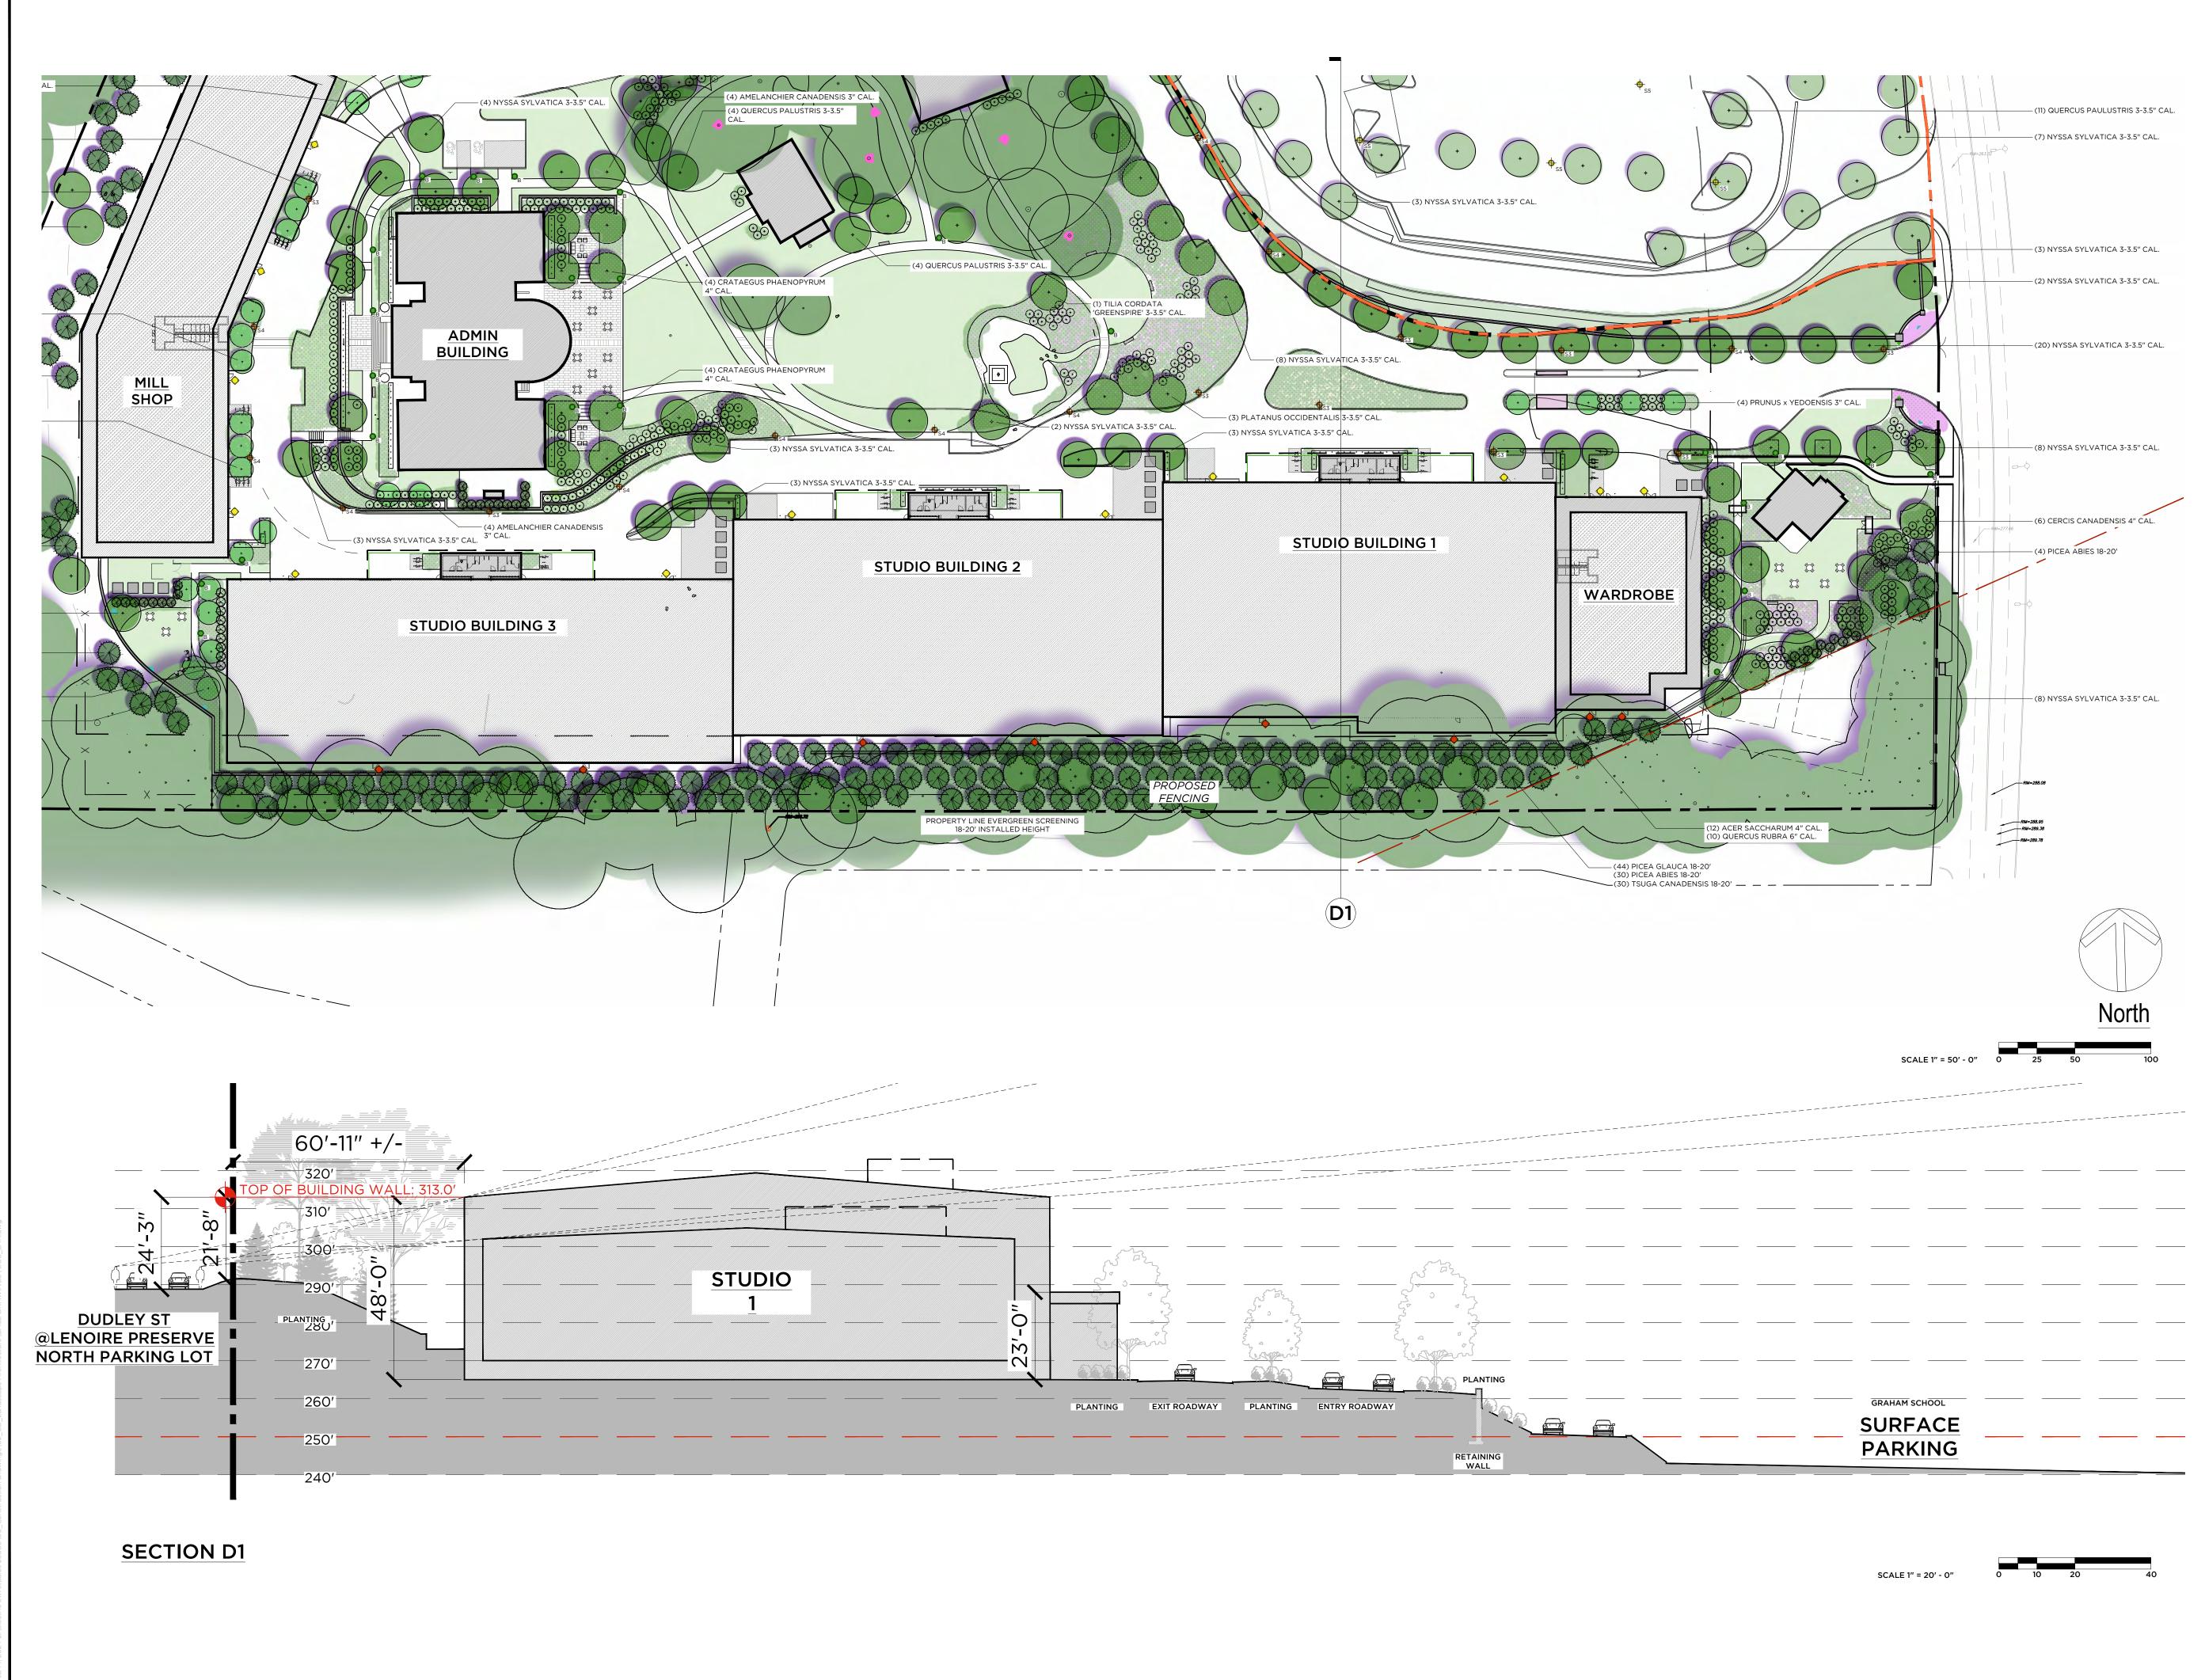


PROJECT NAME ELECTRIC OWL STUDIOS

1 S BROAD HASTINGS	WAY ON HUDSON, N	14	
JOB NO.:	23003		
DRAWN B	/: JS	PROJ. MA	ANAGER: AS
DATE:	02/07/24	SCALE:	AS NOTED
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GRANOFF ARCHITECTS

330 RAILROAD AVENUE GREENWICH, CT 06830 203.625.9460

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CONSULTANTS

Civil: KIMLEY-HORN ENGINEERING AND LANDSCAPE ARCHITECTURE OF NEW YORK, P.C. 60 EAST 42ND STREET, SUITE 1215 NEW YORK, NY 10165 TEL: (332) 213-1082 CONTACT: DANIEL LOFRISCO, P.E. Traffic Engineer: KIMLEY-HORN ENGINEERING AND LANDSCAPE ARCHITECTURE OF NEW YORK, P.C. 1 NORTH LEXINGTON AVENUE SUITE 505 WHITE PLAINS, NY 10601 TEL: (914) 368-9200 CONTACT: JOHN CANNING, P.E. Studio Architect: GRIFFCO DESIGN/BUILD INC. 1701 BARRETT LAKES BLVD., SUITE 285 KENNESAW, GA 30144 TEL: (770) 422-5420 CONTACT: ERIC COBBS, AIA, NCARB Architect: GRANOFF ARCHITECTS 330 RAILROAD AVENUE GREENWICH, CT 06830 TEL: (203) 625-9460 Green Roof: NEW YORK GREEN ROOFS 63 MEADOW ST BROOKLYN, NY, 11206 TEL: (917) 680-6881 REVISIONS # DATE REVISION DESCRIPTION _____

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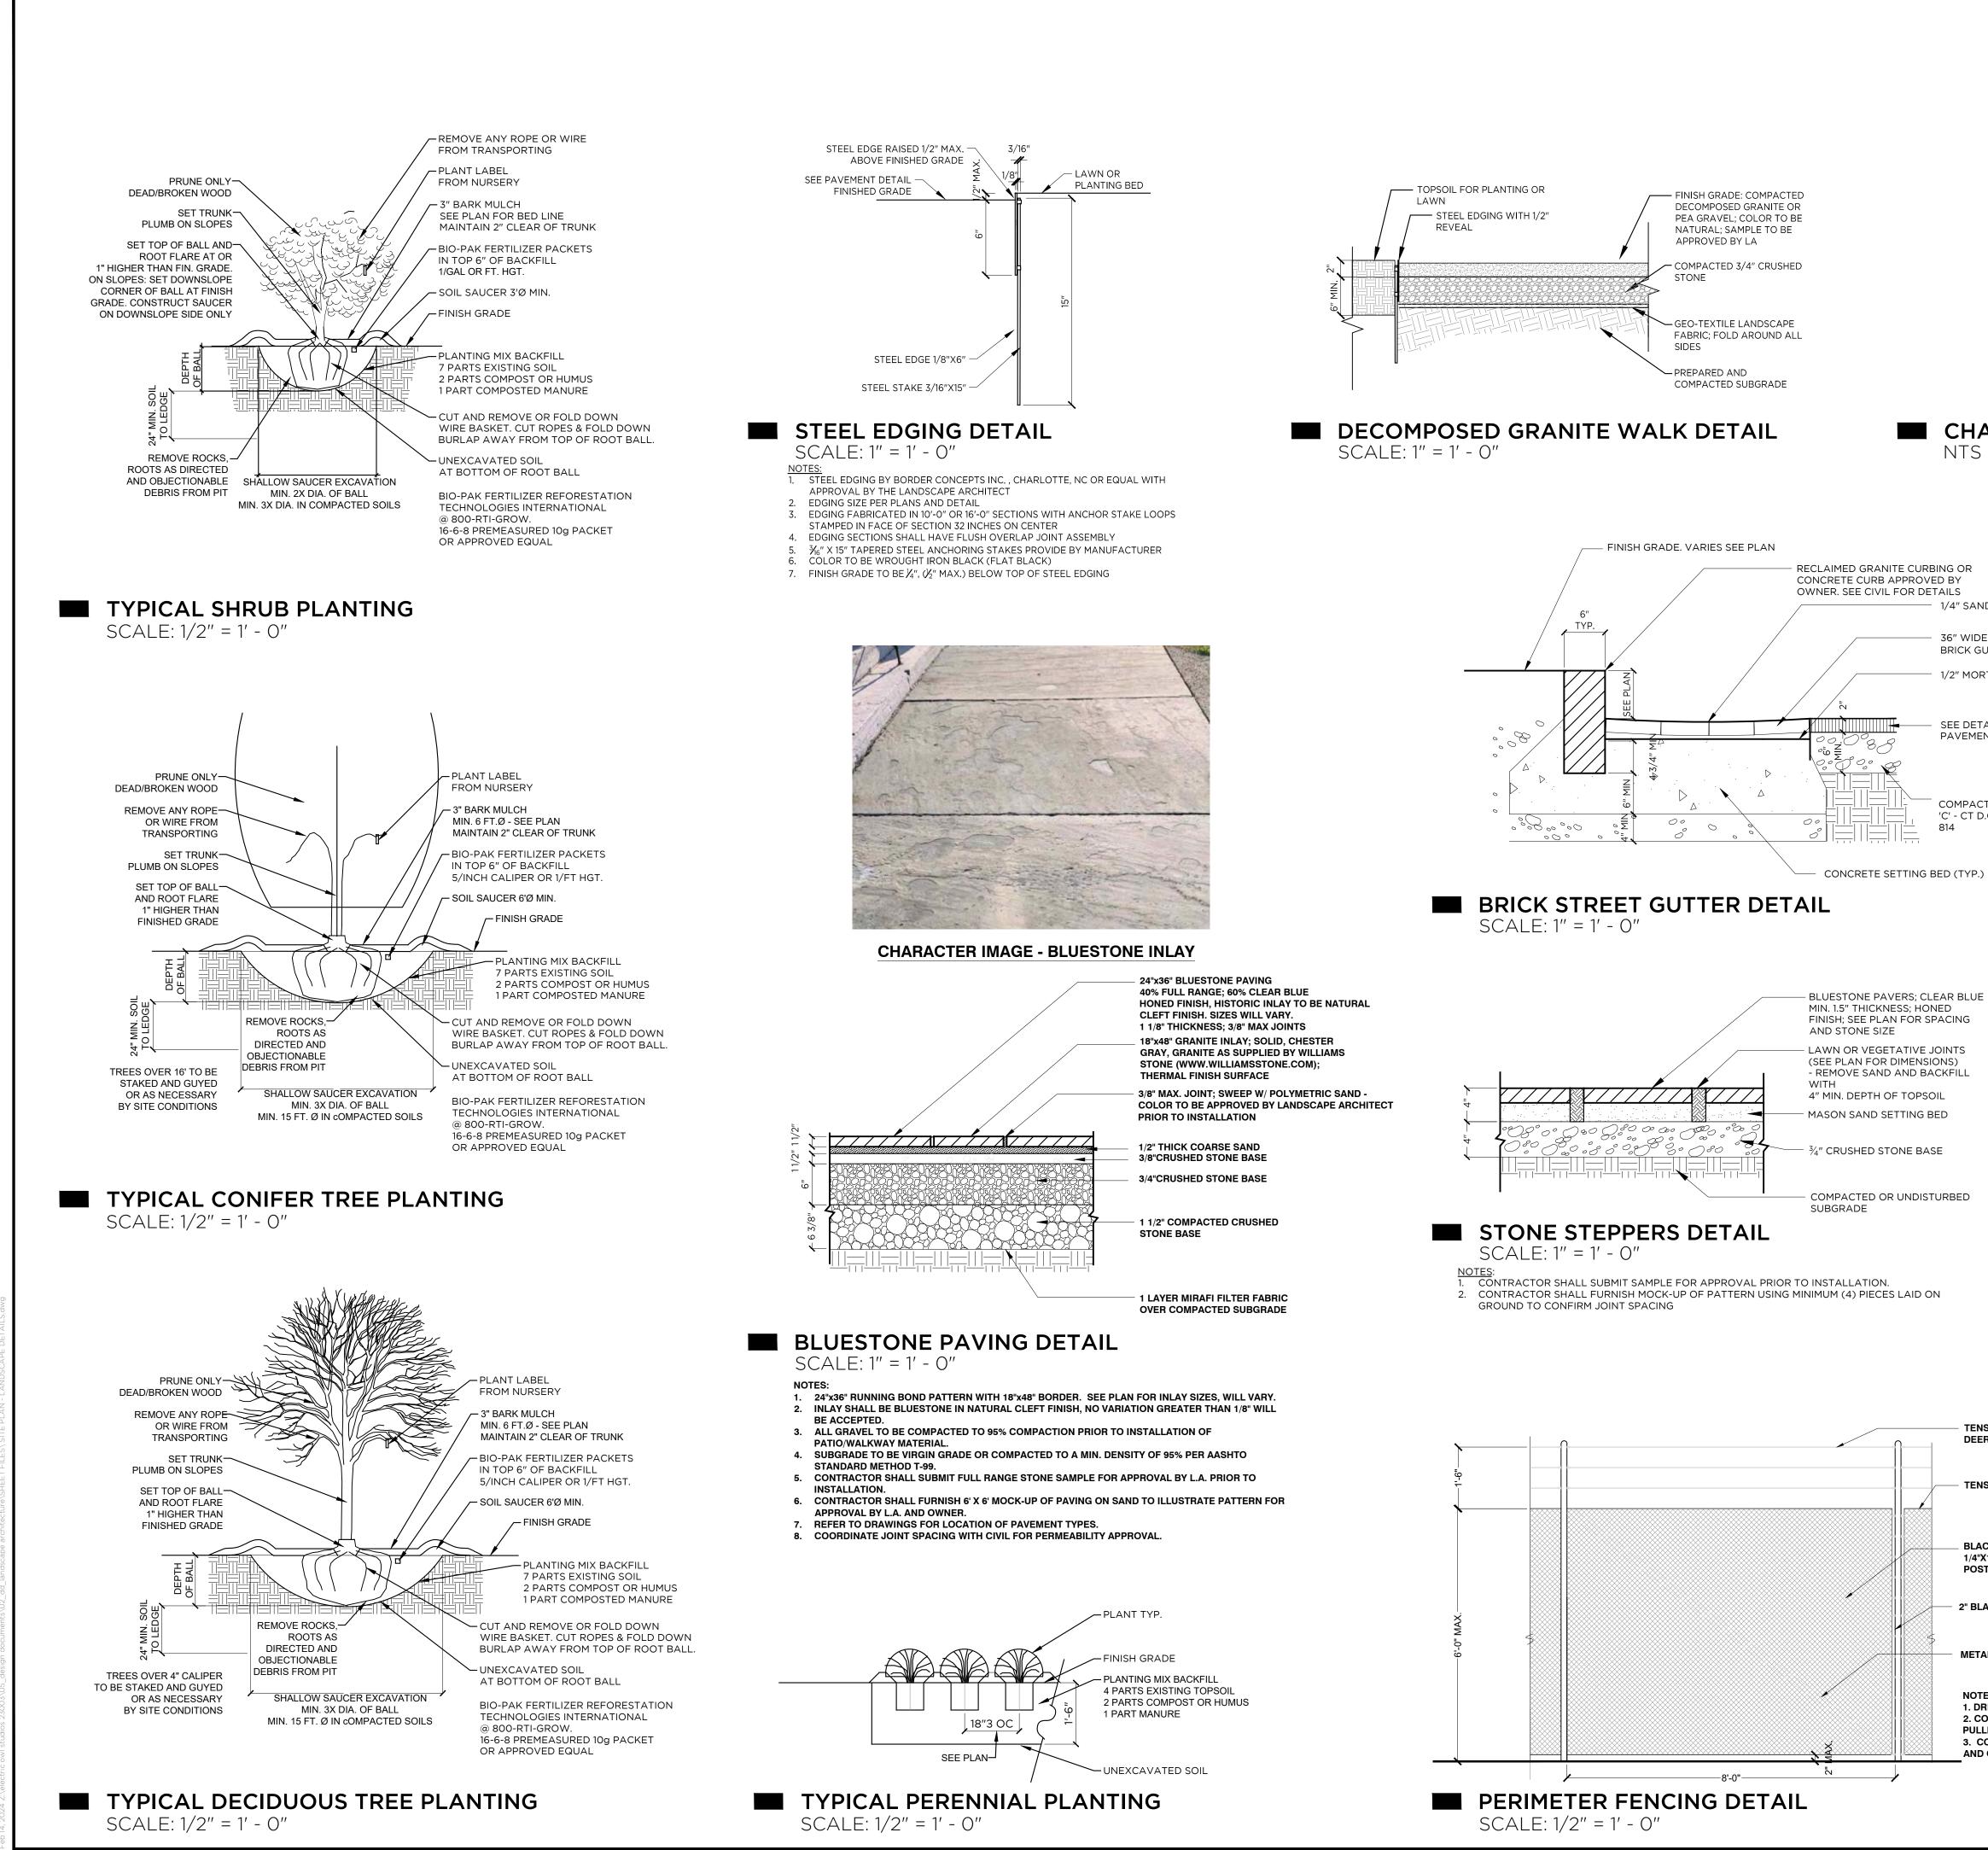
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1 S BROAI HASTINGS	DWAY 5 ON HUDSON, N'	Y
JOB NO.:	23003	
DRAWN E	BY: JS	PROJ. MANAGER: AS
DATE:	02/07/24	SCALE: AS NOTED

SITE PLAN - DUDLEY SCREENING

DRAWING NO.

L1.7





CHARACTER IMAGE - KEY BIKE RACK NTS

1/4" SAND SWEPT JOINTS

36" WIDE RECLAIMED RUNNING BOND BRICK GUTTER INLAY. 1/2" CURVED SWALE 1/2" MORTAR SETTING BED

SEE DETAIL BY CIVIL FOR ASPHALT PAVEMENT

COMPACTED GRAVEL BASE GRADATION 'C' - CT D.O.T. ARTICLE M.02.03 FORM

TENSION WIRE DEER EXTENSION

TENSION WIRE

BLACK VINYL COATED WIRE MESH 1 1/4"X1 1/4" OPENINGS; ATTACH TO POSTS W/ S.S. TIES @ 6" O.C.

2" BLACK TUBULAR STEEL POSTS

METAL CROSS BRACE

NOTE: **1. DRIVE POSTS TO FROST** 2. CONTRACTOR TO ENSURE WIRE MESH IS PULLED TAUGHT

3. CONTRACTOR TO ENSURE ALL FENCING AND GATES ARE POOL CODE COMPLIANT



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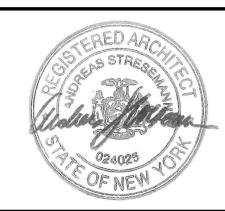
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PROJECT NAME **ELECTRIC OWL STUDIOS**

1 S BROADWAY HASTINGS ON HUDSON, NY JOB NO.: **23003** DRAWN BY: **JS** PROJ. MANAGER: **AS** DATE: 02/07/24 SCALE: AS NOTED DRAWING TITLE

SITE PLAN - LANDSCAPE DETAILS

DRAWING NO.



TREE PROTECTION AND EROSION CONTROL NOTES:

- ALL TREE PROTECTION AND REMOVALS SHALL BE IN ACCORDANCE WITH THE DRAWINGS, DETAILS AND NOTES HEREON. REFER TO TREE PROTECTION DRAWINGS AND DETAILS FOR ADDITIONAL INFORMATION
- PRIOR TO ANY OTHER WORK. THE CONTRACTOR 2. SHALL STAKE OUT THE LIMITS OF "TREE PROTECTION AREAS" WITHIN THE WORK ZONE AS SHOWN ON THE PLANS FOR APPROVAL BY THE LANDSCAPE ARCHITECT. IF NO TREE/LANDSCAPE PROTECTION AREA LIMITS ARE SPECIFICALLY SHOWN ON THE PLANS AND WORK WILL OCCUR IN OR NEAR TREES OR VEGETATED AREAS, THE LANDSCAPE ARCHITECT WILL DIRECT THE CONTRACTOR. THE INTENT OF THE LIMITS ARE TO PROTECT THE ROOT ZONE OF INDIVIDUAL TREES AND GROUPINGS OF TREES (USING THE "DRIP LINE" - THE VERTICAL PROJECTION TO THE GROUND OF THE TREES' CANOPY - AS A GUIDE), LAWNS AND OTHER VALUABLE VEGETATION TO THE MAXIMUM EXTENT FEASIBLE WHILE ALLOWING THE CONTRACTOR SUFFICIENT ROOM TO OPERATE. THEREFORE, THE CONTRACTOR MUST ASSESS THE ADEQUACY OF THE ALLOWED SPACE FOR ALL CONCEIVABLE ACTIVITIES INCLUDING THE PARKING OF PERSONAL VEHICLES. IT IS UNDERSTOOD THAT WORK MAY NEED TO OCCUR IN THE ROOT ZONE OF TREES. IN SUCH CASES, THE CONTRACTOR MAY PROPOSE ADJUSTMENTS TO THE STAKEOUT OF PROTECTION LIMITS TO SUIT FIELD CONDITIONS AND SUCH OPERATIONS. ANY SUCH ADJUSTMENTS SHALL BE SHOWN ON A PLAN AND/OR APPROVED IN THE FIELD BY THE LANDSCAPE ARCHITECT.
- 3. THE CONTRACTOR SHALL NOT STOCKPILE MATERIAL, PARK ANY VEHICLE, OR DRIVE ANY VEHICLE WITHIN THE DRIP LINE OF EXISTING TREES TO REMAIN. IT IS UNDERSTOOD THAT LOCALIZED STAGING/STORAGE AREAS MAY BE NECESSARY IN ADDITION TO ANY MAIN AREAS SHOWN ON PLANS. THE CONTRACTOR SHALL COORDINATE WITH THE LANDSCAPE ARCHITECT FOR ANY AREAS OUTSIDE TREE/LANDSCAPE PROTECTION FOR AREAS APPROPRIATE FOR STORAGE OF MATERIALS, AND EQUIPMENT AS WELL AS PARKING OF CONTRACTOR'S VEHICLES AND ACCESS ROUTES THROUGH THE ACTIVE WORK ZONE. THESE AREAS MUST BE DEFINED BY APPROPRIATE FENCING AND MUST MEET ALL TREE PROTECTION SPECIFICATIONS.
- ONCE PROTECTION FENCING IS IN PLACE, THE CONTRACTOR SHALL NOT ENTER OR DAMAGE OR DIMINISH THE LANDSCAPE OR ANY PORTION THERE OF WITHIN THE DEFINED TREE/LANDSCAPE PROTECTION AREAS. AT ALL TIMES DURING THE COURSE OF THE PROJECT, THE CONTRACTOR SHALL AVOID SOIL COMPACTION, POLLUTION, EROSION AND IMPACTS TO EXISTING VEGETATION UNLESS REMOVAL, SELECTIVE THINNING OR CLEARING ARE SPECIFIED IN THE DRAWINGS.
- WHERE WORK AREAS MUST ENCROACH ON TREE ROOT ZONES, THE CONTRACTOR, IF ORDERED BY LANDSCAPE ARCHITECT OR AS NOTED ON THE PLANS. SHALL FURNISH APPROXIMATELY 12-INCH LAYER OF WOOD CHIPS OR ACCESS MAT WITHIN THE DRIP LINE AREA TO REDUCE SOIL COMPACTION ON UNPAVED AREAS TO MINIMIZE SOIL COMPACTION AND PREVENT CONTAMINATION OF EXISTING SOIL. UNDER NO CIRCUMSTANCES MAY PETROLEUM PRODUCTS, CONCRETE WASH WATER, PAINT, OR OTHER POLLUTANTS BE ALLOWED TO SEEP INTO THE LANDSCAPE.
- 6. THE LANDSCAPE ARCHITECT MUST BE NOTIFIED WHENEVER TRENCHING OCCURS WITHIN THE DRIP LINE FOR ANY TREE. ALL EXCAVATION WITHIN THE DRIP LINE OF A TREE OR NEAR THE DRIP LINE SHALL BE PERFORMED WITH AN AIR SPADE. THERE WILL BE NO SEPARATE PAYMENT FOR ANY REQUIRED AIR SPADE EXCAVATION. SEE ROOT PRUNING AND TRENCHING DETAILS.
- 7. NO TREE PRUNING MAY BE PERFORMED EXCEPT BY (OR UNDER THE SUPERVISION OF) A QUALIFIED TREE-CARE PROFESSIONAL APPROVED BY THE LANDSCAPE ARCHITECT.
- "UNAUTHORIZED" TREE REMOVALS: IF THE CONTRACTOR REMOVES TREES NOT IDENTIFIED ON THE DRAWINGS OR REMOVES TREES NOT APPROVED BY LANDSCAPE ARCHITECT. OR SO SEVERELY DAMAGES TREES AS A RESULT OF CONSTRUCTION ACTIVITY THAT IN THE JUDGMENT OF AN ARBORIST THEY MUST BE REMOVED, THE CONTRACTOR SHALL PROVIDE REPLACEMENT TREES AT HIS/HER OWN EXPENSE SUCH THAT FOR EACH TREE REMOVED EQUALS ONE SIX INCH CALIPER TREE AS APPROVED

BY THE LANDSCAPE ARCHITECT. THE FINAL LOCATION OF REPLACEMENT TREES SHALL BE WITHIN THE PROJECT LIMITS AND WILL BE LOCATED IN THE FIELD BY THE LANDSCAPE ARCHITECT. IF PLANTING WITHIN THE LIMITS IS NOT POSSIBLE THE LANDSCAPE ARCHITECT, OWNER, AND CONTRACTOR SHALL AGREE ON APPROPRIATE MITIGATION. ANY REPLACEMENT TREES PLANTED AS MITIGATION MUST BE WATERED. MAINTAINED AND GUARANTEED PER PLANTING SPECIFICATIONS IN THE DRAWINGS AND AT NO ADDITIONAL COST.

- LANDSCAPE MAINTENANCE DURING CONSTRUCTION: DURING THE COURSE OF THE PROJECT, THE CONTRACTOR SHALL MAINTAIN THE APPEARANCE OF THE PROJECT SITE BY REMOVING LITTER, DEBRIS AND EXCESS MATERIALS, AS A RESULT OF THE CONSTRUCTION OPERATIONS, FROM THE WORK SITE ON A REGULAR BASIS AND SHALL STORE ALL CONSTRUCTION EQUIPMENT AND CONSTRUCTION MATERIAL IN AN ORGANIZED MANNER THROUGHOUT THE CONSTRUCTION PERIOD.
- 10. IN CASE OF A TREE REMOVAL, ALL REMNANTS INCLUDING, BUT NOT LIMITED TO, STUMPS, TRUNKS, LIMBS, BRANCHES, AND FOLIAGE SHALL BE DISPOSED OF AS EXPEDITIOUSLY AS POSSIBLE.
- RESTORATION OF LANDSCAPE: ALL EXCESS MATERIALS AND DEBRIS RESULTING FROM THE CONTRACTOR'S OPERATIONS SHALL BE REMOVED BY THE CONTRACTOR, AS PART OF SITE RESTORATION. ALL SOIL DIMINISHED AND/OR CONTAMINATED WITH EXCESS MATERIAL AND DEBRIS SHALL ALSO BE REMOVED AND REPLACED WITH TOPSOIL ACCEPTABLE TO THE LANDSCAPE ARCHITECT. THE CONTRACTOR, AS DIRECTED BY LANDSCAPE ARCHITECT, SHALL RESTORE A MINIMUM OF 6" OF NEW TOPSOIL ON ALL AREAS WHERE THE TOPSOIL LAYER HAS BEEN DIMINISHED OR LOST DUE TO HIS/HER OPERATIONS. OUTSIDE THE DRIP LINE OF TREES, IF IT IS DETERMINED BY THE LANDSCAPE ARCHITECT THAT THE SOIL HAS BEEN COMPACTED DURING THE COURSE OF THE PROJECT. IT WILL BE UNCOMPACTED AND LOOSENED (BY USE OF AN AIR SPADE WITHIN AND NEAR THE DRIPLINES OF TREES) TO THE DEPTH OF 12 INCHES PRIOR TO FINAL GRADING OR PLANTING. UNDER NO CIRCUMSTANCES MAY HEAVY EQUIPMENT (I.E. PAYLOADERS) BE USED TO ACCOMPLISH SITE RESTORATION WITHIN THE DRIP LINE OF TREES. IN ALL ROOT-SENSITIVE AREAS. WORK MUST BE DONE USING ONLY AN AIR SPADE.
- 12. ALL UTILITY CONFLICTS WITH PROPOSED TREES SHALL BE IMMEDIATELY BROUGHT TO THE ATTENTION OF THE LANDSCAPE ARCHITECT.
- 13. CONTRACTOR SHALL REFER TO TO THE DEMOLITION/EROSION CONTROL PLAN FOR MORE INFORMATION

PLANTING NOTES:

AND SHEET L2.0 FOR EXISTING MATERIAL AND PLANTS TO BE STOCKPILED AND MAINTAINED FOR TRANSPLANTING. TOPSOIL FOR PLANTING: A. MATERIAL: TOPSOIL SHALL CONSIST OF NATURAL LOAM, FREE FROM SUBSOIL, OBTAINED FROM AN AREA THAT HAS NEVER BEEN PREVIOUSLY STRIPPED MANUFACTURED OR AMENDED SOILS ARE NOT ACCEPTABLE UNLESS OTHERWISE DIRECTED BY LANDSCAPE ARCHITECT. B. QUALITY: TOPSOIL SHALL BE OF UNIFORM QUALITY, FREE FROM HARD CLODS, STIFF CLAY, HARD PLAN, SODS, PARTIALLY DISINTEGRATED STONE, LIME, CEMENT, ASHES, SLAG, CONCRETE, TAR RESIDUES, TARRED PAPER, BOARDS, CHIPS, STICKS, OR ANY OTHER UNDESIRABLE MATERIAL C. NO TOPSOIL SHALL BE DELIVERED, MANIPULATED OR HANDLED IN A FROZEN OR MUDDY CONDITION. THE LANDSCAPE ARCHITECT RESERVES THE RIGHT TO REJECT, ON OR AFTER DELIVERY, OF ANY MATERIAL THAT DOES NOT, IN THEIR OPINION, MEET THESE SPECIFICATIONS .: 3. IRRIGATION SYSTEM (SEPARATE PRICE): A. THE EXISTING IRRIGATION SYSTEM SHALL BE MODIFIED AND SHALL BE A FULLY OPERATIONAL AND COMPLETE IN-GROUND IRRIGATION SYSTEM, INCLUDING BUT NOT LIMITED TO THE FOLLOWING: - ALL EXCAVATION, TRENCHING, PUMPS, FILTERS, VALVES, BOXES, TIMERS, CONNECTIONS, WIRING, PIPING, DRIP TUBE, HEADS AND EMITTERS AS NECESSARY. **B. CONTRACTOR IS REQUIRED TO COORDINATE WORK** WITH IRRIGATION CONTRACTOR. CONTRACTOR SHALL PROVIDE SLEEVES AS INDICATED ON THE DRAWINGS OR AS REQUIRED BY THE IRRIGATION INSTALLER 4. NEW SEED (INCLUDING FINE GRADING) WHERE REQUIRED A. INSTALLATION OF SEED SHALL INCLUDE FINE GRADING, PREPARATION OF SOIL BED, INCORPORATION OF FERTILIZER AND LIME, PROTECTION (BEFORE AND AFTER INSTALLATION) AND MAINTENANCE UNTIL FINAL ACCEPTANCE. B. SEED MIX SHALL BE LOW MAINTENANCE, NATIVE,

SEE DEMOLITION, EROSION CONTROL DRAWINGS BY CIVIL

AND DROUGHT TOLERANT MIX WITH ANNUAL RYE. SEED MIX APPROPRIATE FOR TIME OF PLANTING. SEED MIX TO BE APPROVED BY THE LANDSCAPE ARCHITECT. SEEDING RATE SHALL BE AS RECOMMENDED BY THE MANUFACTURER. C. FERTILIZER FOR LAWNS: FERTILIZE LAWN AREAS

EVENLY USING ONLY ECOLOGICALLY SENSITIVE, ORGANIC PRODUCTS. D. LANDSCAPE MAINTENANCE SHALL PROVIDE MAINTENANCE MATERIALS AND PROTOCOLS FOR REVIEW BY LANDSCAPE ARCHITECT.

E. ACCEPTANCE (OF SEED): THE LANDSCAPE ARCHITECT SHALL REJECT ANY AREAS OF SEED WHICH IN THEIR OPINION HAS NOT PROPERLY GERMINATED TO FORM AN EVEN AND VIGOROUS GROWING BED REJECTED SEED BEDS SHALL BE PREPARED AND RE-SEEDED AT NO COST TO THE OWNER. SEED LAWNS SHALL BE READY FOR ACCEPTANCE AFTER A MINIMUM OF A 60 DAY ACTIVE GROWING PERIOD, UNTIL A UNIFORM STAND OF $2\frac{1}{2}$ INCHES IS OBTAINED, WITH A MINIMUM OF 95% COVERAGE. UNACCEPTED SEED LAWNS SHALL BE RE-SEEDED AS SPECIFIED.

MAINTENANCE OF SEED:

- THE CONTRACTOR SHALL PROPERLY WATER AS OFTEN AS REQUIRED TO MAINTAIN OPTIMUM GROWING CONDITIONS UNTIL FINAL ACCEPTANCE. THE CONTRACTOR SHALL MAINTAIN LAWN AT ONE AND A HALF TO THREE INCHES (1-1/2 TO 3") IN HEIGHT, FOR TWO MOWINGS OR UNTIL ACCEPTANCE. CONTRACTOR SHALL MONITOR IRRIGATION SYSTEM TO ENSURE NEW SOD AND SEED LAWNS RECEIVE PROPER AMOUNTS OF WATER.

- MAINTAIN ALL LAWNS THROUGHOUT AND IMMEDIATELY FOLLOWING PLANTING OPERATIONS UNTIL PROJECT IS CERTIFIED SUBSTANTIALLY COMPLETE.

- MAINTAIN SURFACES AND SUPPLY ADDITIONAL TOPSOIL WHERE NECESSARY, INCLUDING AREAS AFFECTED BY EROSION.
- REPLANT DAMAGED LAWN AREAS SHOWING GROWTH FAILURE, DETERIORATION, BARE OR THIN SPOTS AND ERODED AREAS.

PLANT SCHEDULE

REES cer saccharum melanchier canadensis etula utilis 'Jaquemontii' ercis canadensis rataegus phaenopyrum yssa sylvatica cea abies suga canadensis cea glauca fatanus occidentalis runus x yedoensis uercus palustris uercus palustris uercus rubra huja x 'Green Giant' lia cordata 'Greenspire'	Sugar Maple Serviceberry Jaquemontii Birch Eastern Redbud Hawthorn Tupelo Norway Spruce Hemlock White Spruce American Sycamore Yoshino Cherry Pin Oak Red Oak Arborvitae Little Leaf Linden	4" cal. 3" cal. 3" cal. 4" cal. 4" cal. 3-3.5" cal. 18-20' (4.5" cal.) 18-20' (4.5" cal.) 18-20' (4.5" cal.) 3-3.5" cal. 3" cal. 3" cal. 6" cal. 10-12' (3" cal.) 3-3.5" cal.	Full canopy Full canopy Full canopy Full canopy Full canopy Full canopy Full to base Full to base Full to base Full to base Full canopy Full canopy Full canopy Full canopy	x x x x x x x x
cer saccharum melanchier canadensis etula utilis 'Jaquemontii' ercis canadensis rataegus phaenopyrum yssa sylvatica cea abies suga canadensis cea glauca fatanus occidentalis runus x yedoensis uercus palustris uercus palustris uercus rubra huja x 'Green Giant' lia cordata 'Greenspire' HRUBS	Serviceberry Jaquemontii Birch Eastern Redbud Hawthorn Tupelo Norway Spruce Hemlock White Spruce American Sycamore Yoshino Cherry Pin Oak Red Oak Arborvitae	3" cal. 3" cal. 4" cal. 4" cal. 3-3.5" cal. 18-20' (4.5" cal.) 18-20' (4.5" cal.) 18-20' (4.5" cal.) 3-3.5" cal. 3" cal. 3-3.5" cal. 6" cal. 10-12' (3" cal.)	Full canopy Full canopy Full canopy Full canopy Full canopy Full to base Full to base Full to base Full canopy Full canopy Full canopy	× × × × ×
etula utilis 'Jaquemontii' ercis canadensis rataegus phaenopyrum yssa sylvatica icea abies suga canadensis icea glauca iatanus occidentalis runus x yedoensis uercus palustris uercus rubra huja x 'Green Giant' lia cordata 'Greenspire' HRUBS uddleia davidii 'Nanho Blue'	Serviceberry Jaquemontii Birch Eastern Redbud Hawthorn Tupelo Norway Spruce Hemlock White Spruce American Sycamore Yoshino Cherry Pin Oak Red Oak Arborvitae	3" cal. 4" cal. 4" cal. 3-3.5" cal. 18-20' (4.5" cal.) 18-20' (4.5" cal.) 18-20' (4.5" cal.) 3-3.5" cal. 3" cal. 3-3.5" cal. 6" cal. 10-12' (3" cal.)	Full canopy Full canopy Full canopy Full canopy Full to base Full to base Full to base Full canopy Full canopy Full canopy	× × × ×
ercis canadensis rataegus phaenopyrum yssa sylvatica cea abies suga canadensis cea glauca atanus occidentalis runus x yedoensis uercus palustris uercus rubra huja x 'Green Giant' lia cordata 'Greenspire' HRUBS uddleia davidii 'Nanho Blue'	Eastern Redbud Hawthorn Tupelo Norway Spruce Hemlock White Spruce American Sycamore Yoshino Cherry Pin Oak Red Oak Arborvitae	4" cal. 4" cal. 3-3.5" cal. 18-20' (4.5" cal.) 18-20' (4.5" cal.) 18-20' (4.5" cal.) 3-3.5" cal. 3" cal. 3-3.5" cal. 6" cal. 10-12' (3" cal.)	Full canopy Full canopy Full to base Full to base Full to base Full to base Full canopy Full canopy Full canopy	x x x x
ercis canadensis rataegus phaenopyrum yssa sylvatica cea abies suga canadensis cea glauca atanus occidentalis runus x yedoensis uercus palustris uercus rubra huja x 'Green Giant' lia cordata 'Greenspire' HRUBS uddleia davidii 'Nanho Blue'	Hawthorn Tupelo Norway Spruce Hemlock White Spruce American Sycamore Yoshino Cherry Pin Oak Red Oak Arborvitae	4" cal. 3-3.5" cal. 18-20' (4.5" cal.) 18-20' (4.5" cal.) 18-20' (4.5" cal.) 3-3.5" cal. 3" cal. 3-3.5" cal. 6" cal. 10-12' (3" cal.)	Full canopy Full canopy Full to base Full to base Full to base Full canopy Full canopy Full canopy	x x x x
yssa sylvatica icea abies suga canadensis icea glauca iatanus occidentalis runus x yedoensis uercus palustris uercus rubra inuja x 'Green Giant' lia cordata 'Greenspire' HRUBS uddleia davidii 'Nanho Blue'	Tupelo Norway Spruce Hemlock White Spruce American Sycamore Yoshino Cherry Pin Oak Red Oak Arborvitae	3-3.5" cal. 18-20' (4.5" cal.) 18-20' (4.5" cal.) 18-20' (4.5" cal.) 3-3.5" cal. 3" cal. 3-3.5" cal. 6" cal. 10-12' (3" cal.)	Full canopy Full canopy Full to base Full to base Full to base Full canopy Full canopy Full canopy	x x x
yssa sylvatica icea abies suga canadensis icea glauca iatanus occidentalis runus x yedoensis uercus palustris uercus rubra inuja x 'Green Giant' lia cordata 'Greenspire' HRUBS uddleia davidii 'Nanho Blue'	Tupelo Norway Spruce Hemlock White Spruce American Sycamore Yoshino Cherry Pin Oak Red Oak Arborvitae	3-3.5" cal. 18-20' (4.5" cal.) 18-20' (4.5" cal.) 18-20' (4.5" cal.) 3-3.5" cal. 3" cal. 3-3.5" cal. 6" cal. 10-12' (3" cal.)	Full canopy Full to base Full to base Full to base Full canopy Full canopy Full canopy	x x x
cea abies suga canadensis cea glauca atanus occidentalis runus x yedoensis uercus palustris uercus rubra huja x 'Green Giant' lia cordata 'Greenspire' HRUBS uddleia davidii 'Nanho Blue'	Norway Spruce Hemlock White Spruce American Sycamore Yoshino Cherry Pin Oak Red Oak Arborvitae	18-20' (4.5" cal.) 18-20' (4.5" cal.) 18-20' (4.5" cal.) 3-3.5" cal. 3" cal. 3-3.5" cal. 6" cal. 10-12' (3" cal.)	Full to base Full to base Full to base Full canopy Full canopy Full canopy	x x
suga canadensis icea glauca iatanus occidentalis runus x yedoensis uercus palustris uercus rubra inuja x 'Green Giant' lia cordata 'Greenspire' HRUBS uddleia davidii 'Nanho Blue'	Hemlock White Spruce American Sycamore Yoshino Cherry Pin Oak Red Oak Arborvitae	18-20' (4.5" cal.) 18-20' (4.5" cal.) 3-3.5" cal. 3" cal. 3-3.5" cal. 6" cal. 10-12' (3" cal.)	Full to base Full to base Full canopy Full canopy Full canopy	х
icea glauca iatanus occidentalis runus x yedoensis uercus palustris uercus rubra inuja x 'Green Giant' lia cordata 'Greenspire' HRUBS uddleia davidii 'Nanho Blue'	White Spruce American Sycamore Yoshino Cherry Pin Oak Red Oak Arborvitae	18-20' (4.5" cal.) 3-3.5" cal. 3" cal. 3-3.5" cal. 6" cal. 10-12' (3" cal.)	Full to base Full canopy Full canopy Full canopy	х
atanus occidentalis runus x yedoensis uercus palustris uercus rubra huja x 'Green Giant' lia cordata 'Greenspire' HRUBS uddleia davidii 'Nanho Blue'	American Sycamore Yoshino Cherry Pin Oak Red Oak Arborvitae	3-3.5" cal. 3" cal. 3-3.5" cal. 6" cal. 10-12' (3" cal.)	Full canopy Full canopy Full canopy	
runus x yedoensis uercus palustris uercus rubra huja x 'Green Giant' lia cordata 'Greenspire' HRUBS uddleia davidii 'Nanho Blue'	Yoshino Cherry Pin Oak Red Oak Arborvitae	3" cal. 3-3.5" cal. 6" cal. 10-12' (3" cal.)	Full canopy Full canopy	X
uercus palustris uercus rubra huja x 'Green Giant' lia cordata 'Greenspire' HRUBS uddleia davidii 'Nanho Blue'	Pin Oak Red Oak Arborvitae	3-3.5" cal. 6" cal. 10-12' (3" cal.)	Full canopy	
uercus rubra huja x 'Green Giant' lia cordata 'Greenspire' HRUBS uddleia davidii 'Nanho Blue'	Red Oak Arborvitae	6" cal. 10-12' (3" cal.)		х
huja x 'Green Giant' lia cordata 'Greenspire' HRUBS uddleia davidii 'Nanho Blue'	Arborvitae	10-12' (3" cal.)		
lia cordata 'Greenspire' HRUBS uddleia davidii 'Nanho Blue'			Full to base	Х
HRUBS uddleia davidii 'Nanho Blue'				
uddleia davidii 'Nanho Blue'		3-3.5 Cdl.	Full canopy	
uvus componitors	Butterfly Bush	7 gal		
uxus sempervirens	Boxwood	3'		
ornus sericea	Red Twig Dogwood	7 gal		х
ydrangea pan. 'Limelight'	Limelight Hydrangea	7 gal		
ydrangea pan. 'Little Lime'	Little Lime Hydrangea	7 gal		
ydrangea quercifolia 'Snow Queen'	Oakleaf Hydrangea	7 gal		
ydrangea quercifolia 'Snow White'	Oakleaf Hydrangea	7 gal		
ex crenata ' Chesapeake'	Japanese Holly Chesapeake	3-4'		
ex crenata 'Steeds'	Japanese Holly Steeds	3-4'		
ex verticillata	Winterberry	7 gal.		х
	-			x
				X
axus baccata 'Repandens'		-		
ERENNIALS				
gastache foeniculum	Hyssop	1 gal		х
msonia hubrichtii	Bluestar	1 gal		Х
sclepias incarnata	Milkweed	1 gal		х
ster novi-belgii	Aster	1 gal		х
runcus dioicus	Goats Beard	1 gal		х
arex appalachica	Sedge	1 gal		х
arex pensylvanica	Sedge	1 gal		х
hrystanthemum leaucanthemum	Oxeye Daisy	1 gal		
eschampsia cespitosa	Tufted Hairgrass	1 gal		х
helypteris noveboracensis	New York Fern	1 gal		х
chinacea purpurea 'Swan White'	Coneflower	1 gal		х
osta 'Guacamole'	Hosta			
				х
-				x
•		-		~
•				
				v
		-		x
				х
-				х
sarum caudatum	Wild Ginger	ı gal		х
QUANTITIES AND SPECIES A	RE SUBJECT TO CHANGE		TY. CONTRAC	TOR SH
oa Egnssraahehooaceeacoee	RENNIALS gastache foeniculum msonia hubrichtii cclepias incarnata eter novi-belgii runcus dioicus arex appalachica arex pensylvanica arystanthemum leaucanthemum eschampsia cespitosa relypteris noveboracensis hinacea purpurea 'Swan White'	wiraea nipponica 'Snowmound'Spireaxus baccata 'Repandens'English YewERENNIALSEnglish Yewgastache foeniculumHyssopmsonia hubrichtiiBluestariclepias incarnataMilkweedater novi-belgiiAsteruncus dioicusGoats Beardarex appalachicaSedgearex pensylvanicaSedgearex pensylvanicaConeflowerarex pensylvanicaBlazing Starappeta 'Blue WonderCatmintappeta 'Blue WonderCatmintappeta 'Cats Meow'Catminthirzachyrium scopariumLittle Bluestemhirzachyrium scopariumPurple Vervaincorobolus heterolepisPurple Vervainarex pensional sinaumCulvers Root <td>iriaea nipponica 'Snowmound'Spirea7 galxus baccata 'Repandens'English Yew5 galERENNIALSgastache foeniculumHyssop1 galnsonia hubrichtiiBluestar1 galiclepias incarnataMilkweed1 galuncus dioicusGoats Beard1 galuncus dioicusSedge1 galuncus dioicusNew York Fern1 galuncus dioidumaBeebalm1 galuncus dioidumaBeebalm1 galuncus dioidumaSalvia1 galuncus dioidumaSalvia1 galuncus dioidumaSalvia1 galuncus dioilus heterolepisParate Dropseed1 galuncus dioilus heterolepisPurple Vervain1 gal</td> <td>Initial and inponition 'Snowmound'Spirea7 galxus baccata 'Repandens'English Yew5 galRENNIALS</td>	iriaea nipponica 'Snowmound'Spirea7 galxus baccata 'Repandens'English Yew5 galERENNIALSgastache foeniculumHyssop1 galnsonia hubrichtiiBluestar1 galiclepias incarnataMilkweed1 galuncus dioicusGoats Beard1 galuncus dioicusSedge1 galuncus dioicusNew York Fern1 galuncus dioidumaBeebalm1 galuncus dioidumaBeebalm1 galuncus dioidumaSalvia1 galuncus dioidumaSalvia1 galuncus dioidumaSalvia1 galuncus dioilus heterolepisParate Dropseed1 galuncus dioilus heterolepisPurple Vervain1 gal	Initial and inponition 'Snowmound'Spirea7 galxus baccata 'Repandens'English Yew5 galRENNIALS

- VILLAGE PLANNING BOARD.
- PROTECTION DURING TRANSPORTING.
- CAN REJECT MATERIAL IF NOT DEEMED IN GOOD QUALITY OR DAMAGED. ARCHITECT.
- 6. CONTRACTOR SHALL NOT STOCKPILE PLANTS ON ASPHALT OR ANY MASONRY SURFACE. MOISTURE.
- 8. ALL STOCKPILED VEGETATION SHALL BE PROPERLY WATERED AND MAINTAINED UNTIL INSTALLATION.
- TYPE OF LANDSCAPE WORK REQUIRED.
- OF ONE REPLACEMENT, IN PRICING.
- PLANT MATERIAL, SEEDED AND LAWN AREAS.

90% Native Overall

3. ALL PLANTS ARE TO ARRIVE ON SITE IN GOOD HEALTH FROM A CERTIFIED NURSERY WITH PROPER

4. ALL PLANT MATERIAL IS SUBJECT TO INSPECTION UPON ARRIVAL TO SITE. LANDSCAPE ARCHITECT 5. CONTRACTOR SHALL NOT PRUNE ANY PLANT MATERIAL WITHOUT APPROVAL BY LANDSCAPE

7. DELIVER TREES AND SHRUBS AFTER PREPARATIONS FOR PLANTING HAVE BEEN COMPLETED AND PLANT IMMEDIATELY. IF PLANTING IS DELAYED MORE THAN 6 HOURS AFTER DELIVERY, SET TREES AND SHRUBS IN SHADE, PROTECT FROM WEATHER AND MECHANICAL DAMAGE, AND KEEP ROOTS MOIST BY COVERING WITH MULCH, BURLAP OR OTHER ACCEPTABLE MEANS OF RETAINING

9. PLANT MATERIAL SHALL BE PLANTED WITHIN SEASONAL LIMITATIONS FOR EACH SPECIES TYPE AND

10. CONTRACTOR SHALL INCLUDE 1 YEAR WARRANTY ON ALL PLANT MATERIAL, INCLUDING THE COSTS

11. PROVIDE TYPEWRITTEN MAINTENANCE INSTRUCTIONS FOR THE CONTINUING CARE OF INSTALLED PLANTS THROUGH 1 FULL GROWING SEASON TO ENSURE ACCEPTABLE ESTABLISHMENT OF ALL



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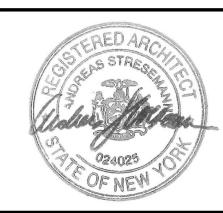
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ELECTRIC OWL STUDIOS

3		
	PROJ. MANA	GER: AS
7/24	SCALE: A	S NOTED
7	7/24	

SITE PLAN - ADDITIONAL NOTES

DRAWING NO.

PROJECT NAME



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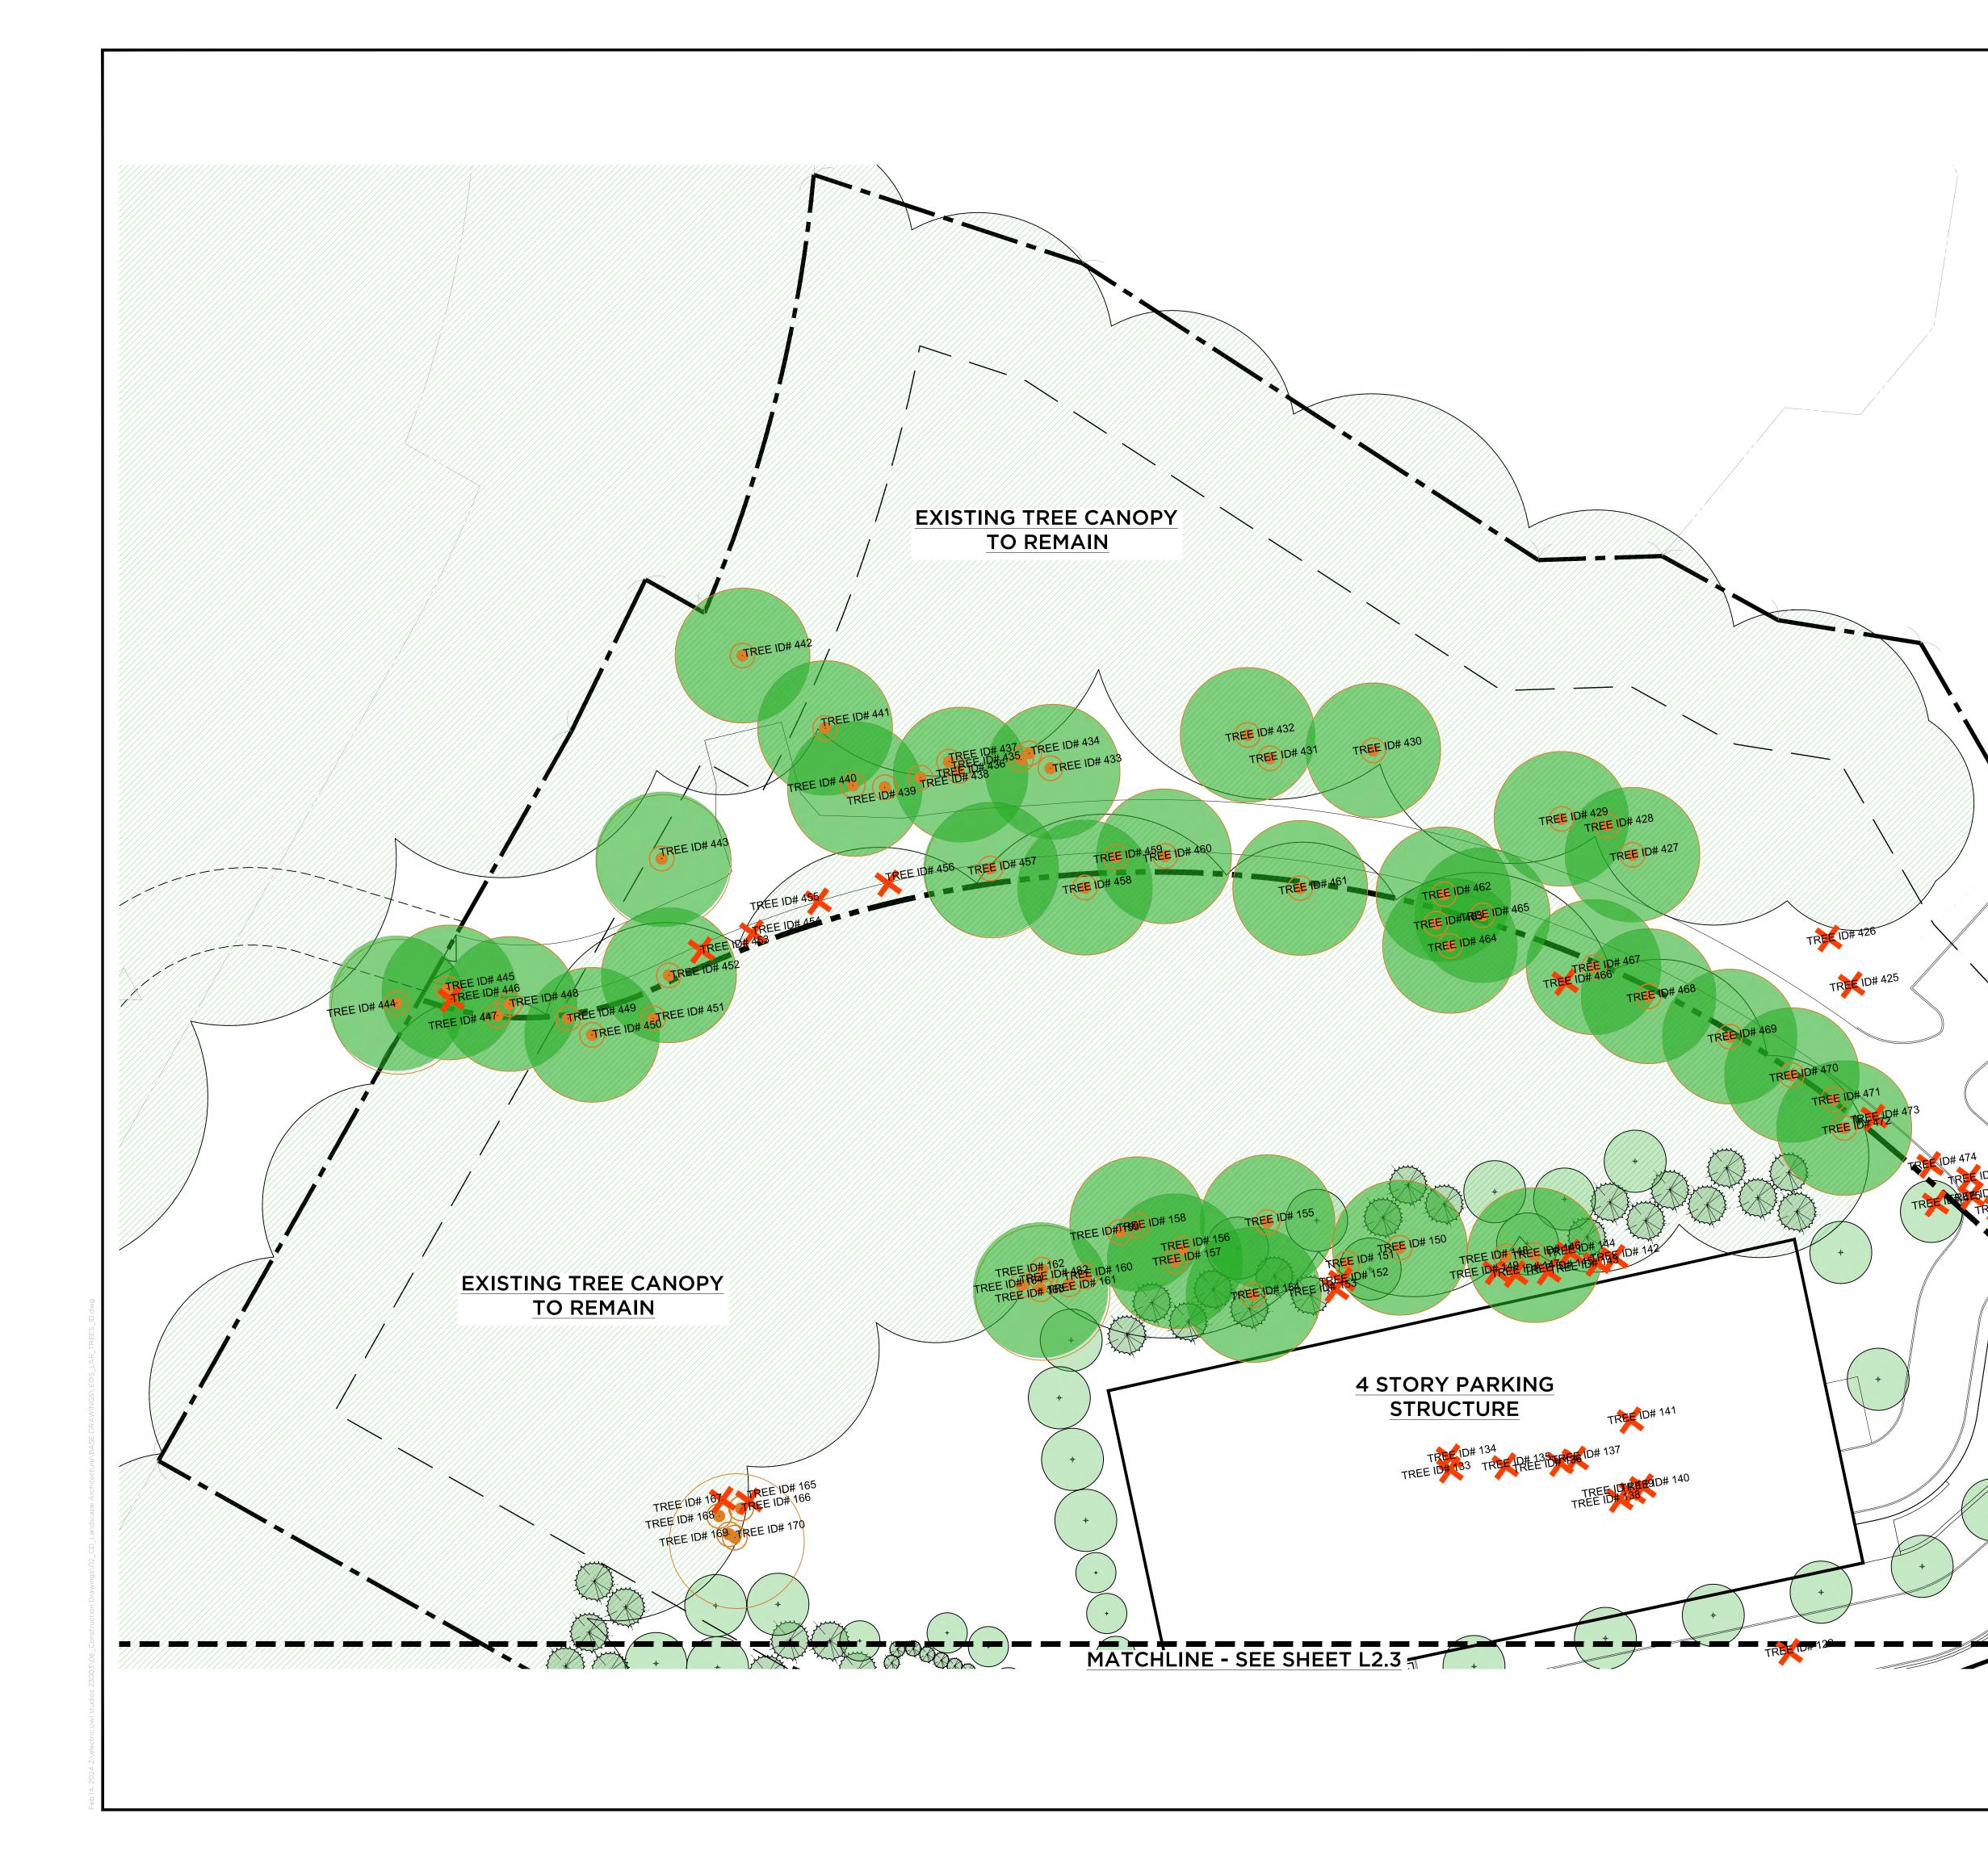
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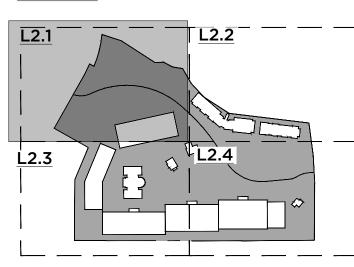
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ELECTRIC OWL STUDIOS

1 S BROAD HASTINGS	WAY ON HUDSON, N	lΥ	
JOB NO.:	23003		
DRAWN B	Y: JS	PROJ. MA	NAGER: AS
DATE:	02/07/24	SCALE:	AS NOTED



KEY MAP



LEGEND



EXISTING TREE TO REMAIN (209) EXISTING TREE

TRANSPLANTED (4)

EXISTING TREE REMOVED (277)

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PLANTING PLAN TREE ID# 433 EXISTING TREE ARBORIST

PROPOSED TREES - SEE

REPORT ID#

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NOTES: - TREE SIZES AND LOCATIONS BASED ON TREE SURVEY

COMPLETED BY SAV-A-TREE DATED 3/30/23. - REFERENCE SAV-A-TREE ARBORIST REPORT FOR

CORRESPONDING FOR EXISTING TREE SPECIES, CALIPER AND HEALTH TREE CANOPY IS APPROXIMATED

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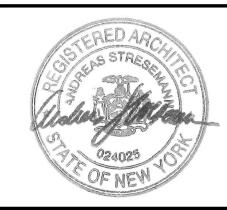
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PROJECT NAME ELECTRIC OWL STUDIOS

1 S BROADWAY HASTINGS ON HUDSON, NY JOB NO.: **23003** DRAWN BY IS PRO I MANAGER[.] AS


DRAWN DY. JS		PROJ. MANAGER. AS		
DATE:	02/07/24	SCALE:	AS NOTED	
DRAWING	GTITLE			

TREE REMOVAL PLAN


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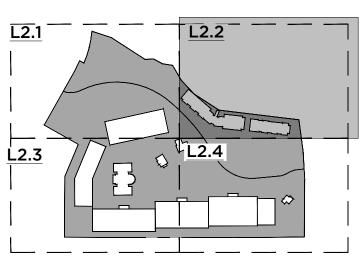
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SCALE 1" = 30' - 0"



KEY MAP

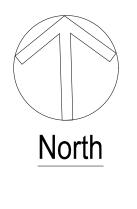

LEGEND

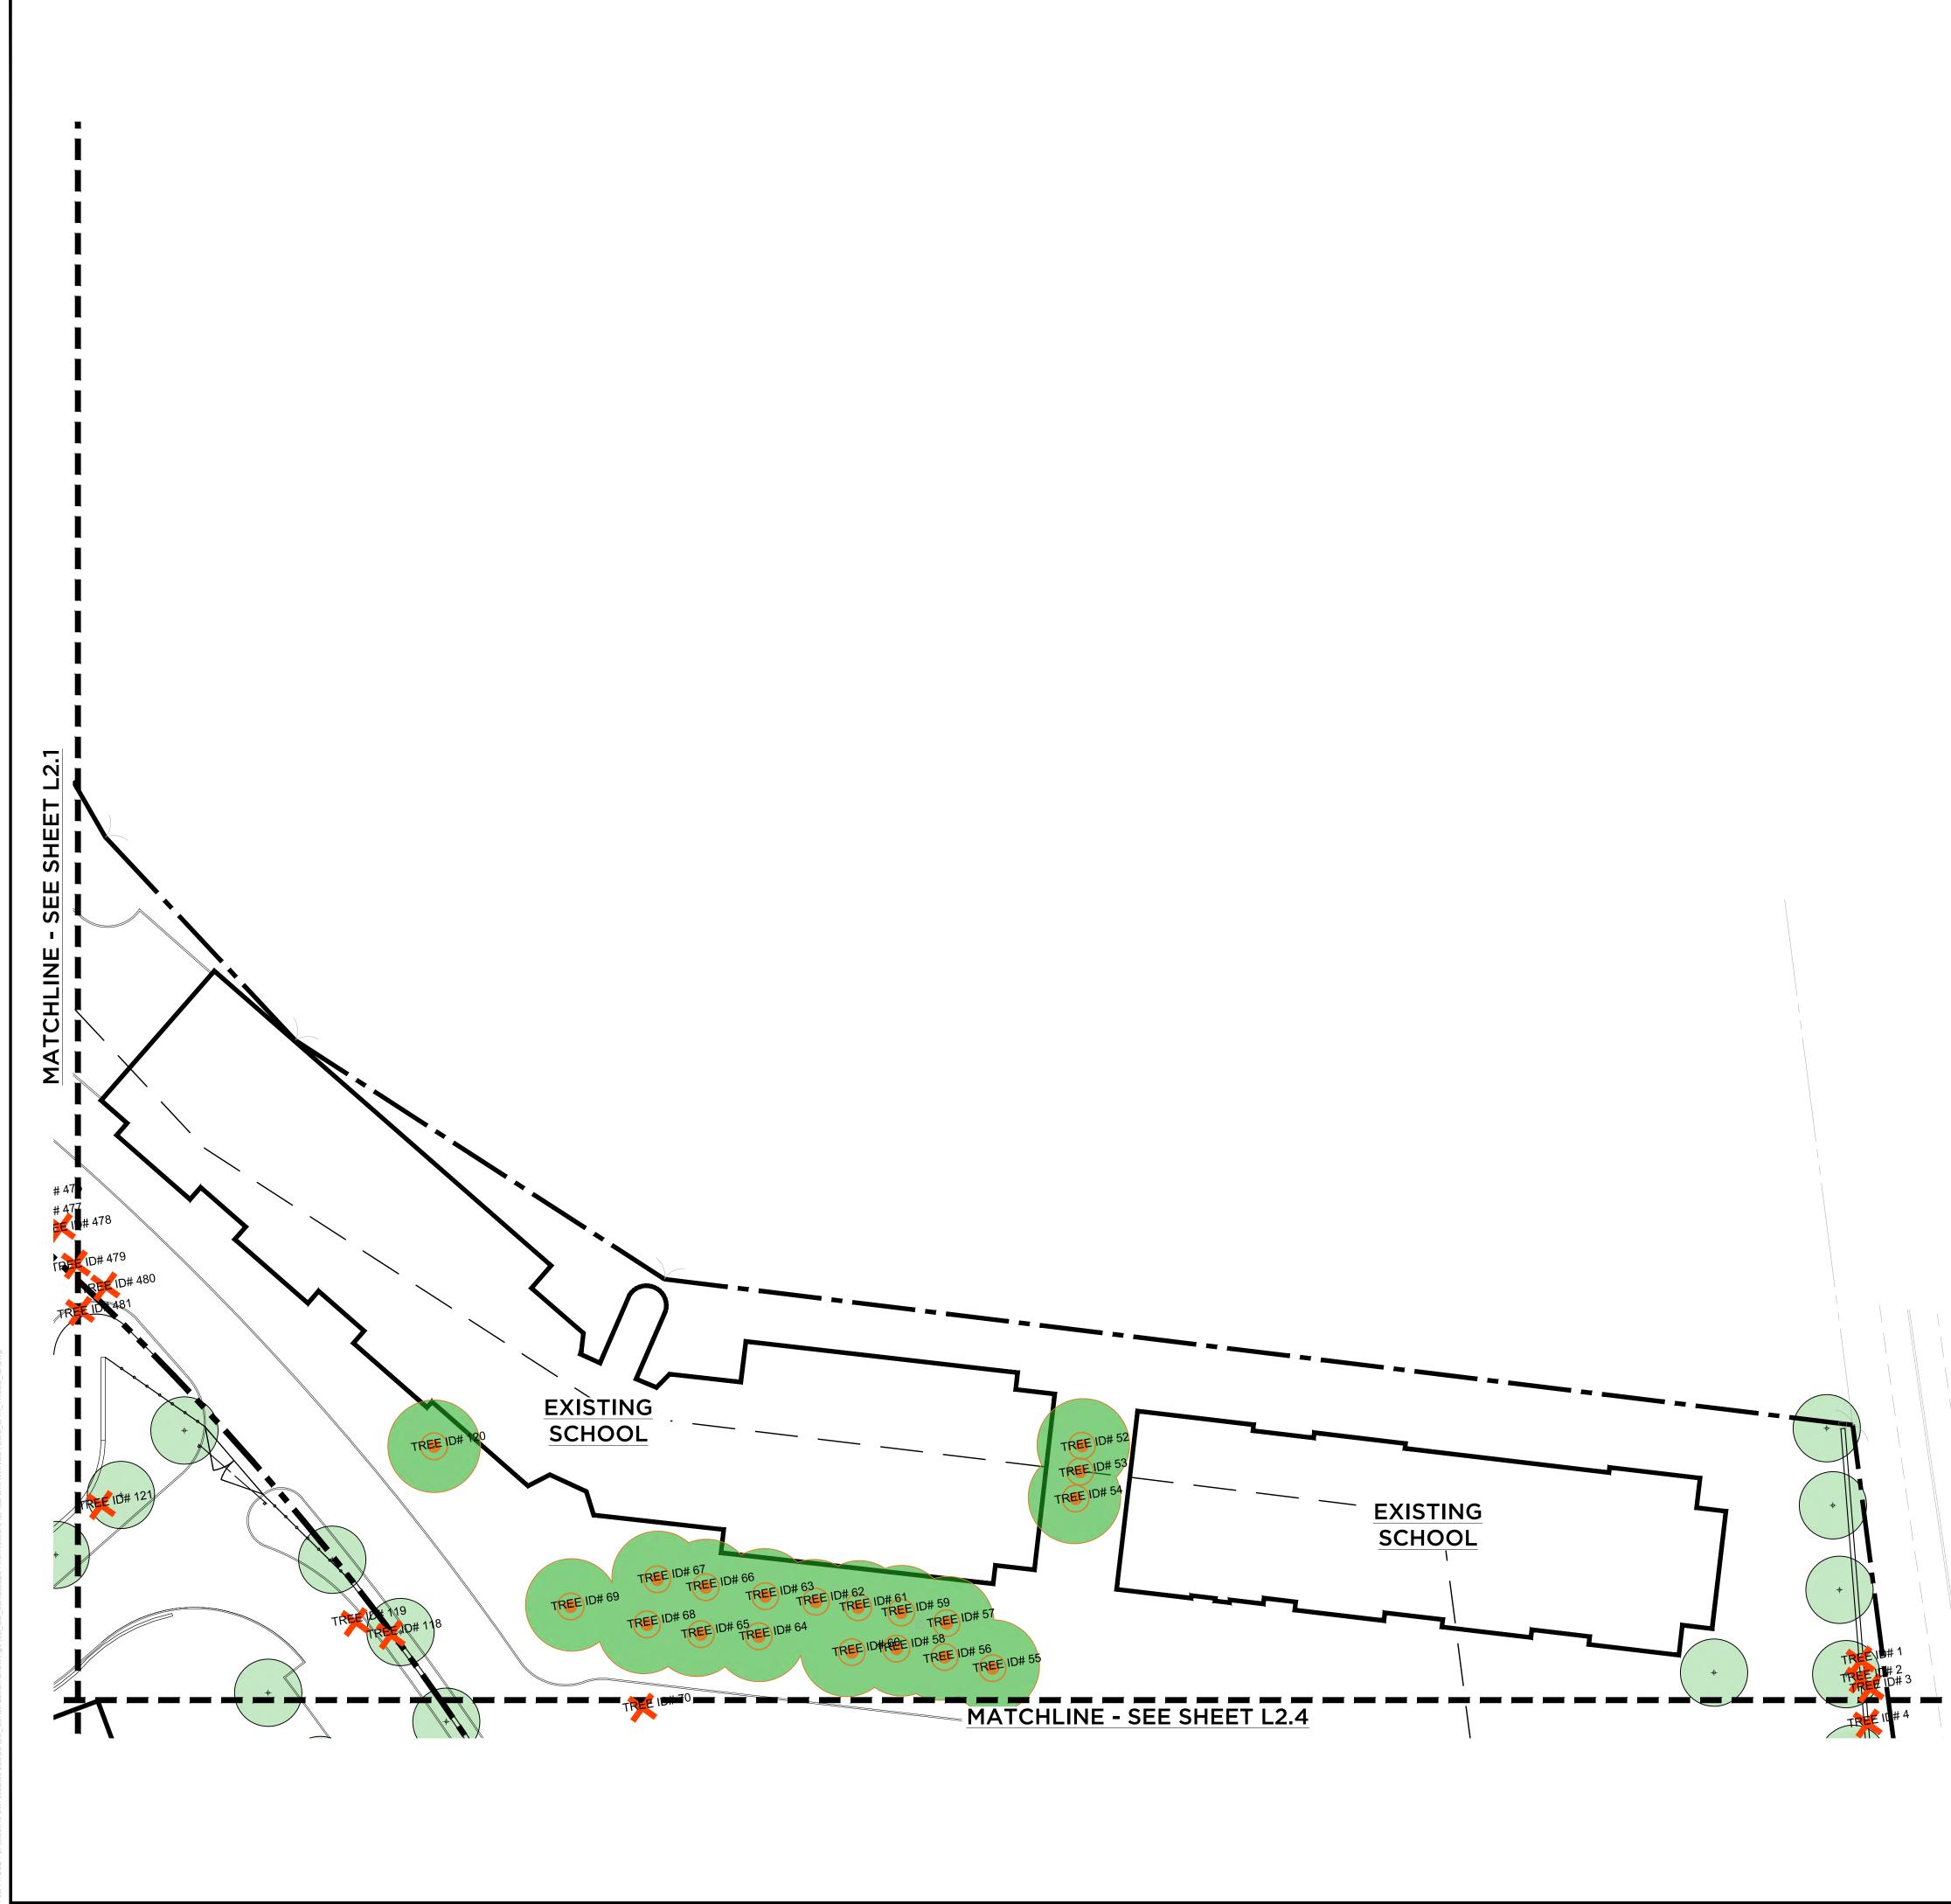

EXISTING TREE TO REMAIN (209)

 \bigcirc X

EXISTING TREE REMOVED (277)

PROPOSED TREES - SEE PLANTING PLAN

EXISTING TREE

TRANSPLANTED (4)

TREE ID# 433 EXISTING TREE ARBORIST

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NOTES: - TREE SIZES AND LOCATIONS BASED ON TREE SURVEY COMPLETED BY SAV-A-TREE

REPORT ID#

DATED 3/30/23. - REFERENCE SAV-A-TREE ARBORIST REPORT FOR CORRESPONDING FOR EXISTING TREE SPECIES, CALIPER AND HEALTH

- TREE CANOPY IS APPROXIMATED

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PROJECT NAME ELECTRIC OWL STUDIOS

1 S BROADWAY HASTINGS ON HUDSON, NY

JOB NO.: **23003**

PROJ. MANAGER: **AS** DRAWN BY: **JS** 02/07/24 SCALE: AS NOTED DATE:


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TREE REMOVAL PLAN


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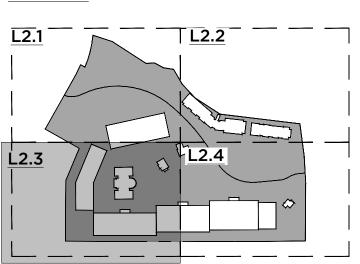
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SCALE 1" = 30' - 0"



KEY MAP

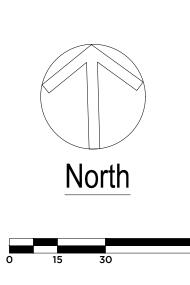

LEGEND

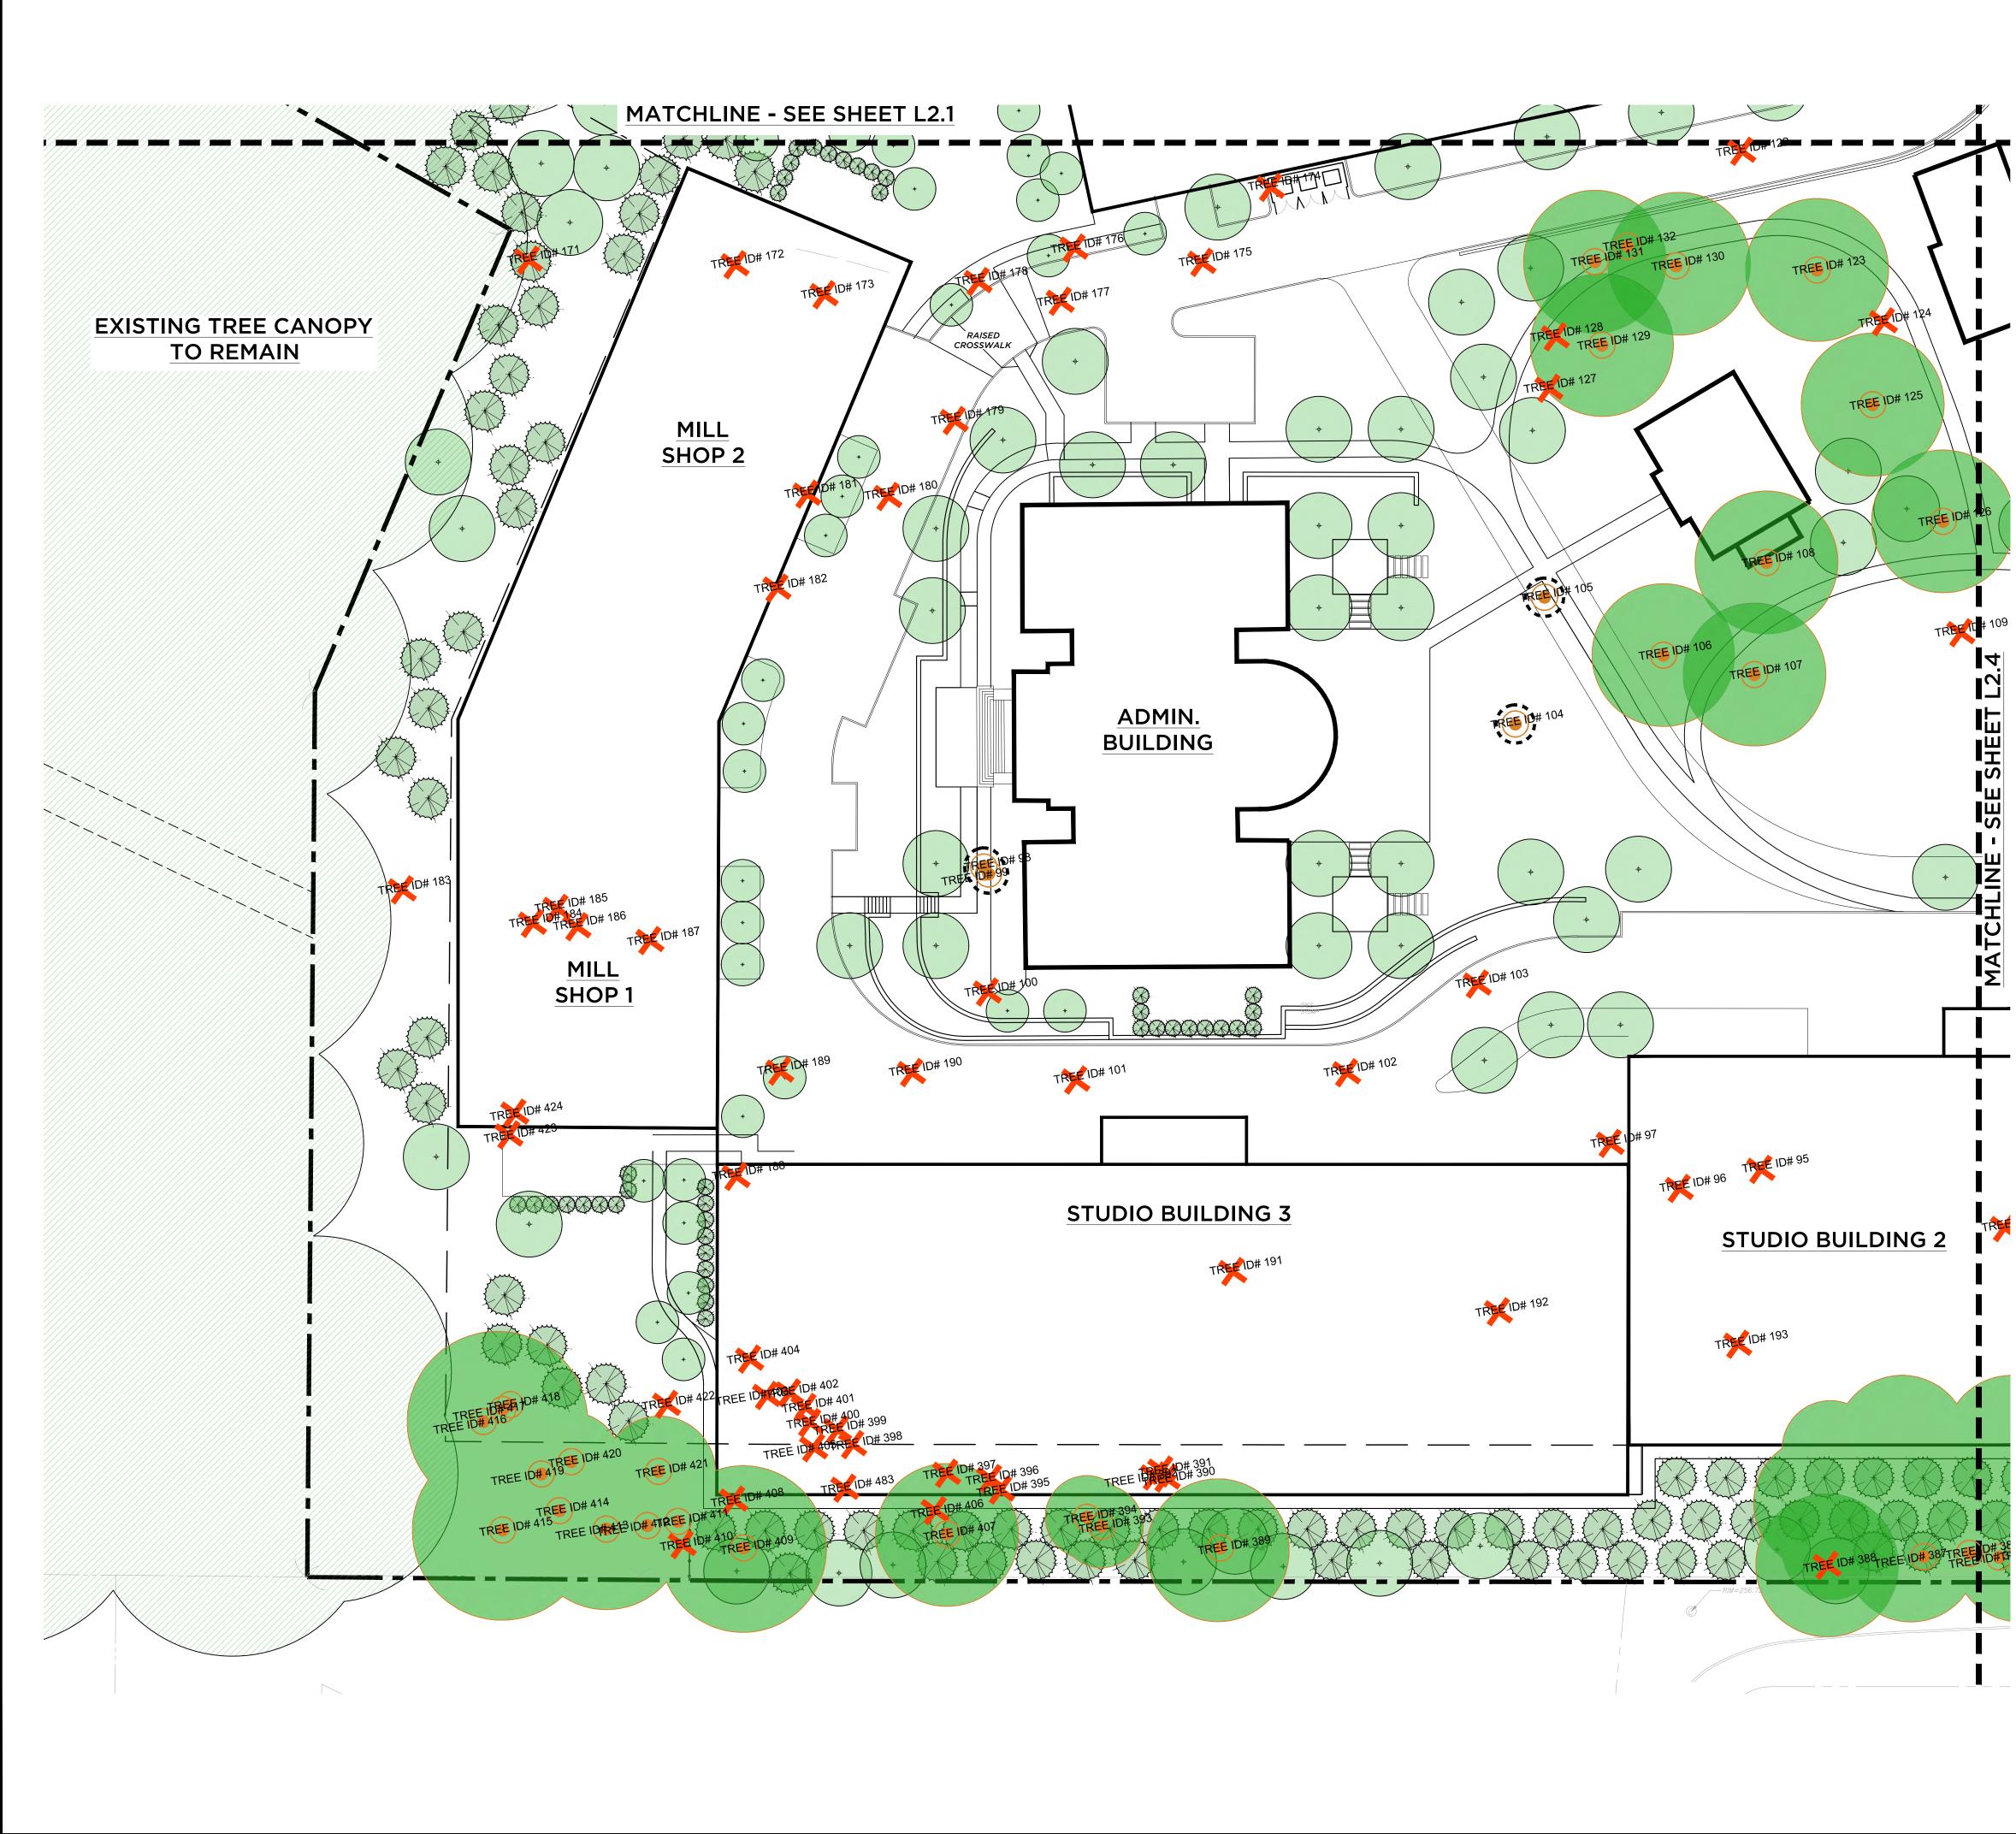

EXISTING TREE TO REMAIN (209)

EXISTING TREE \bigcirc TRANSPLANTED (4) ×

EXISTING TREE REMOVED (277)

 $\bigcirc \bigcirc \bigcirc$

PLANTING PLAN TREE ID# 433 EXISTING TREE ARBORIST REPORT ID#

PROPOSED TREES - SEE

NOTES:

- TREE SIZES AND LOCATIONS BASED ON TREE SURVEY COMPLETED BY SAV-A-TREE

- DATED 3/30/23. - REFERENCE SAV-A-TREE ARBORIST REPORT FOR CORRESPONDING FOR EXISTING TREE SPECIES, CALIPER AND HEALTH
- TREE CANOPY IS APPROXIMATED



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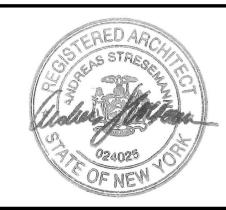
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PROJECT NAME ELECTRIC OWL STUDIOS

1 S BROADWAY HASTINGS ON HUDSON, NY


JOB NO.: **23003** DRAWN BY: **JS** PROJ. MANAGER: **AS** DATE: 02/07/24 SCALE: AS NOTED


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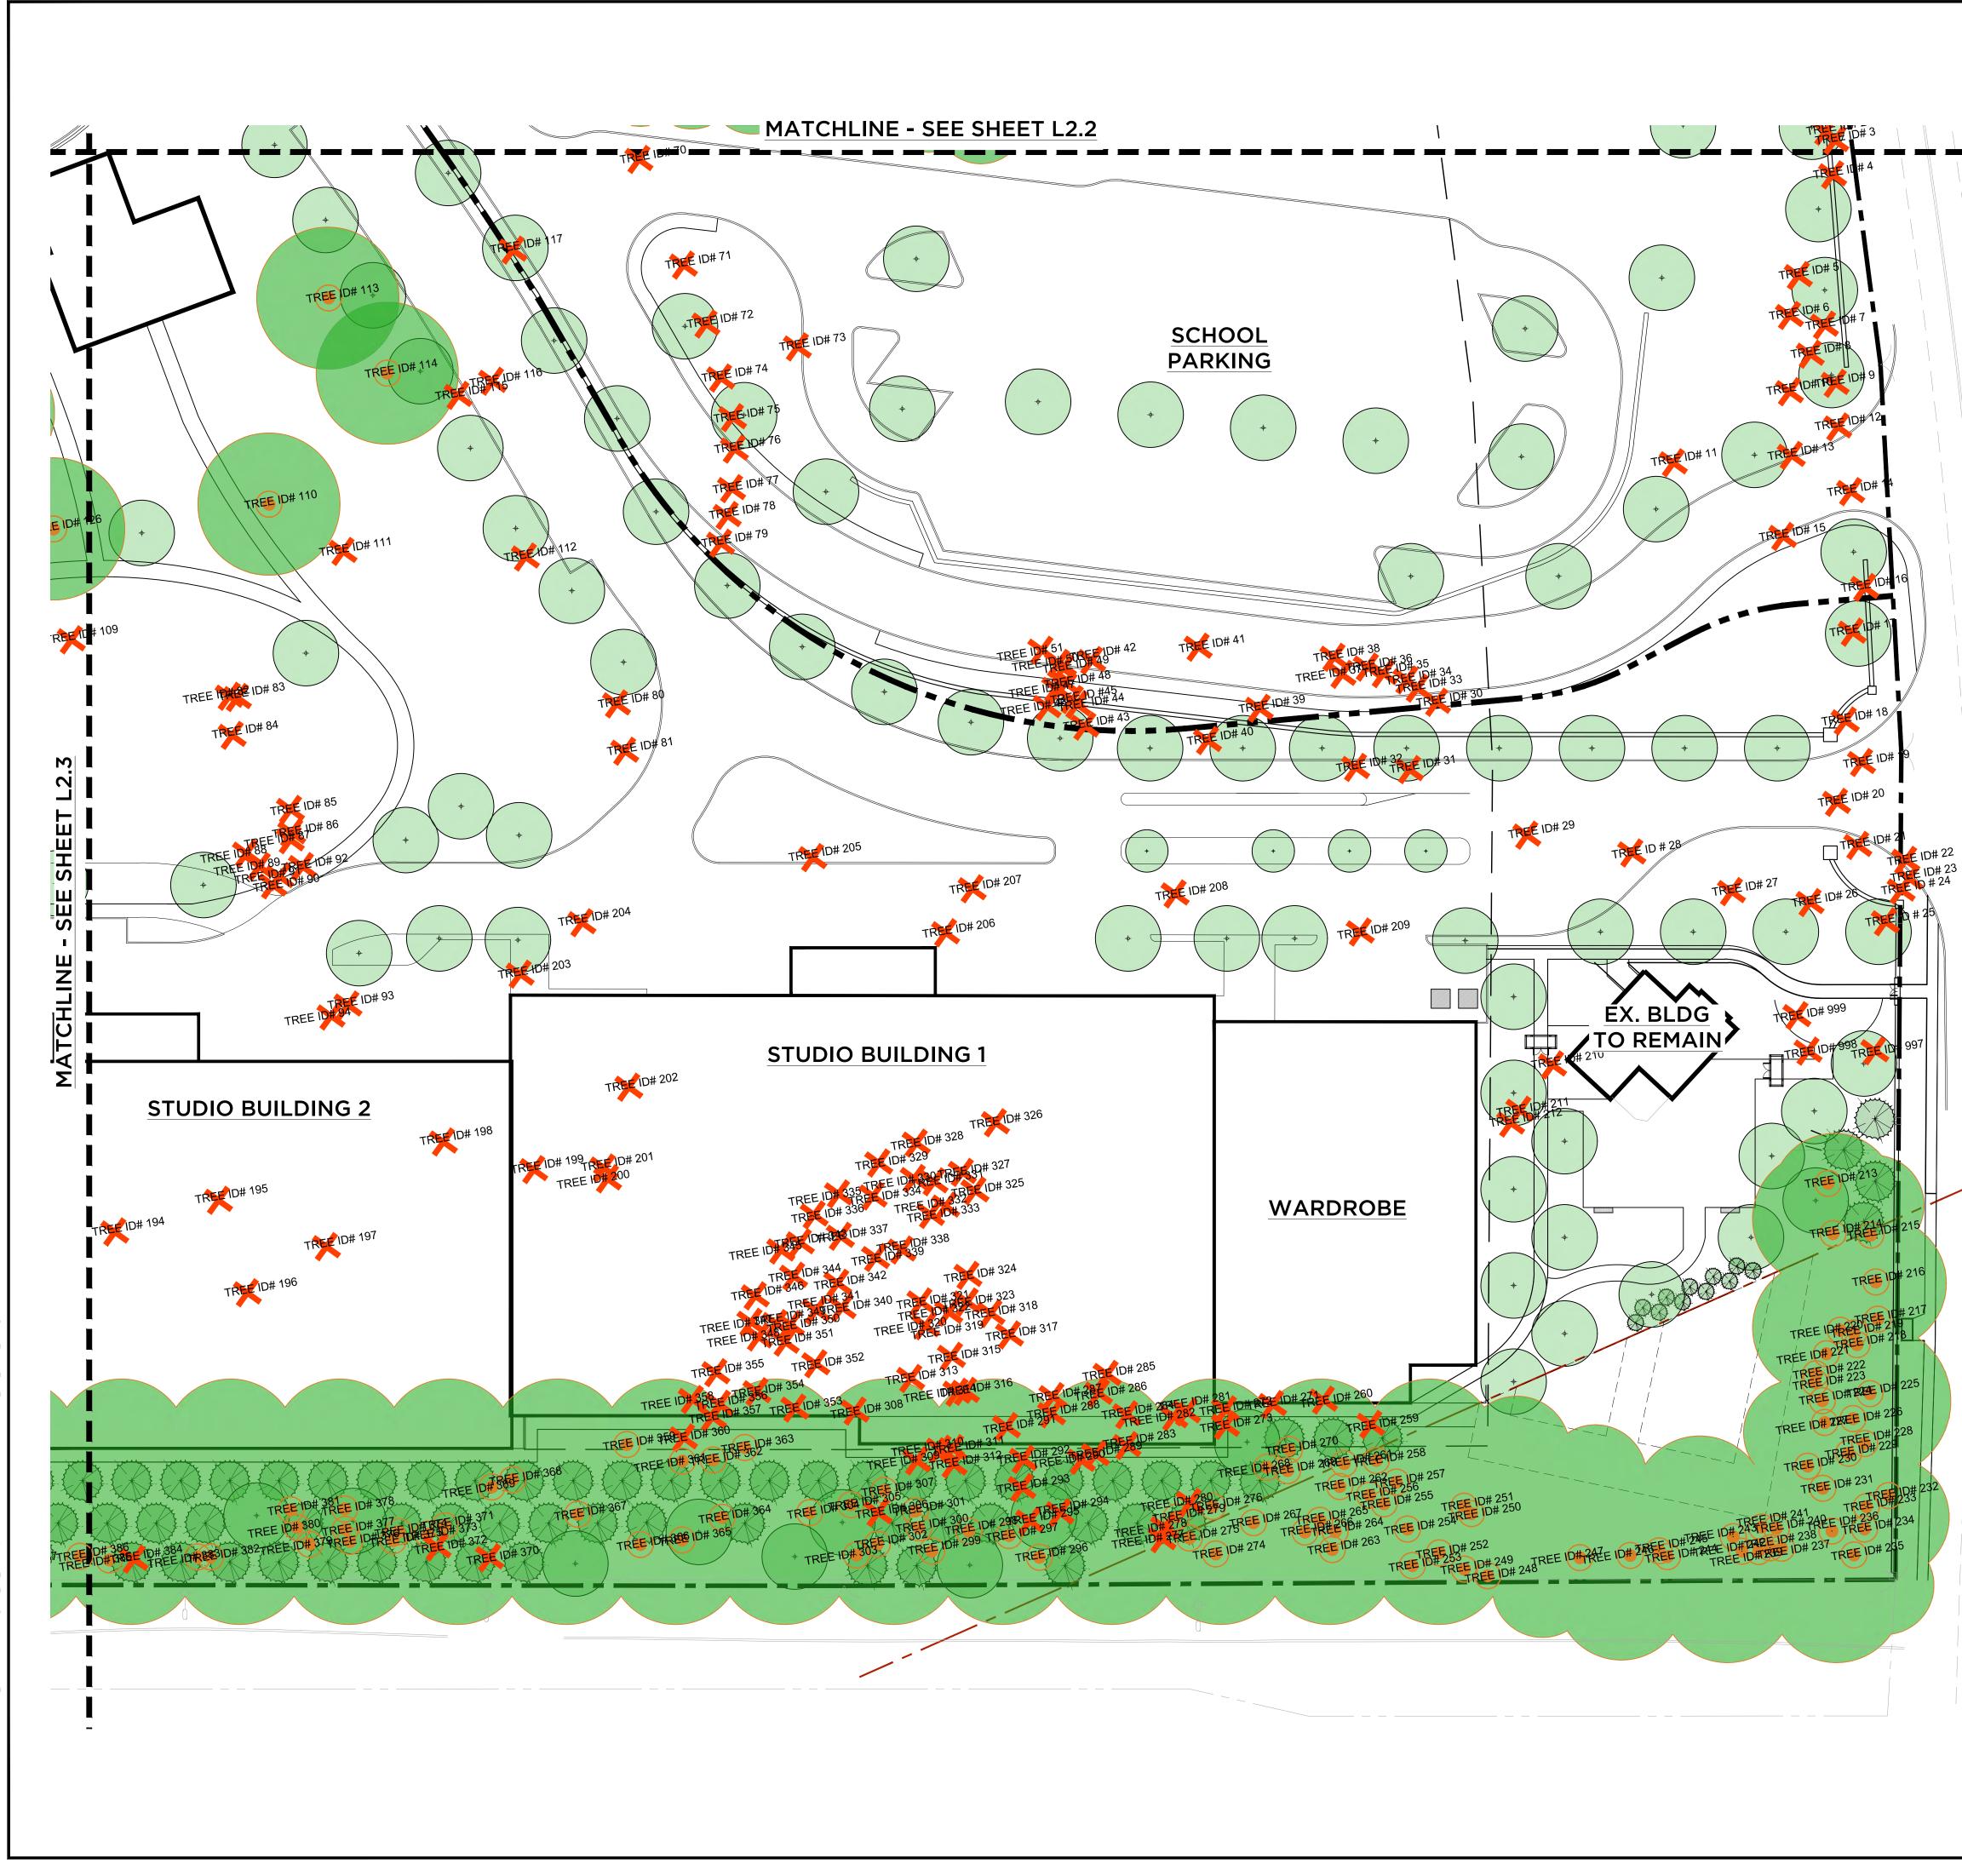
TREE REMOVAL PLAN

DRAWING NO.






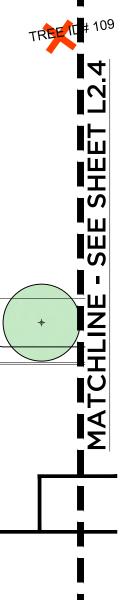

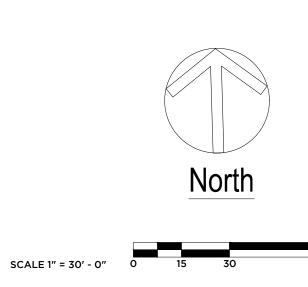

KEY MAP

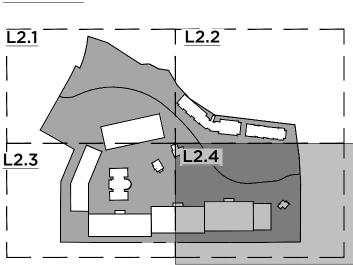

LEGEND



EXISTING TREE TO REMAIN (209)



EXISTING TREE TRANSPLANTED (4)

EXISTING TREE REMOVED (277)

·) PROPOSED TREES - SEE

PLANTING PLAN TREE ID# 433 EXISTING TREE ARBORIST REPORT ID#

NOTES:

- TREE SIZES AND LOCATIONS BASED ON TREE SURVEY COMPLETED BY SAV-A-TREE DATED 3/30/23.

- REFERENCE SAV-A-TREE ARBORIST REPORT FOR CORRESPONDING FOR EXISTING TREE SPECIES, CALIPER AND HEALTH
- TREE CANOPY IS APPROXIMATED

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PROJECT NAME ELECTRIC OWL STUDIOS

1 S BROADWAY HASTINGS ON HUDSON, NY

JOB NO.: **23003** DRAWN BY: **JS** PROJ. MANAGER: **AS**

DATE: 02/07/24 SCALE: AS NOTED


TREE REMOVAL PLAN

DRAWING NO.


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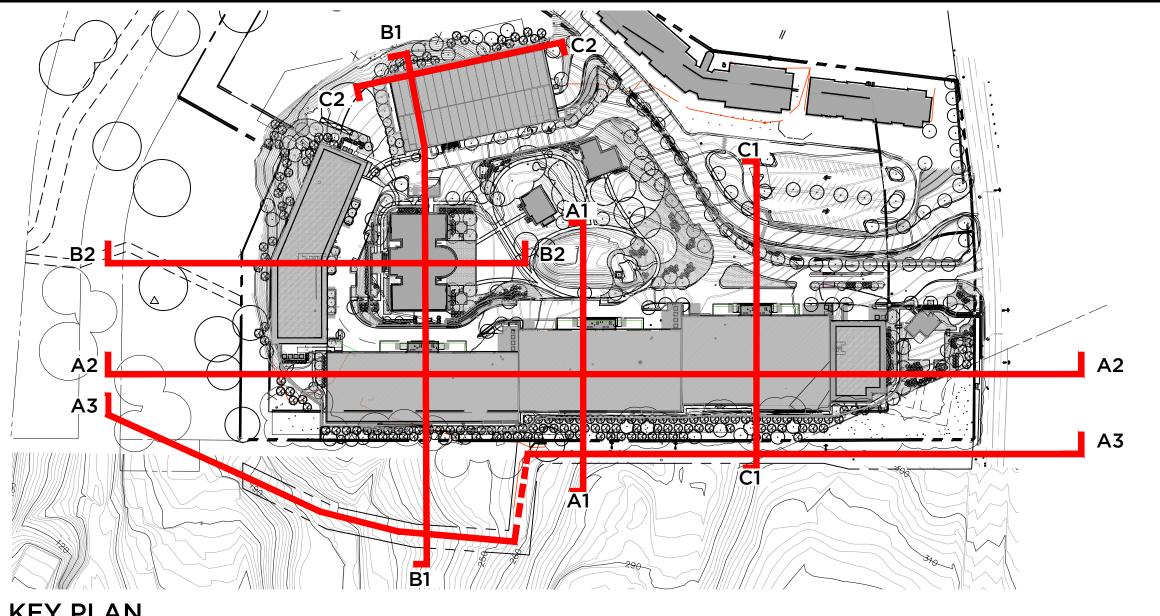


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SCALE 1" = 30' - 0"



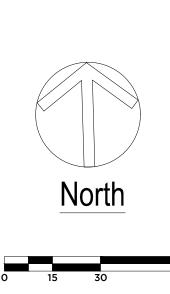

	330'		MECHANICAL SCREENING ON NORTH SIDE OF RIDGE (TYP.)	PROPERTY LINE
<u>STUDIO</u> <u>BUILDING 2</u> FFE: 257.5'	290'	<u>STUDIO</u> BUILDING 1 FFE: 265.0'	WARDROBE 32-0 FFE: 270.0'	
	250'			
	230' 220'			
	200'			

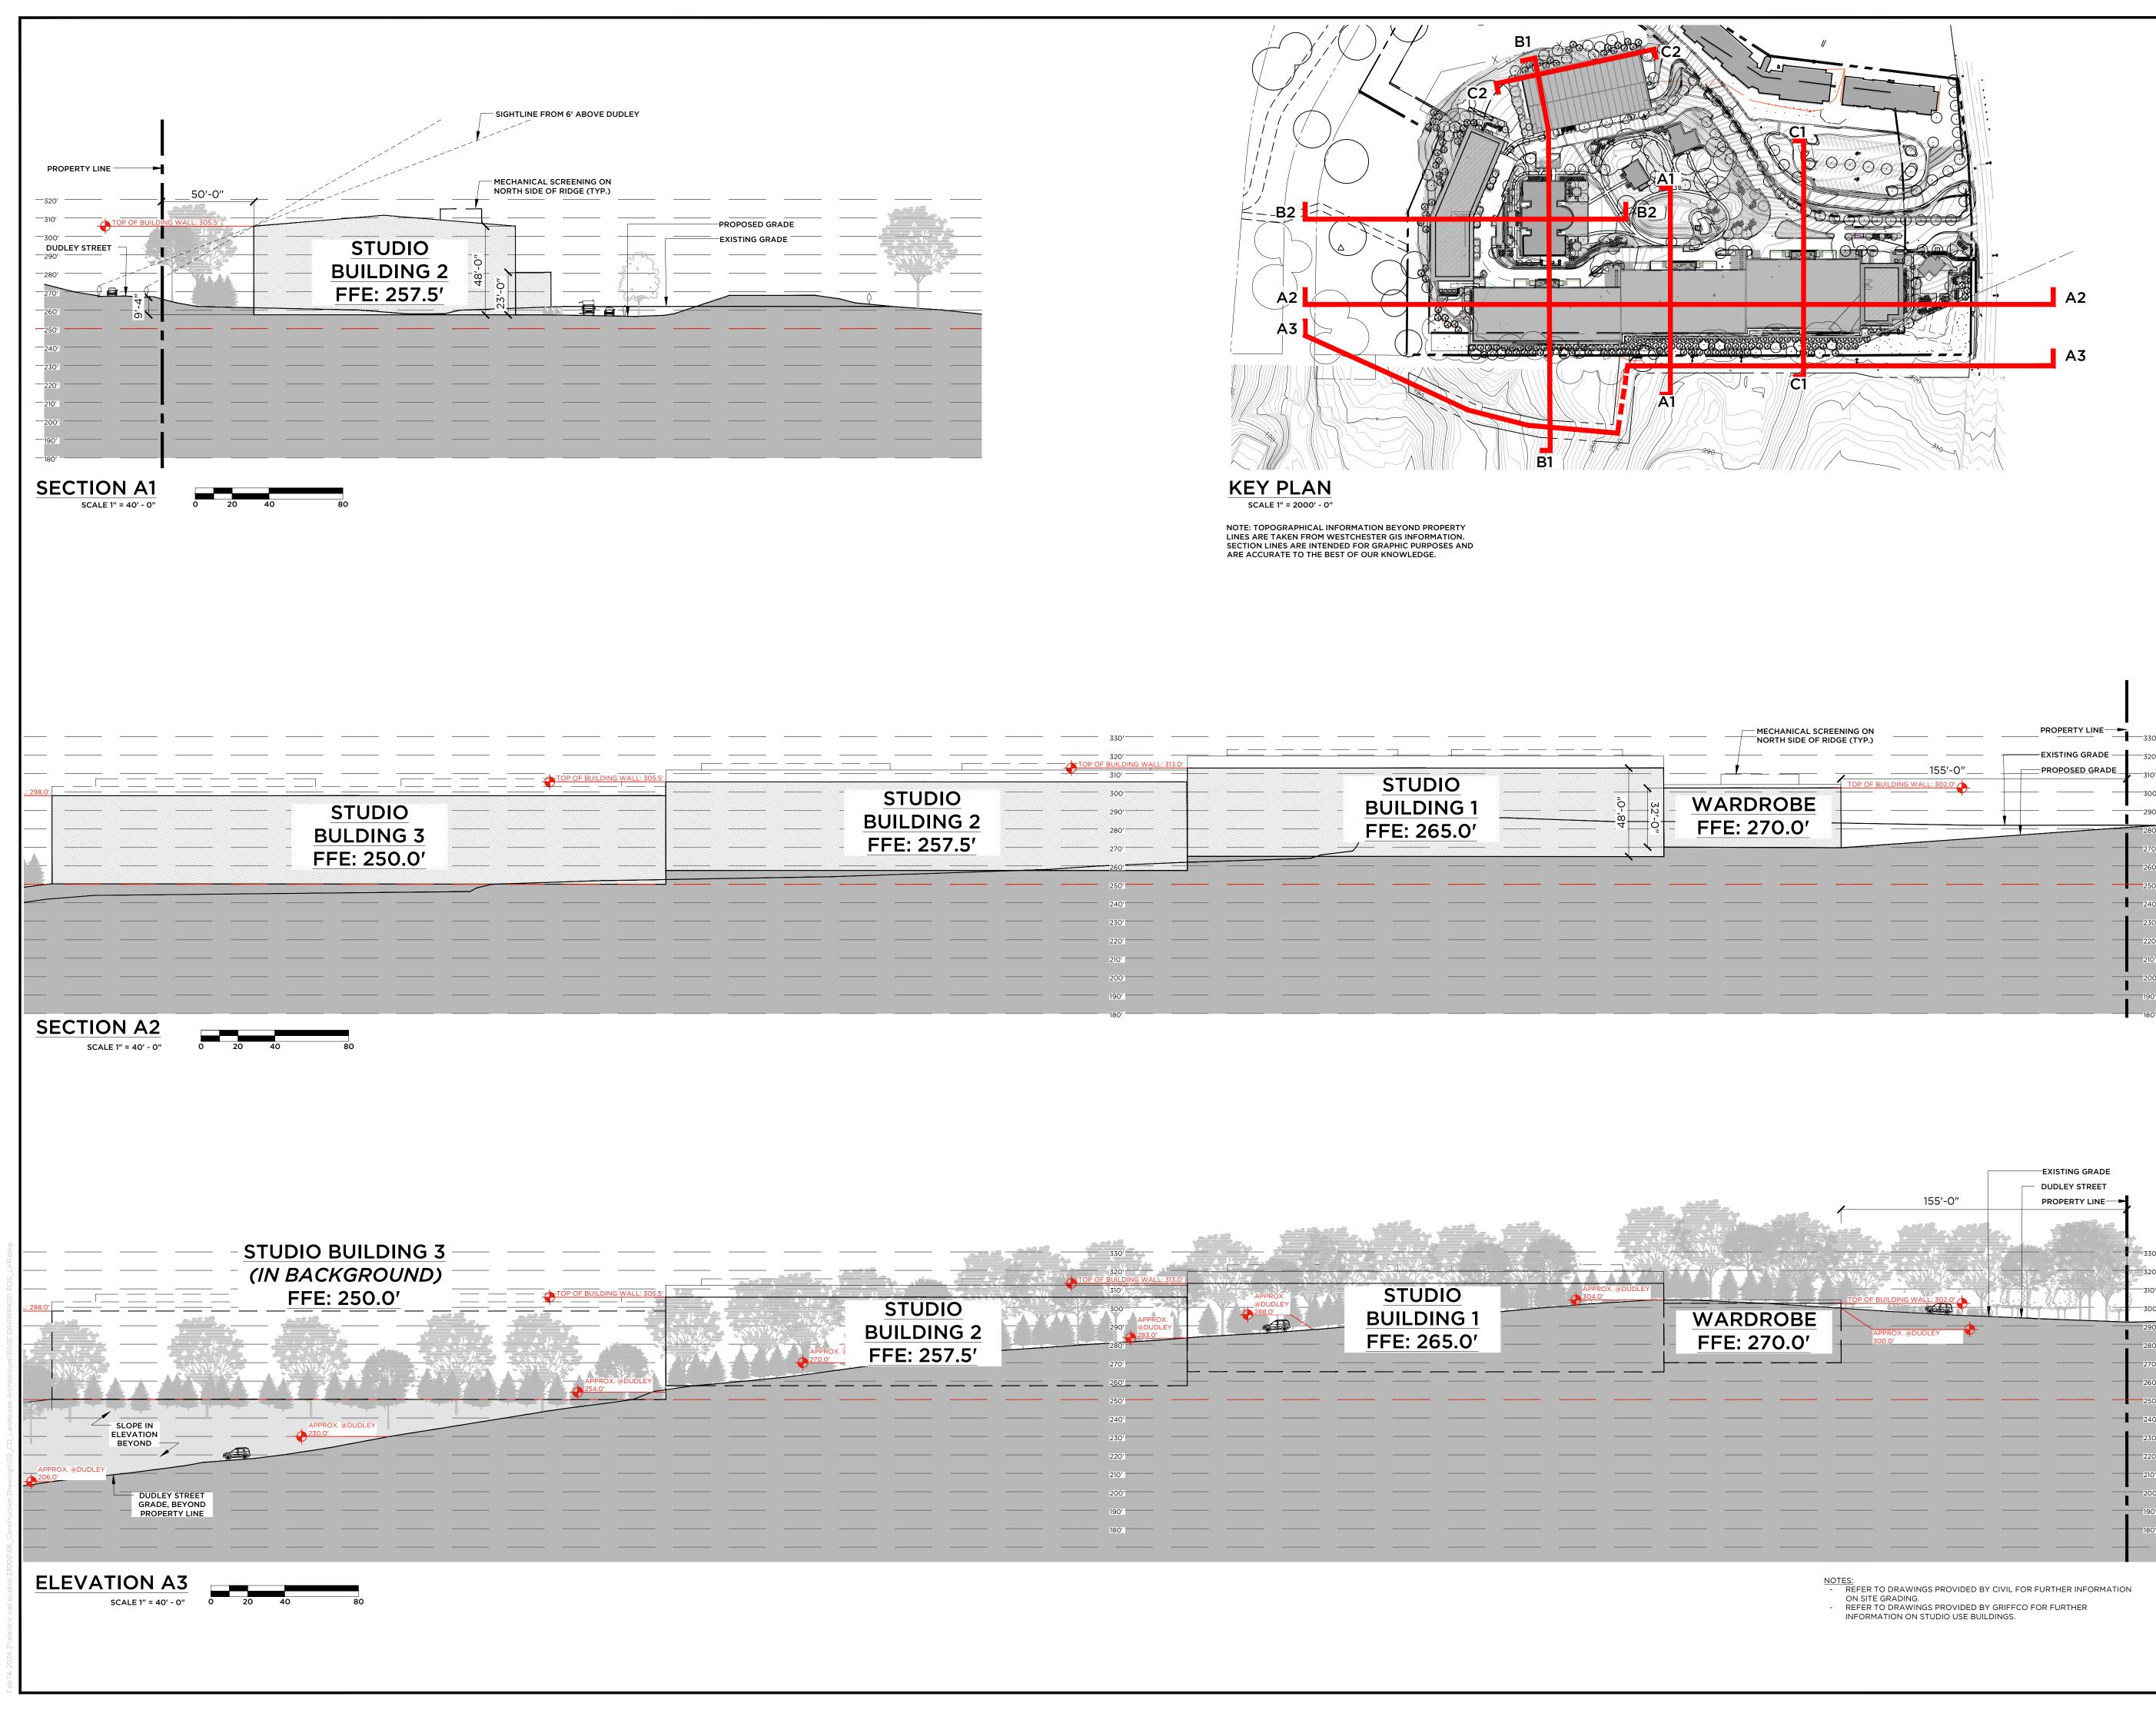

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PROJECT NAME

ELECTRIC OWL STUDIOS

1 S BROADWAY	


HASTINGS ON HUDSON, NY			
JOB NO.:	23003		

DRAWN BY: JS		PROJ. MANAGER: AS		
DATE:	02/07/24	SCALE:	AS NOTED	
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PROJECT NAME ELECTRIC OWL STUDIOS


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HASTINGS ON HUDSON, NY

JOB NO.:	23003		
DRAWN BY: JS PROJ. MANAGER: A		ANAGER: AS	
DATE:	02/07/24	SCALE:	AS NOTED
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DRAWING NO.



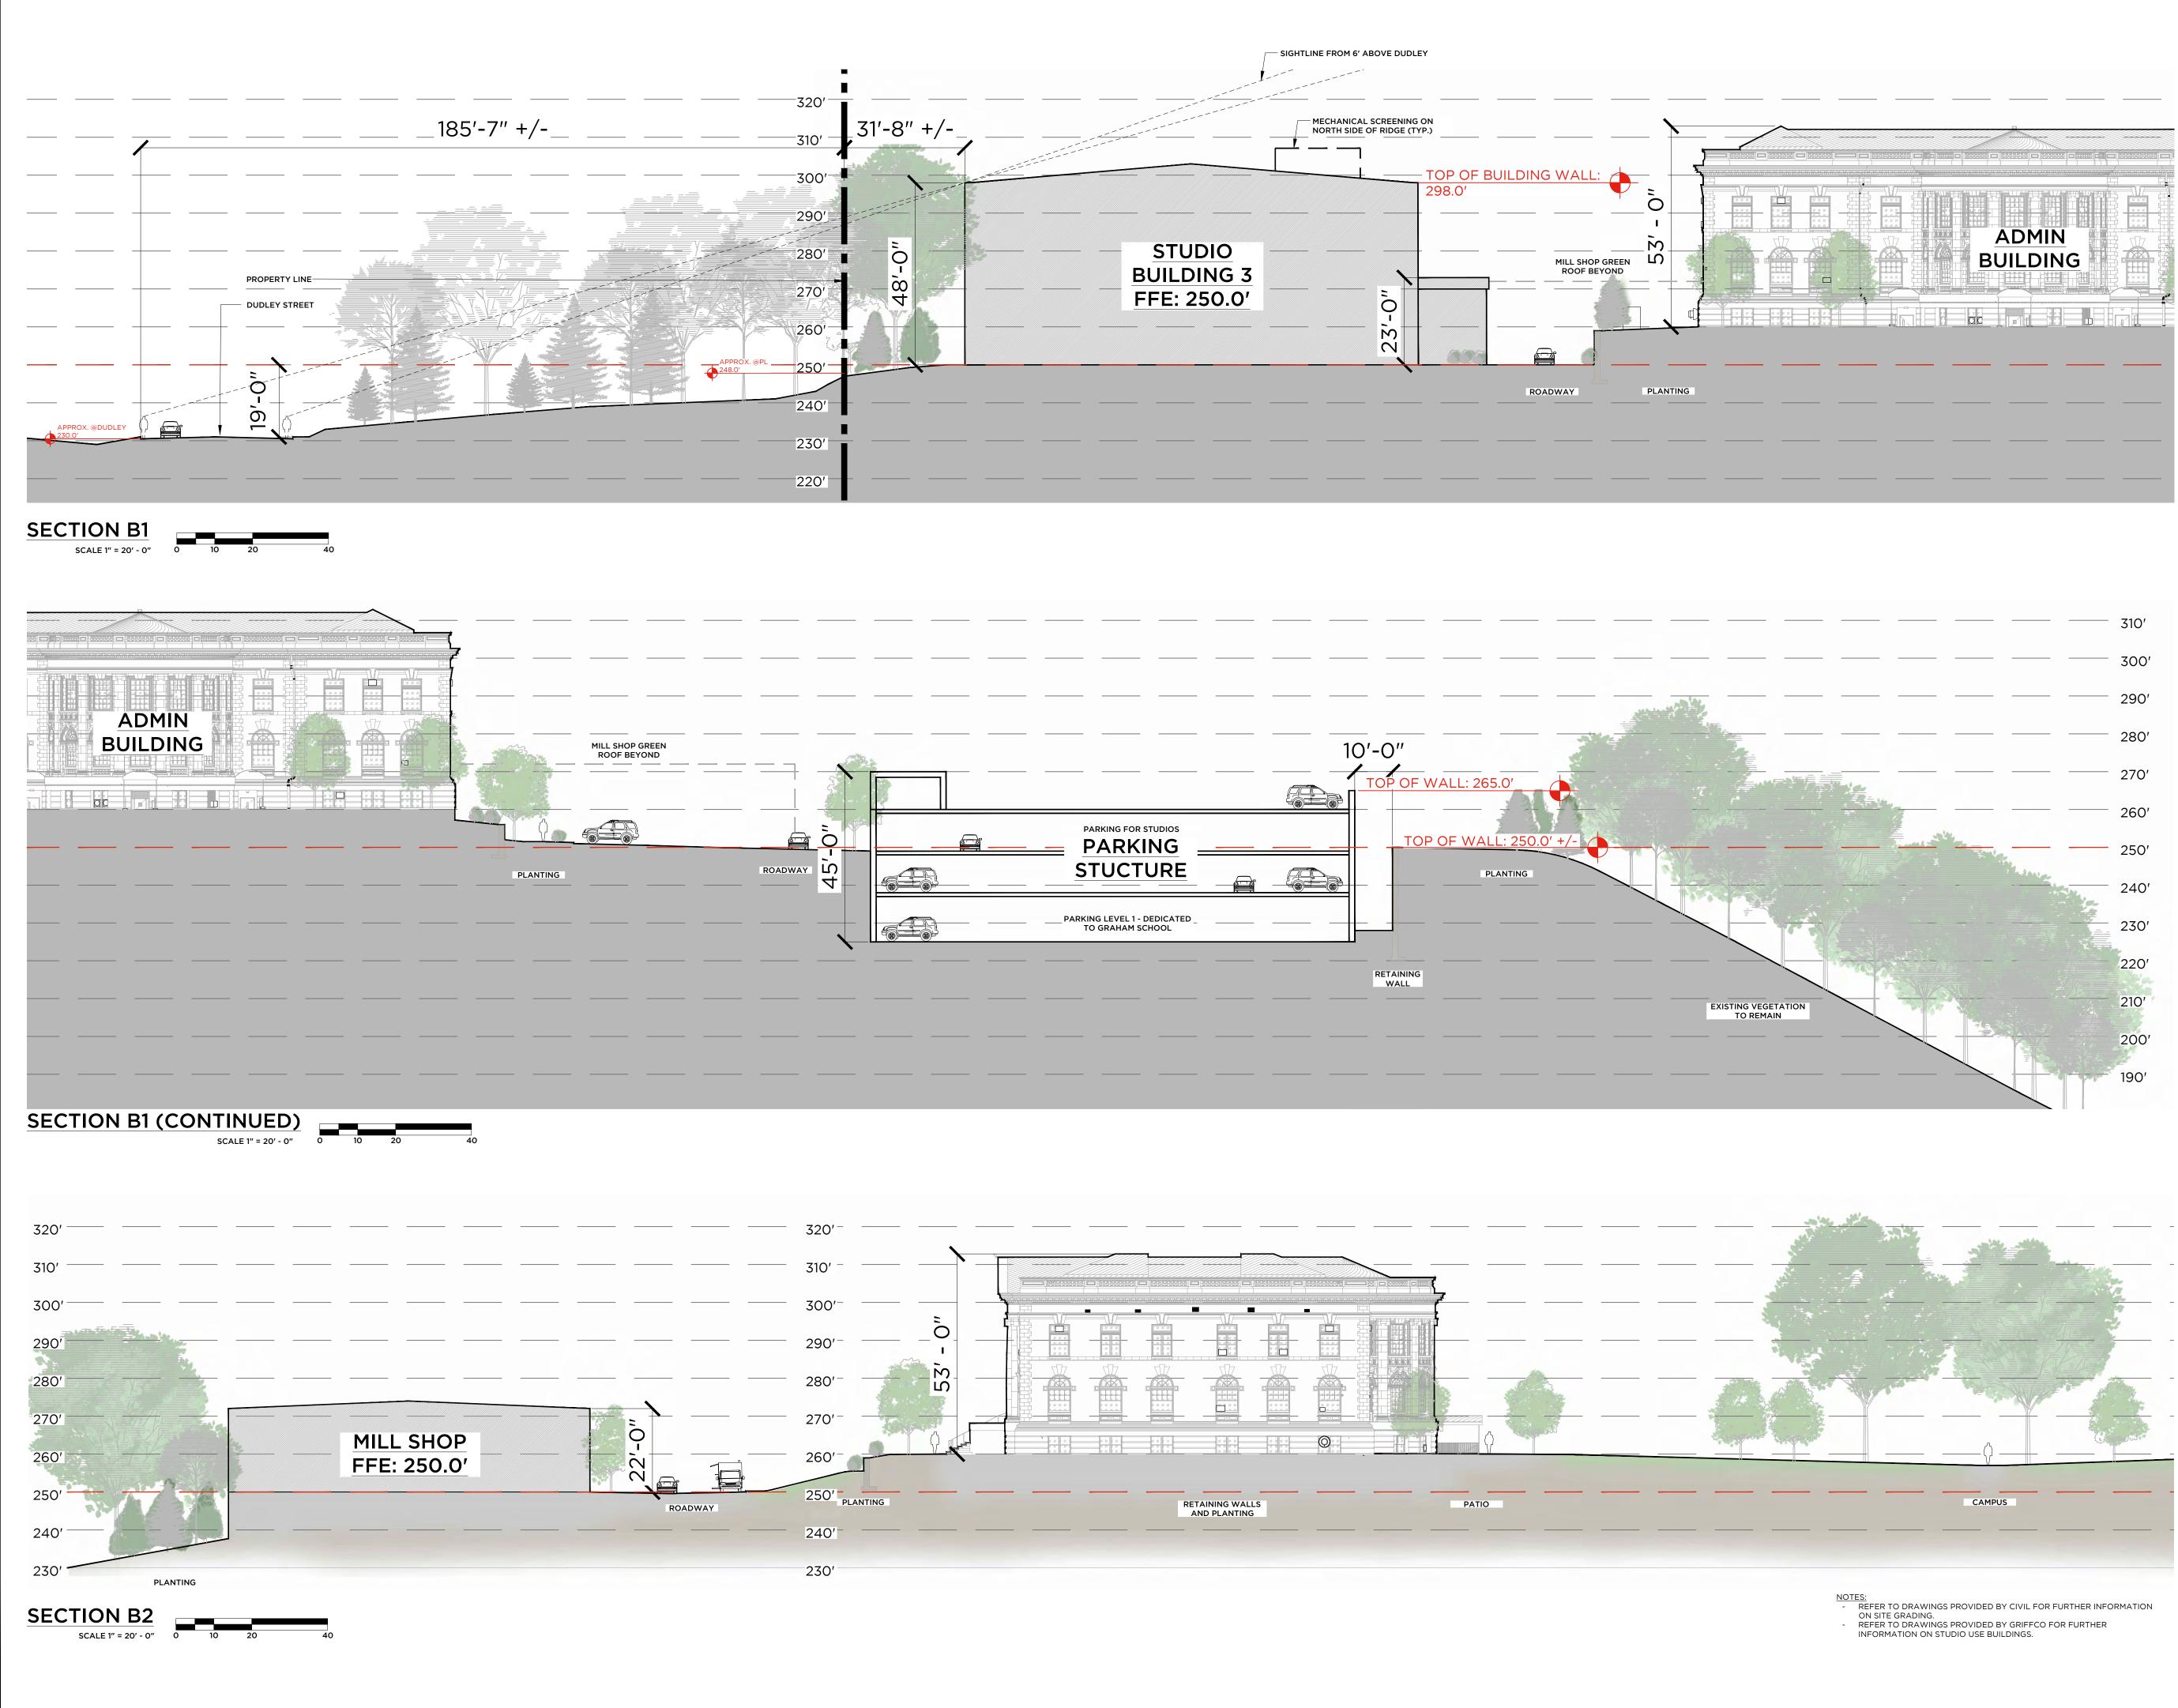

ric owl studios 23003/06 Construction Drawings/02 CD Landscape Architecture/BASE DRAWINGS/ EOS LAR dwg
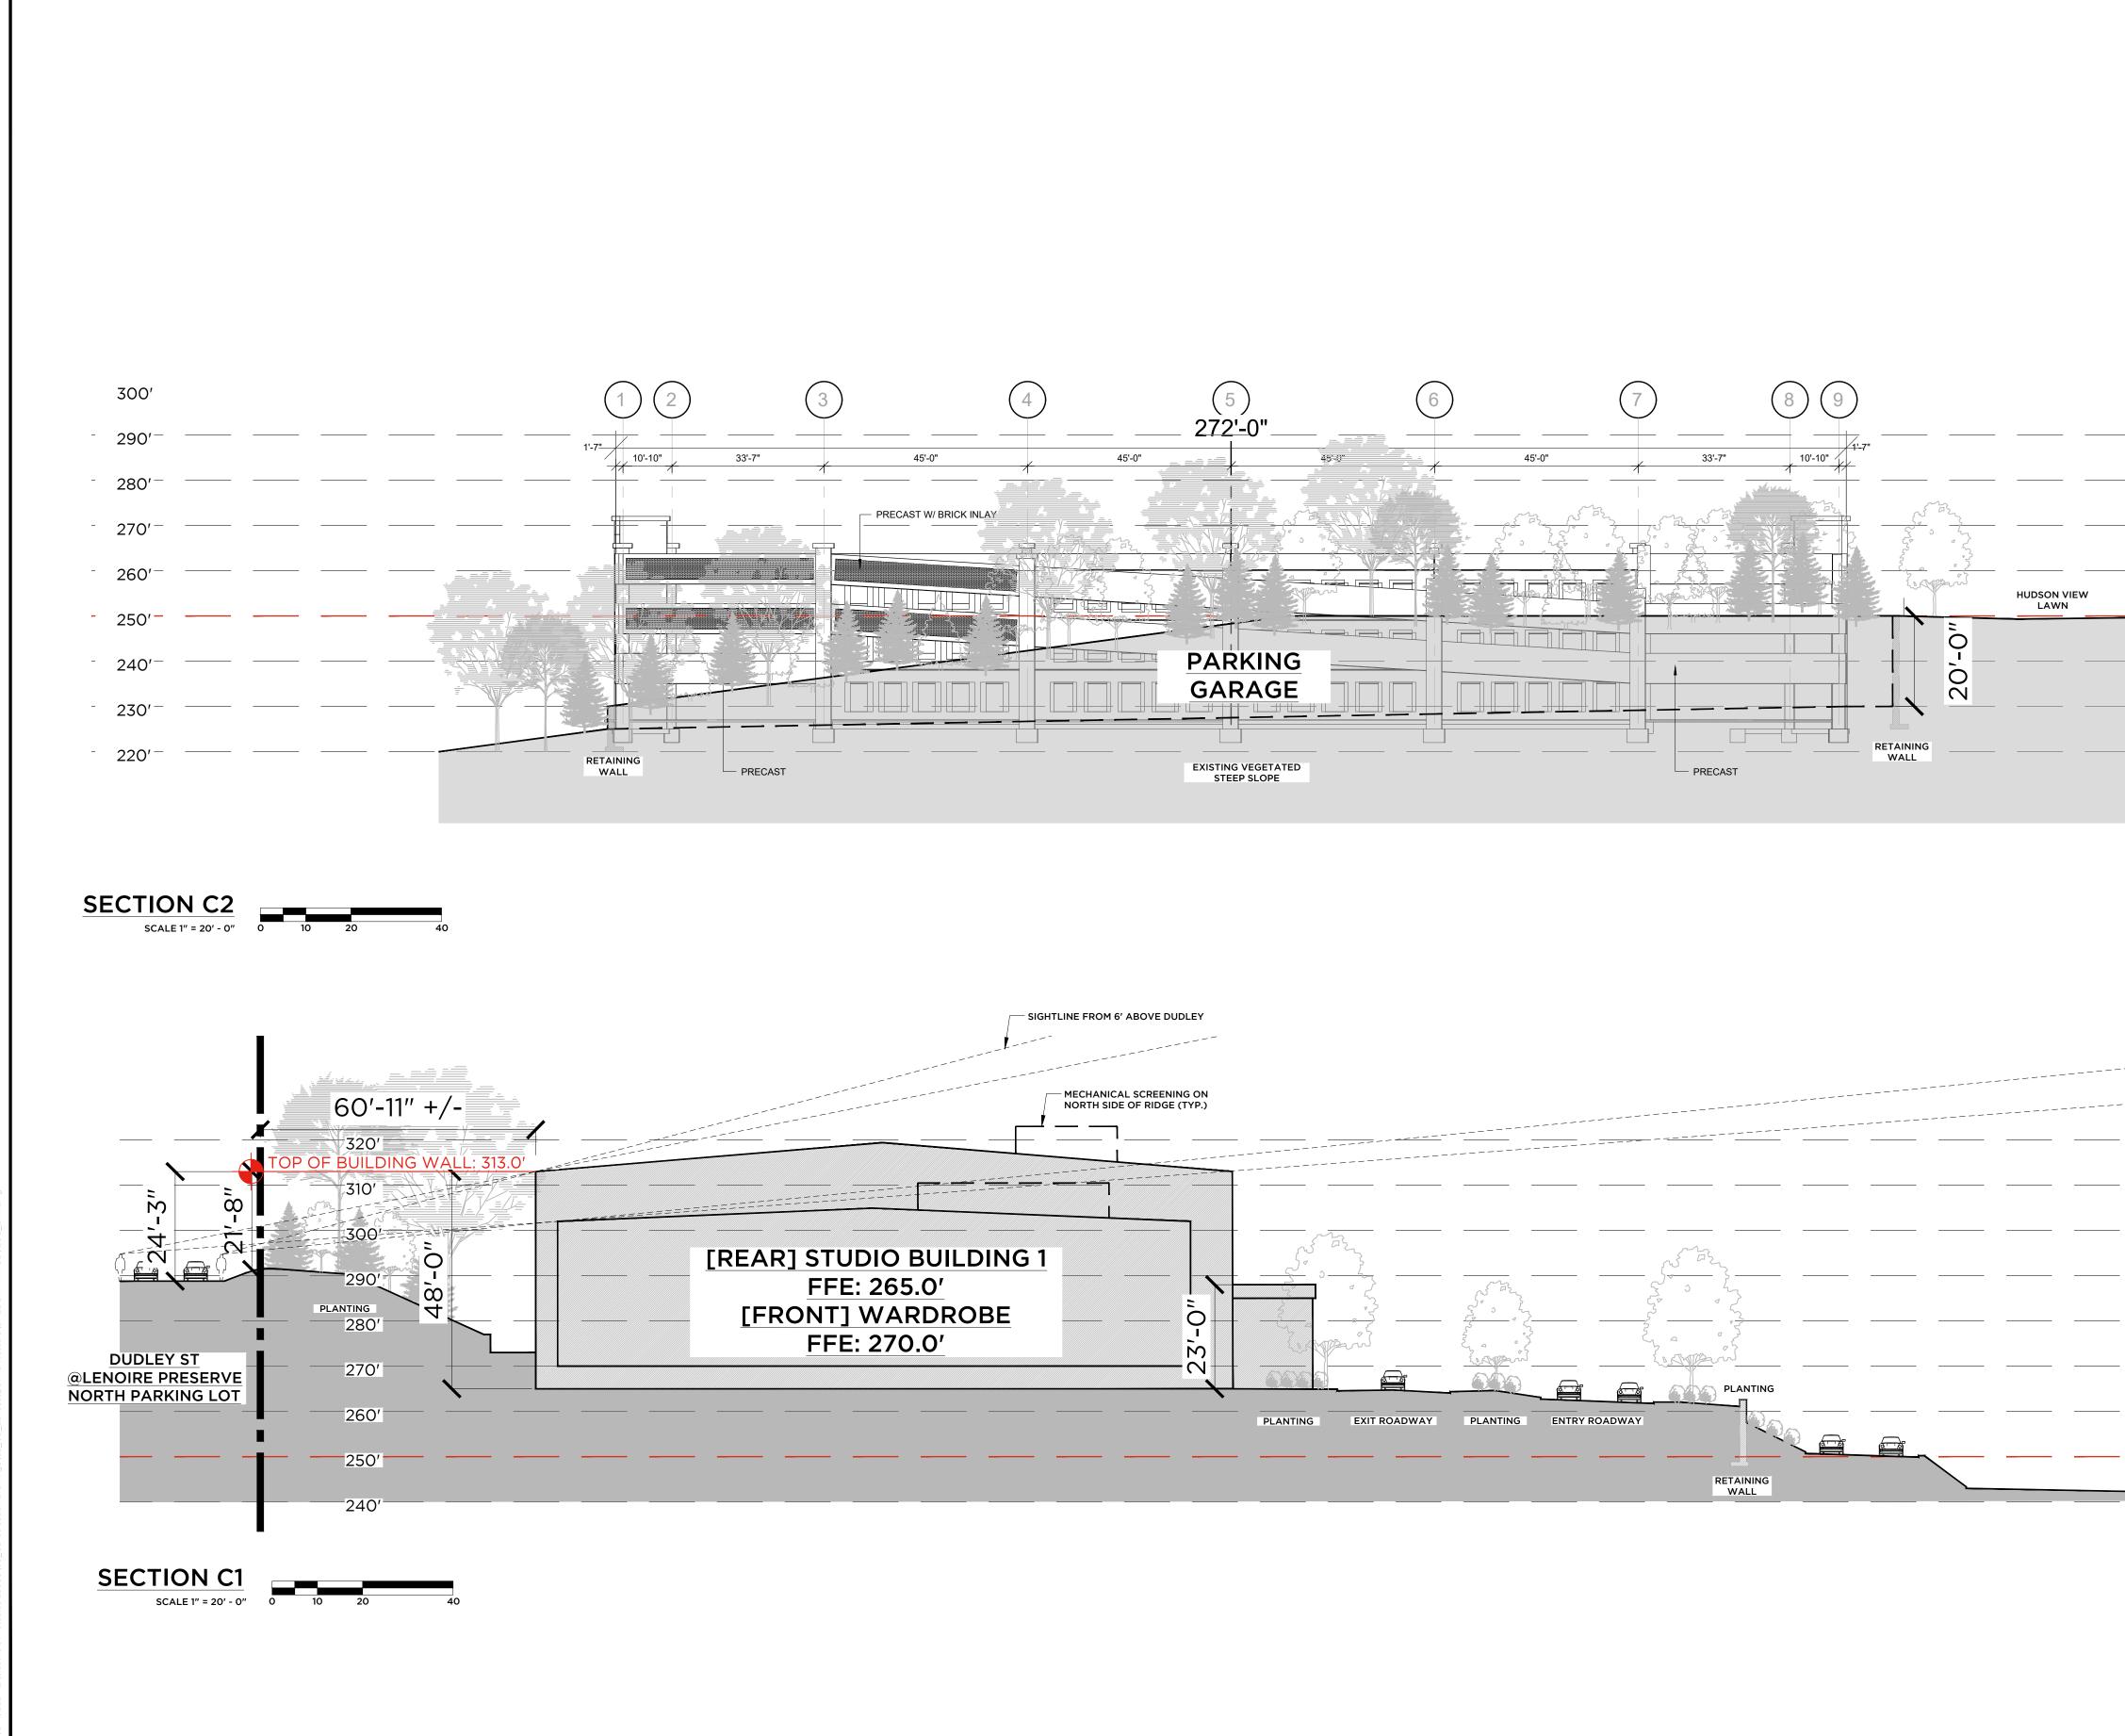
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Green Roof: **NEW YORK GREEN ROOFS** 63 MEADOW ST BROOKLYN, NY, 11206 TEL: (917) 680-6881

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PROJECT NAME ELECTRIC OWL STUDIOS

1 S BROADWAY	

HASTINGS	ON HUDSON, N'	Y		
JOB NO.:	23003			
DRAWN BY	: JS	PROJ. MA	NAGER: AS	
DATE:	02/07/24	SCALE:	AS NOTED	
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SECTIONS C

DRAWING NO.



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300'

290' —

280' —

270′ — ____

260'— —

250′ — —

240′ —


230′ — —


220' — —

GRAHAM SCHOOL SURFACE PARKING

 NOTES:

 REFER TO DRAWINGS PROVIDED BY CIVIL FOR FURTHER INFORMATION ON SITE GRADING.
 REFER TO DRAWINGS PROVIDED BY GRIFFCO FOR FURTHER INFORMATION ON STUDIO USE BUILDINGS.

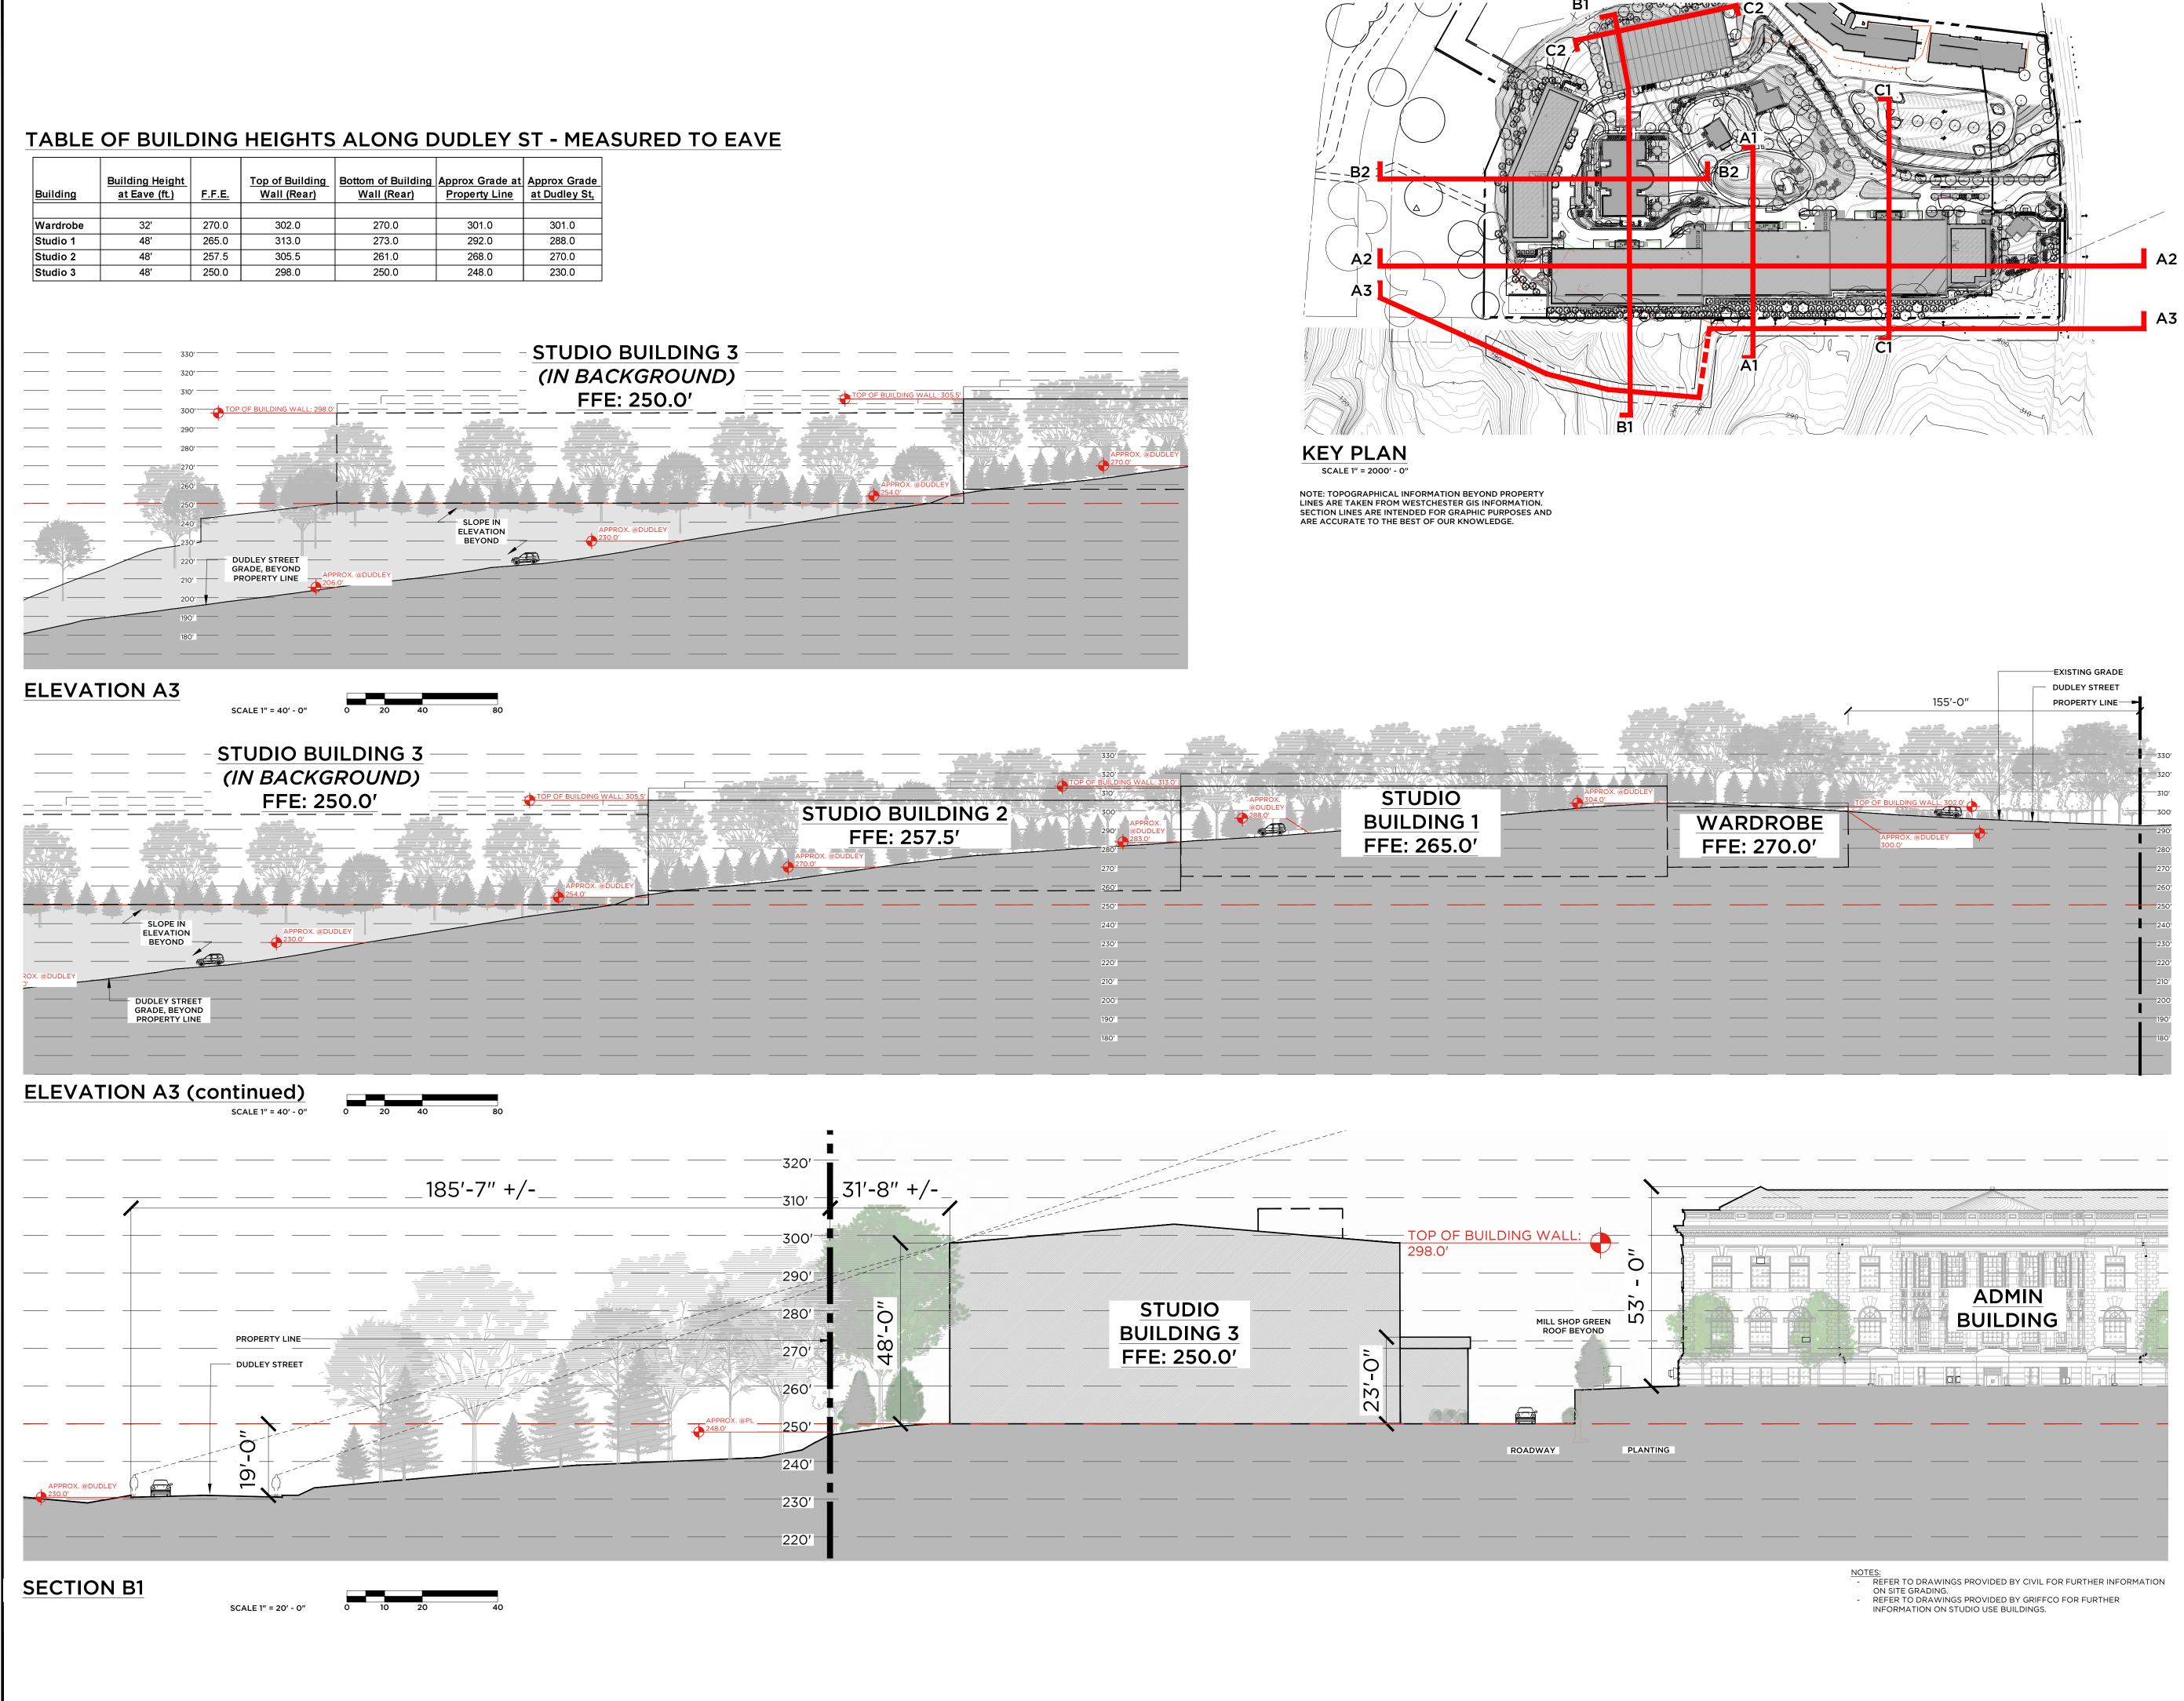

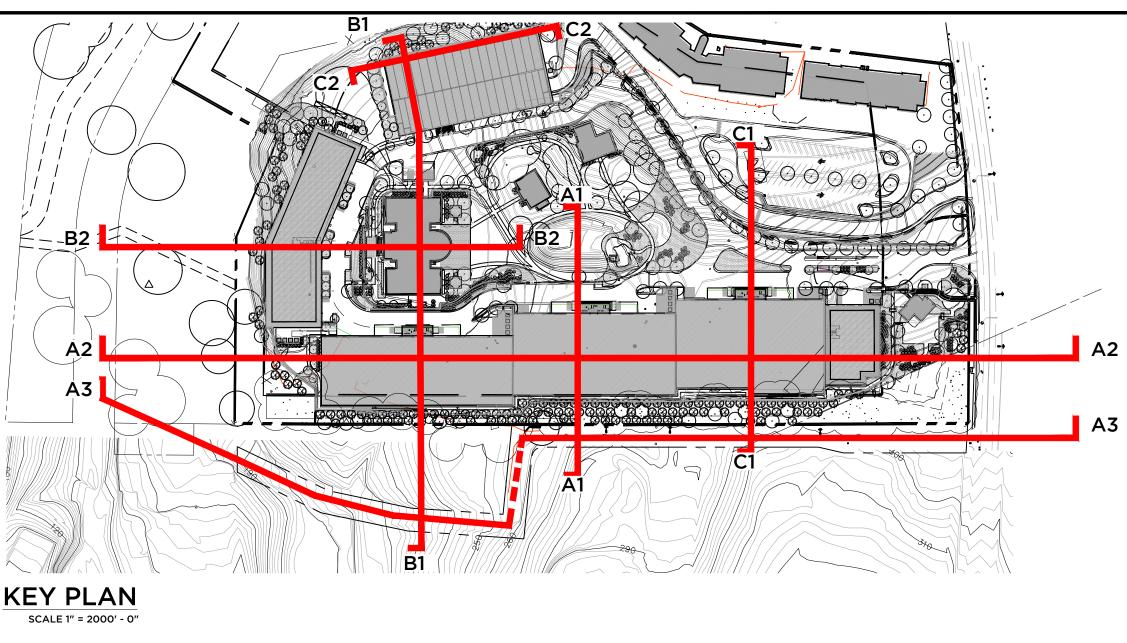





330 RAILROAD AVENUE GREENWICH, CT 06830 203.625.9460

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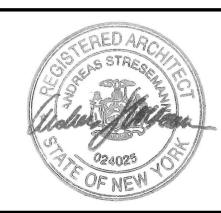
Architect: GRANOFF ARCHITECTS 330 RAILROAD AVENUE GREENWICH, CT 06830 TEL: (203) 625-9460

Green Roof: NEW YORK GREEN ROOFS 63 MEADOW ST BROOKLYN, NY, 11206 TEL: (917) 680-6881

REVISIONS

#	DATE	REVISION DESCRIPTION	BY:
-			

PHASE NOT FOR CONSTRUCTION



PROJECT NAME **ELECTRIC OWL STUDIOS**

1 S BROADWAY	

HASTINGS	ON HUDSON, NY
	23003


JOB NO.:	23003			
DRAWN BY: JS		PROJ. MANAGER: AS		
DATE:	02/07/24	SCALE:	AS NOTED	

SECTIONS SK1

DRAWING TITLE

DRAWING NO.



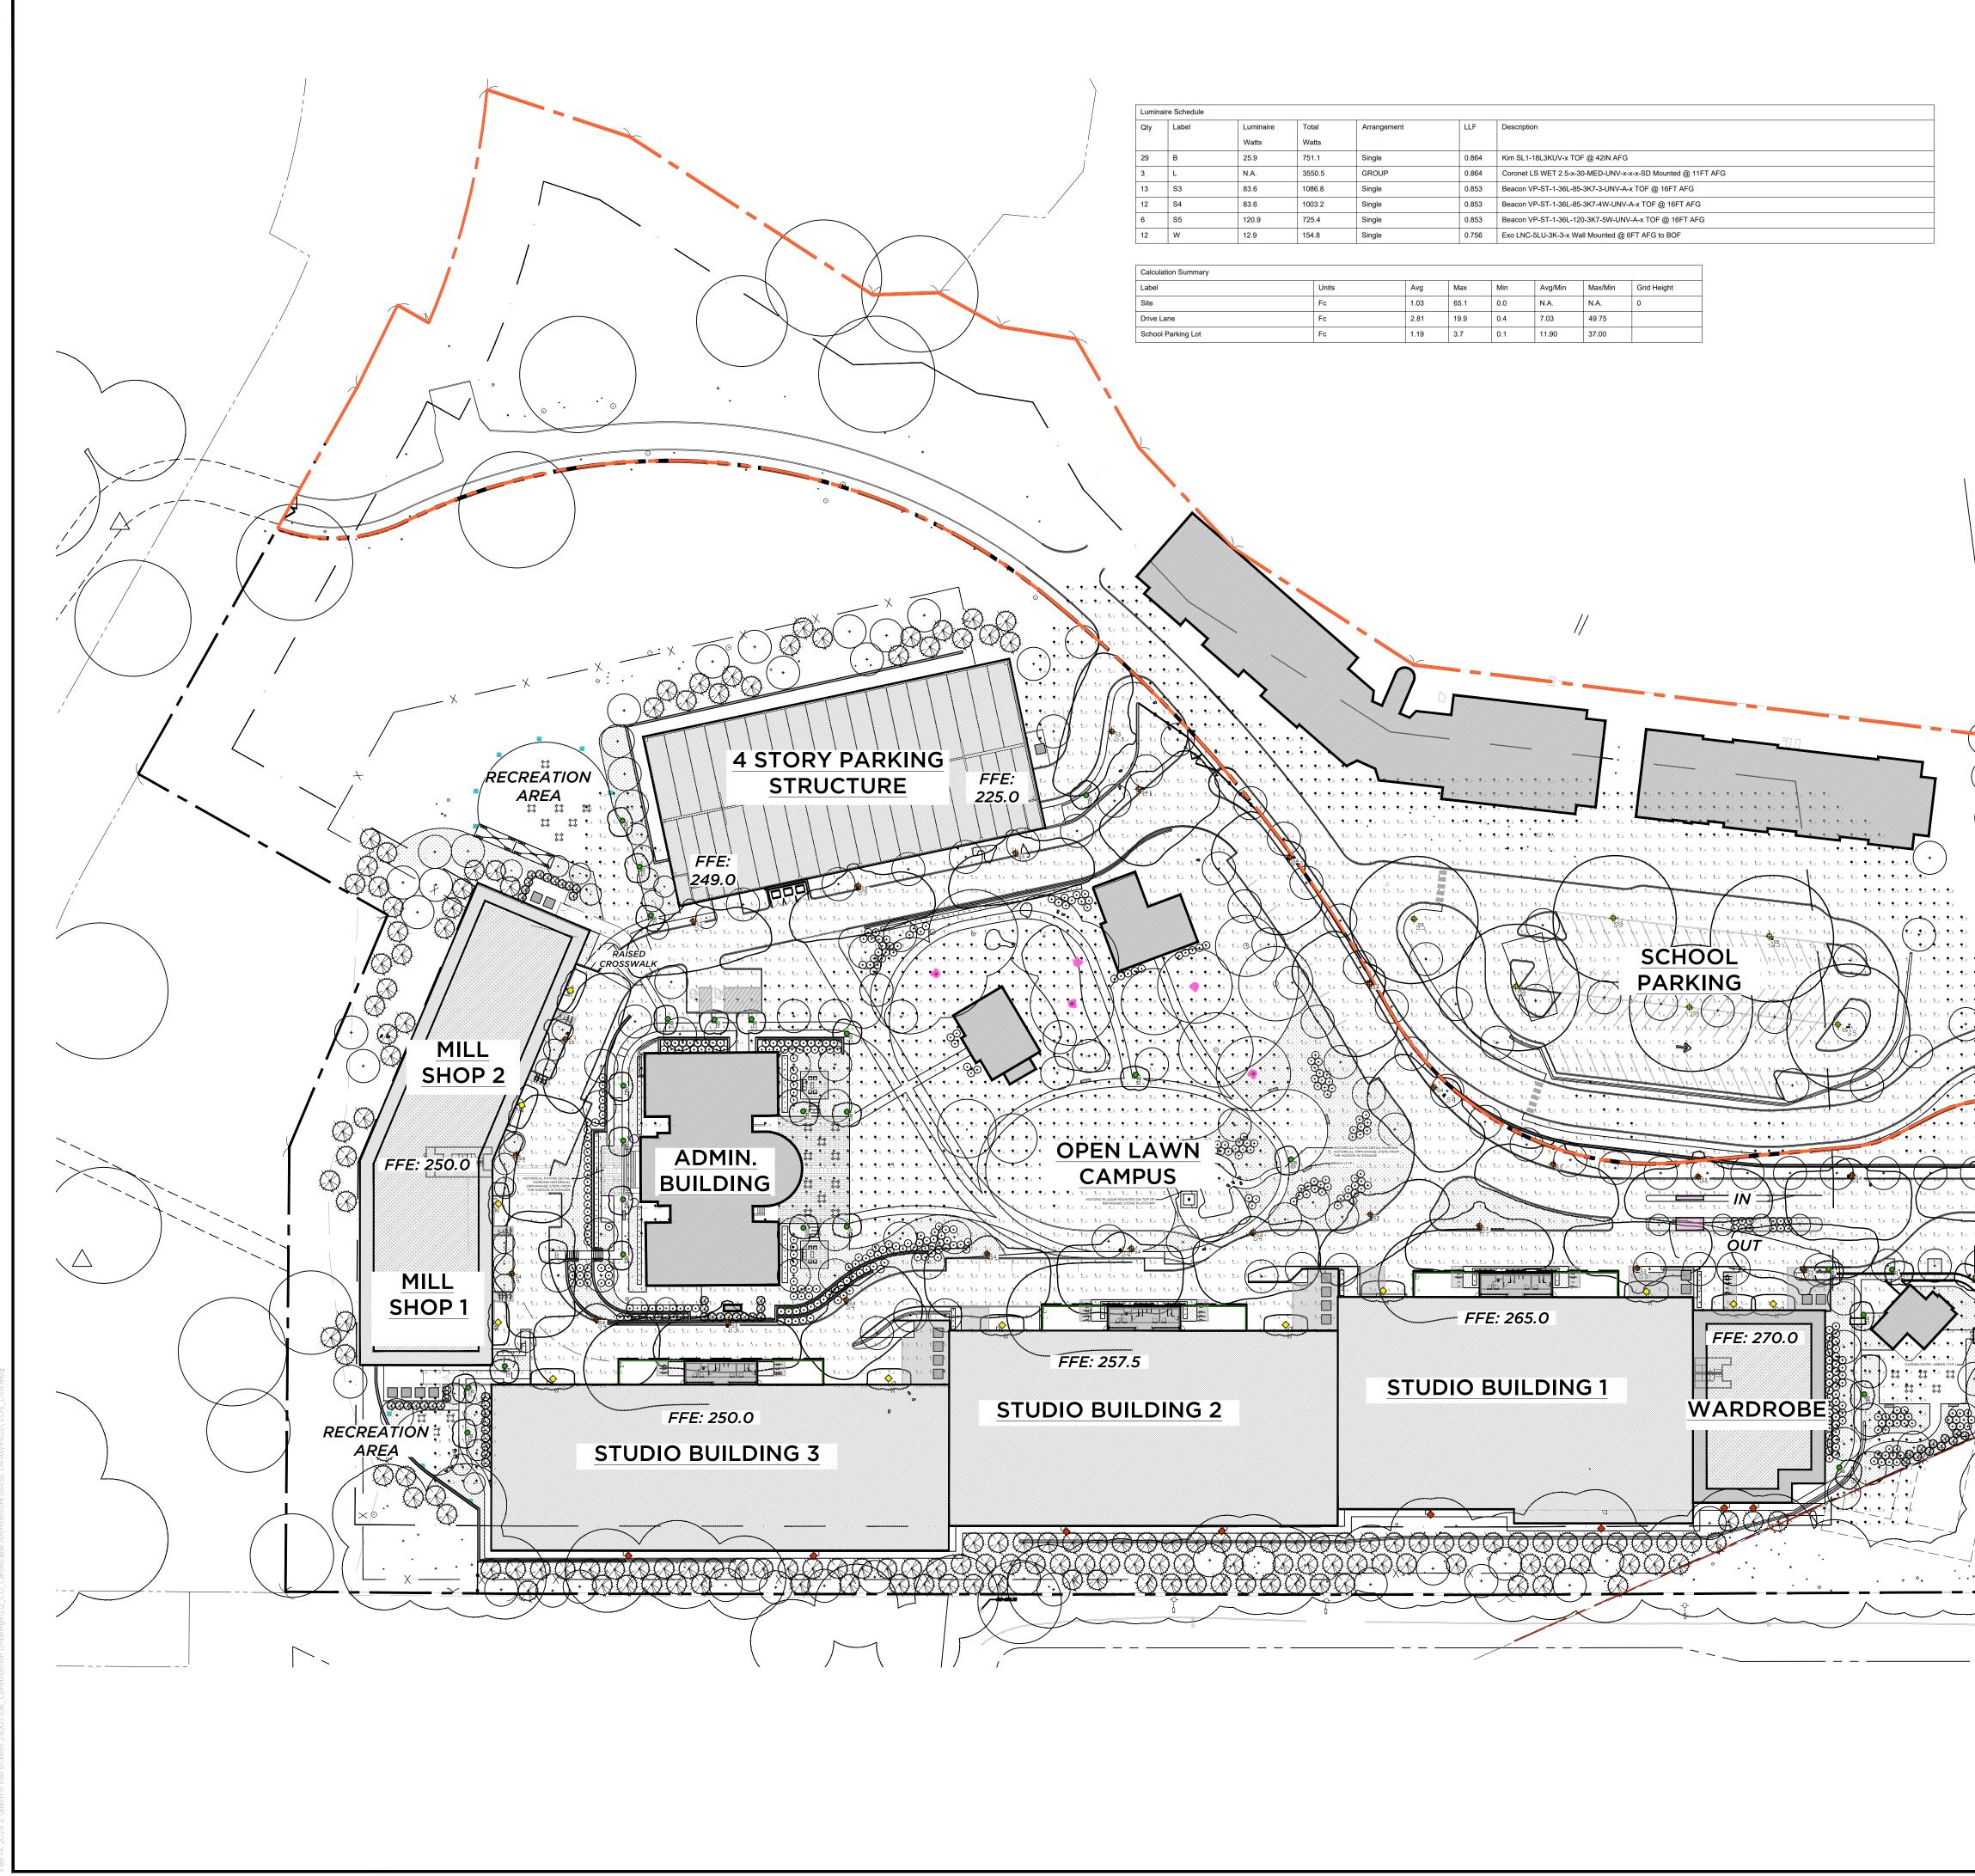

LIGHTING KEY

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• • • • •

. 9.0 9.0 9

₱s PARKING LOT POLE LIGHT

- -**Ф**53 ROADWAY/PEDESTRIAN POLE LIGHT
- BOLLARD LIGHT
- TREE MOUNTED DOWN LIGHT
- BUILDING MOUNTED DOWN LIGHT • BUILDING MOUNTED EMERGENCY LIGHT
- —— OVERHANG LED STRIP LIGHTING WALL MOUNTED STEP LIGHT
- WALL MOUNTED PIER LIGHT
- SIGN FLOOD LIGHT
- LANDSCAPE BED LIGHTS



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Green Roof: NEW YORK GREEN ROOFS 63 MEADOW ST BROOKLYN, NY, 11206 TEL: (917) 680-6881




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REVISIONS

	1		
#	DATE	REVISION DESCRIPTION	BY:
	1	1	·

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PROJECT NAME ELECTRIC OWL STUDIOS

1 S BROAD HASTINGS	WAY ON HUDSON, N	Υ	
JOB NO.:	23003		
DRAWN BY	/: JS	PROJ. MA	NAGER: AS
DATE:	02/07/24	SCALE:	AS NOTED

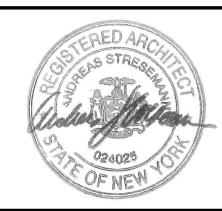PHOTOMETRICS - SITE LIGHTING

DRAWING NO.



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North

.1 0.1 0.0 0.0 0.0 0 .2 0.1 0.0 0.0 0.0 0.0 5.1 9.0 9.0 9.0 9 bii 8.0 8.0 8.0 8


SCALE 1" = 60' - 0"


Reflectances: Ceiling: 30% Walls: 30% Floor: 20%

Lumir	aire Schedule																					
Qty	Label	Luminaire	Total	Arr	rangement	LLF	Descrip	tion														
		Watts	Watts																			
8	F1	22.6	180.8	Sir	ngle	0.900	SRI1-2	0-3K7-5QW-UN	V													
Calau	lation Common																					
Label	lation Summary		Ur	nits	Avg	Max	Min	Avg/Min	Max/Min	Grid Height												
	lation @ Floor		Fc		0.57	5.6	0.0	N.A.	N.A.	0												
					I																	
0.0	0.0	0.1	0.2	0.2	⁺ 0.2	⁺ 0.1	0.0	0.0	0.1	0.2	0.2	0.2	$\overset{\scriptscriptstyle +}{0}$.1	⁺ 0.1	⁺ 0.0	0.1	0.1	0.2	0.2	0.1	0.1	0.0
+	+ 1	+	+ 7	+ 1	⁺ 0.6	+	+ 1	+ 1	0.2	0.6	+ 1	⁺ 0.8	+	⁺ 0.1	+ 1	+ 1	+	+	+ 0	+	+ 1	+
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⁺ 0.1	⁺ 0.1	⁺ 0.4	⁺ 2.5	÷5.5	⁺ 1.8	⁺ 0.3	⁺ 0.1	⁺ 0.1	⁺ 0.3	⁺ 1.5	⁺ 5.2	⁺ 2.9	⁺ 0.5	⁺ 0.1	⁺ 0.1	⁺ 0.2	⁺ 0.9	⁺ 4.2	4.2	⁺ 0.9	⁺ 0.2	⁺ 0.1
				⊙ 1							0							⊙ _	- 1			
				Ŀ'⊥							上'上							ł	!'⊥			
⁺ 0 - 2	⁺ 0.2	++ 	2.1	4.8	1.5	⁺ 0.3	0.1	⁺ 0.1	⁺ 0.3	1.3	4.6	2.4	⁺ 0.5	⁺ 0.1	⁺ 0.1	⁺ 0.2	⁺ 0.8	⁺ 3.4	⁺ 3.4	÷0.8	0.2	⁺ 0.1
+	0.3	+	+	+	+	+	+	+	+	+	+	+	+	+	+	+	+	+	+	+	+	+
0.1	0.3	0.8	0.9	0.5	0.5	0.2	0.1	0.1	0.2	0.4	0.8	0.6	0.2	0.1	0.1	0.1	0.3	0./	0./	0.3	0.1	0.0
$^+$ 011	0.6	+ 3.1	4.7	+ 3	⁺ θ - 2	+ 0 - 1	+ 0 . 1	+ 0 . 1	+ 0.1	+ 0.2	$^{+}$ 0 - 2	$^{+}_{0}$ 2	+ 1	+ 1	+0.1	+0.1	⁺ 0 - 1	+ 2	+ 2	+ 1	$^{+}_{0,1}$	$\stackrel{+}{0}$
	⁺ 0.6		• • • •	±•••																		
	⁺ 0.6 ⁺ 0.3		F1																			
⁺ 0 .1	⁺ 0.6	⁺ 3.0	4.6	1.3	0.2	⁺ 0.1	$\overset{\scriptscriptstyle +}{0}$.1	⁺ 0.1	0.1	0.2	0.2	⁺ 0.2	⁺ 0.1	⁺ 0.1	⁺ 0.1	⁺ 0.1	[†] 0.1	0.2	0.2	0.1	⁺ 0.1	[†] 0.0
+	+	+	+	+		+	+	+	+	+	+	+	+	+	+	+ .	+	+	+	+	+	+
0.1	0.3	0.7	0.9	0.4	0.5	0.2	0.1	0.1	0.2	0.4	0.8	0.6	0.2	0.1	0.1	0.1	0.3	0.7	0.7	0.3	0.1	0.0
		/ //																				
+01	0.2	⁺ 0 4	+ 2 1	+ 4 9	+ 1 6	+ 0 3	+ 0 1	+ 0 1	+ 0 3	+ 1 3	⁺ 4 7	+ 2 5	+ 0 5	+ 0 1	+ 0 1	⁺ 0 2	+ 0 8	+ ר ה	+ 、 「	+ 0 8	+ 0 2	+ 0 1
			∠ • ⊥	1.5	Τ•Ο	0.0	0.1	0.1	0.0	±•0	· • <i>i</i>	2.0	0.0	0.1	0.1	0.2	0.0	5.5	0.0	0.0	0.2	0.1
				© ਸ1							⊙ ਸ1							© ⊺	7 1			
	⁺ 0 • 1	0.4	⁺ 2.5	±± 5.6	1.8 ⁺	⁺ 0.3	⁺ 0.1	⁺ 0.1	⁺ 0.3	1.5	5.2 ⁺	⁺ 2.9	⁺ 0.5	⁺ 0.1	⁺ 0.1	⁺ 0.2	⁺ 0.9	⁺ 4.2	4.2	⁺ 0.9	⁺ 0.2	⁺ 0.1
	+		+	. I	+	+	+	 _	+	₊	+	+	+	+	+	+	+	+	_	+	+ I	+ I
		0.2	0.7	1.1	0.6	0.2	0.1	0.1	0.2	0.5	1.1	0.8	0.3	0.1	0.1	0.1	0.4	1.0	1.0	0.4	0.1	0.0
	+	4	+ 2	+	+	+ 1	+	+	+ 1	+ 2	+ 2	+ 2	+	+ 1	+	+ 1	+ 1	+ 2	+ 2	+ 1	+ 1	+
	+0 1 +0 0		0.2	U . Z		U • 1	••0	0.0		0.2	0.2	∪.∠			0.0	♥•⊥	0.1		0.2	U. 1	U • 1	0.0

Lumina	aire Schedule																					
Qty	Label	Luminaire	Total	A	Arrangement	LLF	Descri	iption														
		Watts	Watts						n /													
8	F1	22.6	180.8		Single	0.900	SRI1-	-20-3K7-5QW-UN	NV													
Calcul	ation Summary																					
Label				Units	Avg	Max	Min	Avg/Min	Max/Min	Grid Height												
	ation @ Floor			Fc	0.57		0.0	N.A.	N.A.	0												
			.		_	_		L			.	_	.									т
0.0	0.0	0.1	0.2	0.2	0.2	⁺ 0.1	0.0	0.0	0.1	0.2	0.2	⁺ 0.2	0.1	⁺ 0.1	0.0	0.1	0.1	0.2	0.2	⁺ 0.1	0.1	0.
	1, 1, 1, 1, 1, 1, 1, 1, 1, 1, 1, 1, 1, 1	+	+	+	+	+	+	+	+	+	+	+	+	+	+	+	+	+	+ 0	+	+	+
J • 0	9 • <u>Y</u>	0.31	0./	⊥.⊥	0.6	⁺ 0.2	0.1	0.1	0.2	0.6	⊥.⊥	0.8	0.8	0.1	0∎.⊥	\mathbb{O} . L	∎0.4	∎⊥.0	1.0	0.4	0.1	0.1
$\begin{array}{c c} + \\ 0 \\ 1 \end{array}$	+ 0 1	⁺ 0.4	⁺ 2.5	÷5.5	1.8	⁺ 0.3	⁺ 0.1	⁺ 0.1	⁺ 0.3	⁺ 1.5	÷ 5.2	⁺ 2.9	⁺ 0.5	⁺ 0.1	⁺ 0.1	⁺ 0.2	⁺ 0.9	⁺ 4.2	⁺ 4.2	⁺ 0.9	⁺ 0.2	+
	0.1		2.0	o	±•0	0.0	0.1	• • ±	0.0	±•0	0 0	2.9	0.0	0.1	0.1	••2	0.5	<u>۰</u>	1 • <i>C</i>	0.9	0.2	0.
				F1							F1]	-1			
⁺ 0 <mark>.</mark> 2	⁺ 0.2	⁺ 0.4	⁺ 2.1	⁺ 4.8	1.5	⁺ 0.3	⁺ 0.1	⁺ 0.1	⁺ 0.3	⁺ 1.3	⁺ 4.6	2.4	⁺ 0.5	⁺ 0.1	⁺ 0.1	⁺ 0.2	⁺ 0.8	⁺ 3.4	⁺ 3.4	⁺ 0.8	0.2	+ 0 . 1
⊢	⁺ 0.3	+	+	+	+	+	+	+	+	+	+	+	+	+	+	+	+	+	+	+	+	+
0.1	0.3	0.8	0.9	0.5	0.5	0.2	0.1	0.1	0.2	0.4	0.8	0.6	0.2	0.1	0.1	0.1	0.3	0.7	0.7	0.3	0.1	0.0
+	+	+ 1	+	+ 2	*	+ 1	+ 1	+ 1	+ 1	+ 2	+	+	+ 1	+ 1	+ 1	+ 1	+ 1	+	+ 2	+ 1	+ 1	+
	⁺ 0.6	3.1	4./	1.3	• C	0.1	0.1	0.1	0.1	0.2	0.2	0.2	0.1	0.1	0.1	0.1	0.1	0.2	0.2	0.1	0.1	0.0
			-																			
[†] 0.1	⁺ 0.6	⁺ 3.0	4.6	⁺ 1.3	0.2	⁺ 0.1	⁺ 0.1	⁺ 0.1	0.1	0.2	0.2	⁺ 0.2	⁺ 0.1	⁺ 0.1	⁺ 0.1	+ 0.1	[†] 0.1	0.2	0.2	⁺ 0.1	⁺ 0.1	+ 0.1
	⁺ 0.3																					
0.1	⁺ 0.3	⁺ 0.7	⁺ 0.9	⁺ 0.4	0.5	0.2	⁺ 0.1	[†] 0.1	0.2	0.4	0.8	⁺ 0.6	⁺ 0.2	⁺ 0.1	⁺ 0.1	[†] 0.1	[†] 0.3	0.7	0.7	0.3	0.1	⁺ 0.(
						1								1	1	1						
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0.1	0.2	0.4	2.1	4.9	⊥.6	0.3	0.1	0.1	0.3	1.3	4./	2.5	0.5	0.1	0.1	0.2	0.8	3.5	3.5	0.8	0.2	0.
				⊙ 1							©							Ø	- 1			
	$\stackrel{+}{0}$	+	⁺ 2.5	₽'⊥ 5.6	1.8	+ 0 - 3	+ 0 _ 1	+ 0 _ 1	⁺ 0 - 3	+ 1 . 5	+ ±'⊥	+2.9	+ 0 . 5	+ 0 _ 1	+ 0 _ 1	+ 0 - 2	+ 0 - 9	4 . 2	±'⊥ ₊ 4.2	+ 0 - 9	⁺ 0 - 2	+ 0 . ·
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	+0 1 +0 0					1	1	1	1				1	1	1	I	1		1			
	ŤO I	*0.2	⁺ 0.7	$^{\scriptscriptstyle +}$ 1.1	⁺ 0.6	⁺ 0.2	⁺ 0.1	⁺ 0.1	0.2	⁺ 0.5	1.1	⁺ 0.8	⁺ 0.3	⁺ 0.1	⁺ 0.1	⁺ 0.1	⁺ 0.4	1.0	⁺ 1.0	⁺ 0.4	⁺ 0.1	⁺ 0 . (
	+		_	_	+	+	+	L_	_+		_	_	+	+	+	+	Ļ	+	+	+	+	+
	0	0.1	0.2	0.2	0.2	0.1	0.0	0.0	0.1	0.2	0.2	0.2	0.1	0.1	0.0	0.1	0.1	0.2	0.2	0.1	0.1	0.0

LVL1-SCHOOL PARKING

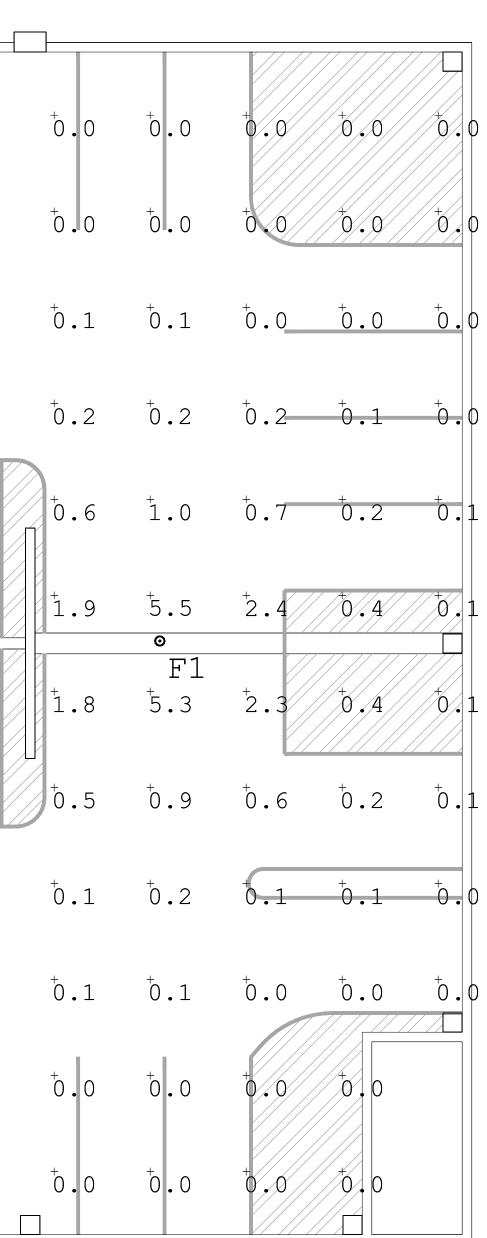

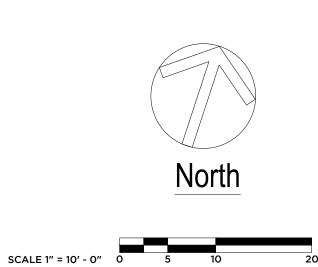

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REVISIONS									
#	DATE	REVISION DESCRIPTION	BY:						

PHASE NOT FOR CONSTRUCTION



PROJECT NAME ELECTRIC OWL STUDIOS

1 S BROAD HASTINGS	WAY ON HUDSON, N	١Y	
JOB NO.:	23003		
DRAWN BY	/: JS	PROJ. MA	ANAGER: AS
DATE:	02/07/24	SCALE:	AS NOTED
DRAWING	TITLE		
РНОТО	METRICS	- GARA	GE RCP


LVL 1


DRAWING NO.



				<u> </u>								[
⁺ 0.0 ⁺ 0.1	⁺ 0.3	⁺ 0.7	⁺ 1.1	⁺ 0.6	°.2	0.1	⁺ 0.1	0.2	⁺ 0.6	1.1	⁺ 0.8	⁺ 0.3	⁺ 0.1	⁺ 0.1	0.1	⁺ 0.4	1.0	⁺ 1.0	0.4	⁺ 0.1	[†] 0.0
	<u> </u>	⁺ 2.5	[⁺] 5.5 ⊙ F1	1.8 ⁺	⁺ 0.3	⁺ 0.1	⁺ 0.1	⁺ 0. 3		2 RAM F1	1₽́2U⁄₽	⁺ 0.5	⁺ 0.1	⁺ 0.1	⁺ 0.2	⁺ 0.9	⁴.2 ●	4.2 1	⁺ 0.9	⁺ 0.2	0.1
⁺ 0.2 ⁺ 0.2	⁺ 0.4	2.1	⁺ 4.8	1.5	⁺ 0.3	⁺ 0.1	⁺ 0.1	⁺ 0.3	1.3	⁺ 4.6	⁺ 2.4	⁺ 0.5	⁺ 0.1	⁺ 0.1	⁺ 0.2	⁺ 0.8	⁺ 3.4	⁺ 3.4	⁺ 0.8	⁺ 0.2	0.1
⁺ 0.1 ⁺ 0.3																					
⁺ 0.1 ⁺ 0.6	3.1	⁺ 4.7	1.3	0.2	⁺ 0.1	⁺ 0.1	⁺ 0.1	⁺ 0.1	⁺ 0.2	⁺ 0.2	⁺ 0.2	⁺ 0.1	0.2	⁺ 0.2	⁺ 0.1	[†] 0.1	0.0				
⁺ 0.1 ⁺ 0.6									1	I I											
⁺ 0.1 ⁺ 0.3	⁺ 0.7	⁺ 0.9	0.4	0.5	⁺ 0.2	⁺ 0.1	⁺ 0.1	⁺ 0.2	0.4	⁺ 0.8	⁺ 0.6	⁺ 0.2	⁺ 0.1	⁺ 0.1	⁺ 0.1	⁺ 0.3	⁺ 0.7	⁺ 0.7	⁺ 0.3	[†] 0.1	[†] 0.0
⁺ 0.1 ⁺ 0.2	0.4	⁺ 2.1	⁺ 4.9	1.6	⁺ 0.3	⁺ 0.1	⁺ 0.1	⁺ 0.3	⁺ 1.3	⁺ 4.7	⁺ 2.5	⁺ 0.5	⁺ 0.1	⁺ 0.1	⁺ 0.2	⁺ 0.8	⁺ 3.5	⁺ 3.5	⁺ 0.8	⁺ 0.2	⁺ 0.1
	0.4	⁺ 2.5	⊙ F1 5.6	⁺ 1.8	⁺ 0.3	⁺ 0.1	⁺ 0.1	⁺ 0.3	⁺ 1.5	● - 5.2	⁺ 2.9	⁺ 0.5	⁺ 0.1	⁺ 0.1	⁺ 0.2	⁺ 0.9	● 4.2	71 ₊ 4.2	⁺ 0.9	⁺ 0.2	⁺ 0.1
	0.2																				
	0.1	⁺ 0.2	⁺ 0.2	[†] 0.2	0.1	⁺ 0.0	[†] 0.0	0.1	⁺ 0.2	⁺ 0.2	⁺ 0.2	⁺ 0.1	[†] 0.1	⁺ 0.0	0.1	0.1	[†] 0.2	⁺ 0.2	⁺ 0.1	⁺ 0.1	⁺ 0.0

LVL 2 - STUDIO PARKING

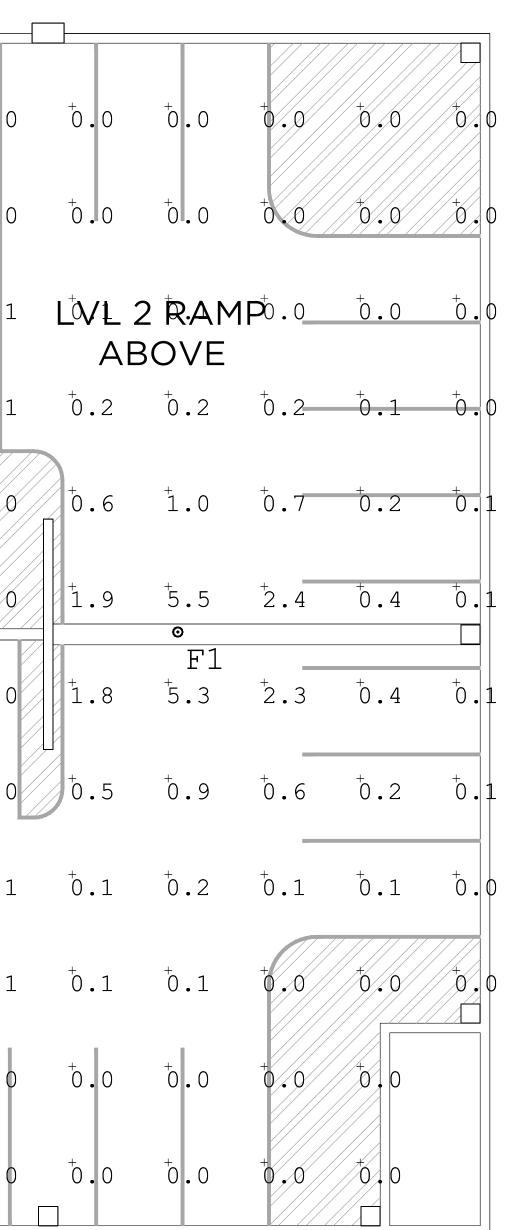

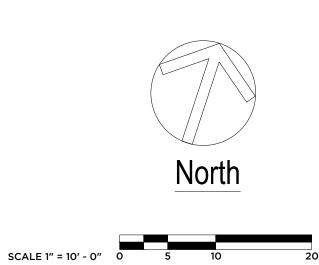





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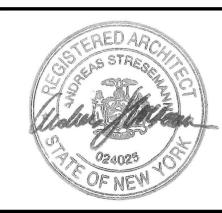
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333 Pleasant Valley Rd South Windsor, CT, 06074 TEL: (203) 788-0814 CONTACT: CLIFF GILBERT E: cgilbert@illuminatene.com

REVISIONS									
#	DATE	REVISION DESCRIPTION	BY:						

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PROJECT NAME ELECTRIC OWL STUDIOS

1 S BROADWAY HASTINGS ON HUDSON, NY JOB NO.: **23003** DRAWN BY: **JS** PROJ. MANAGER: **AS** 02/07/24 SCALE: AS NOTED DATE: DRAWING TITLE PHOTOMETRICS - GARAGE RCP

LVL 2

DRAWING NO.



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203.625.9460

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	DATE	DATE REVISION DESCRIPTION

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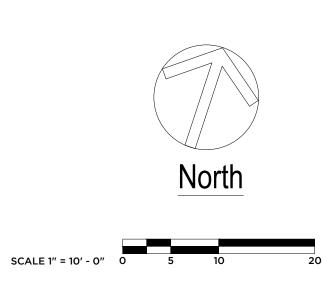


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HASTINGS	ON HUDSON, N	IY	
JOB NO.:	23003		
DRAWN B	Y: JS	PROJ. MA	NAGER: AS
DATE:	02/07/24	SCALE:	AS NOTED


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LVL 4 - STUDIO PARKING

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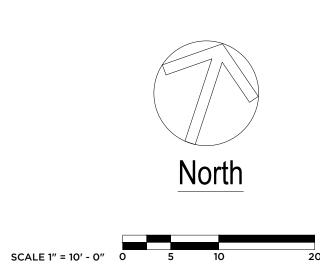


PROJECT NAME ELECTRIC OWL STUDIOS

S BROAD HASTINGS	WAY ON HUDSON, N	lΥ	
JOB NO.:	23003		
DRAWN B	Y: JS	PROJ. MA	ANAGER: AS
DATE:	02/07/24	SCALE:	AS NOTED

DRAWING NO.

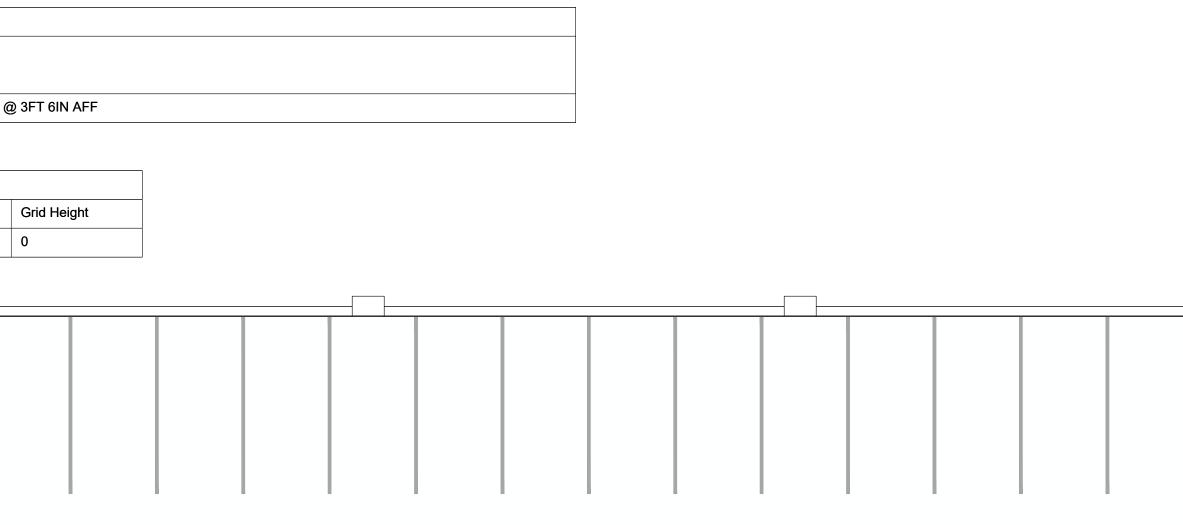





GREEN METAL OPTION - AERIAL IMAGE VIEW FROM ABOVE S. BROADWAY NTS



GREEN METAL OPTION - STUDIO BUILDINGS FROM ENTRY NTS



GREEN METAL OPTION - ZOOMED AERIAL FROM ABOVE S. BROADWAY NTS



GREEN METAL OPTION - STUDIO BUILDINGS FROM CAMPUS NTS

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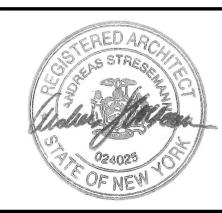
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PROJECT NAME ELECTRIC OWL STUDIOS

1 S BROADW HASTINGS C	/AY N HUDSON, NY		
JOB NO.:	23003		
DRAWN BY:	JS	PROJ. MA	NAGER:
DATE:	02/07/24	SCALE:	AS NO
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ARCHITECTURAL RENDERINGS -**GREEN METAL**

DRAWING NO.

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GREY METAL OPTION - AERIAL IMAGE VIEW FROM ABOVE S. BROADWAY NTS



GREY METAL OPTION - STUDIO BUILDINGS FROM ENTRY NTS



GREY METAL OPTION - ZOOMED AERIAL FROM ABOVE S. BROADWAY NTS



GREY METAL OPTION - STUDIO BUILDINGS FROM CAMPUS NTS



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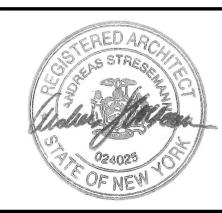
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PROJECT NAME ELECTRIC OWL STUDIOS

1 S BROAD HASTINGS	WAY ON HUDSON, N	Y	
JOB NO.:	23003		
DRAWN BY	JS	PROJ. MA	NAGE
DATE:	02/07/24	SCALE:	ASN
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ARCHITECTURAL RENDERINGS -**GREY METAL**

DRAWING NO.

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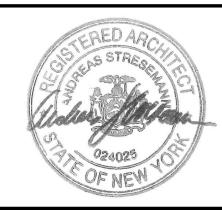
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DRAWN B	Y: JS	PROJ. MA	NAGER: AS	
DATE:	02/07/24	SCALE:	AS NOTED	
DRAWING TITLE				
DUDLEY ST ARTICULATION				

DUDLEY ST. ARTICULATION **OPTION 1 - GREEN METAL**

DRAWING NO.







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PROJECT NAME ELECTRIC OWL STUDIOS

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OPTION 1A - GREY METAL

DRAWING NO.







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DATE:	02/07/24	SCALE:	AS N
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OPTION 2 - GREEN METAL


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R: AS







OPTION 2A - SOUTH ELEVATION-GREEN METAL BASE BUILDING

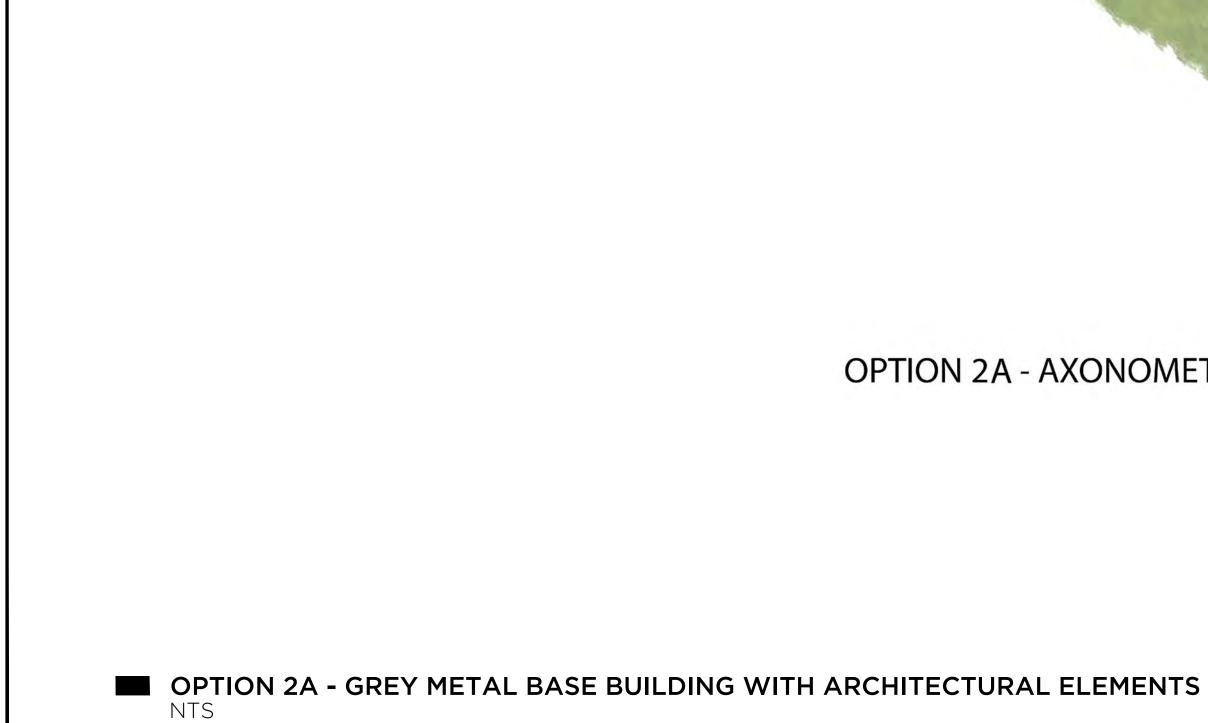



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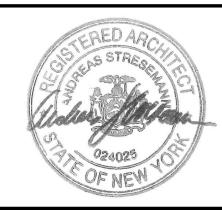
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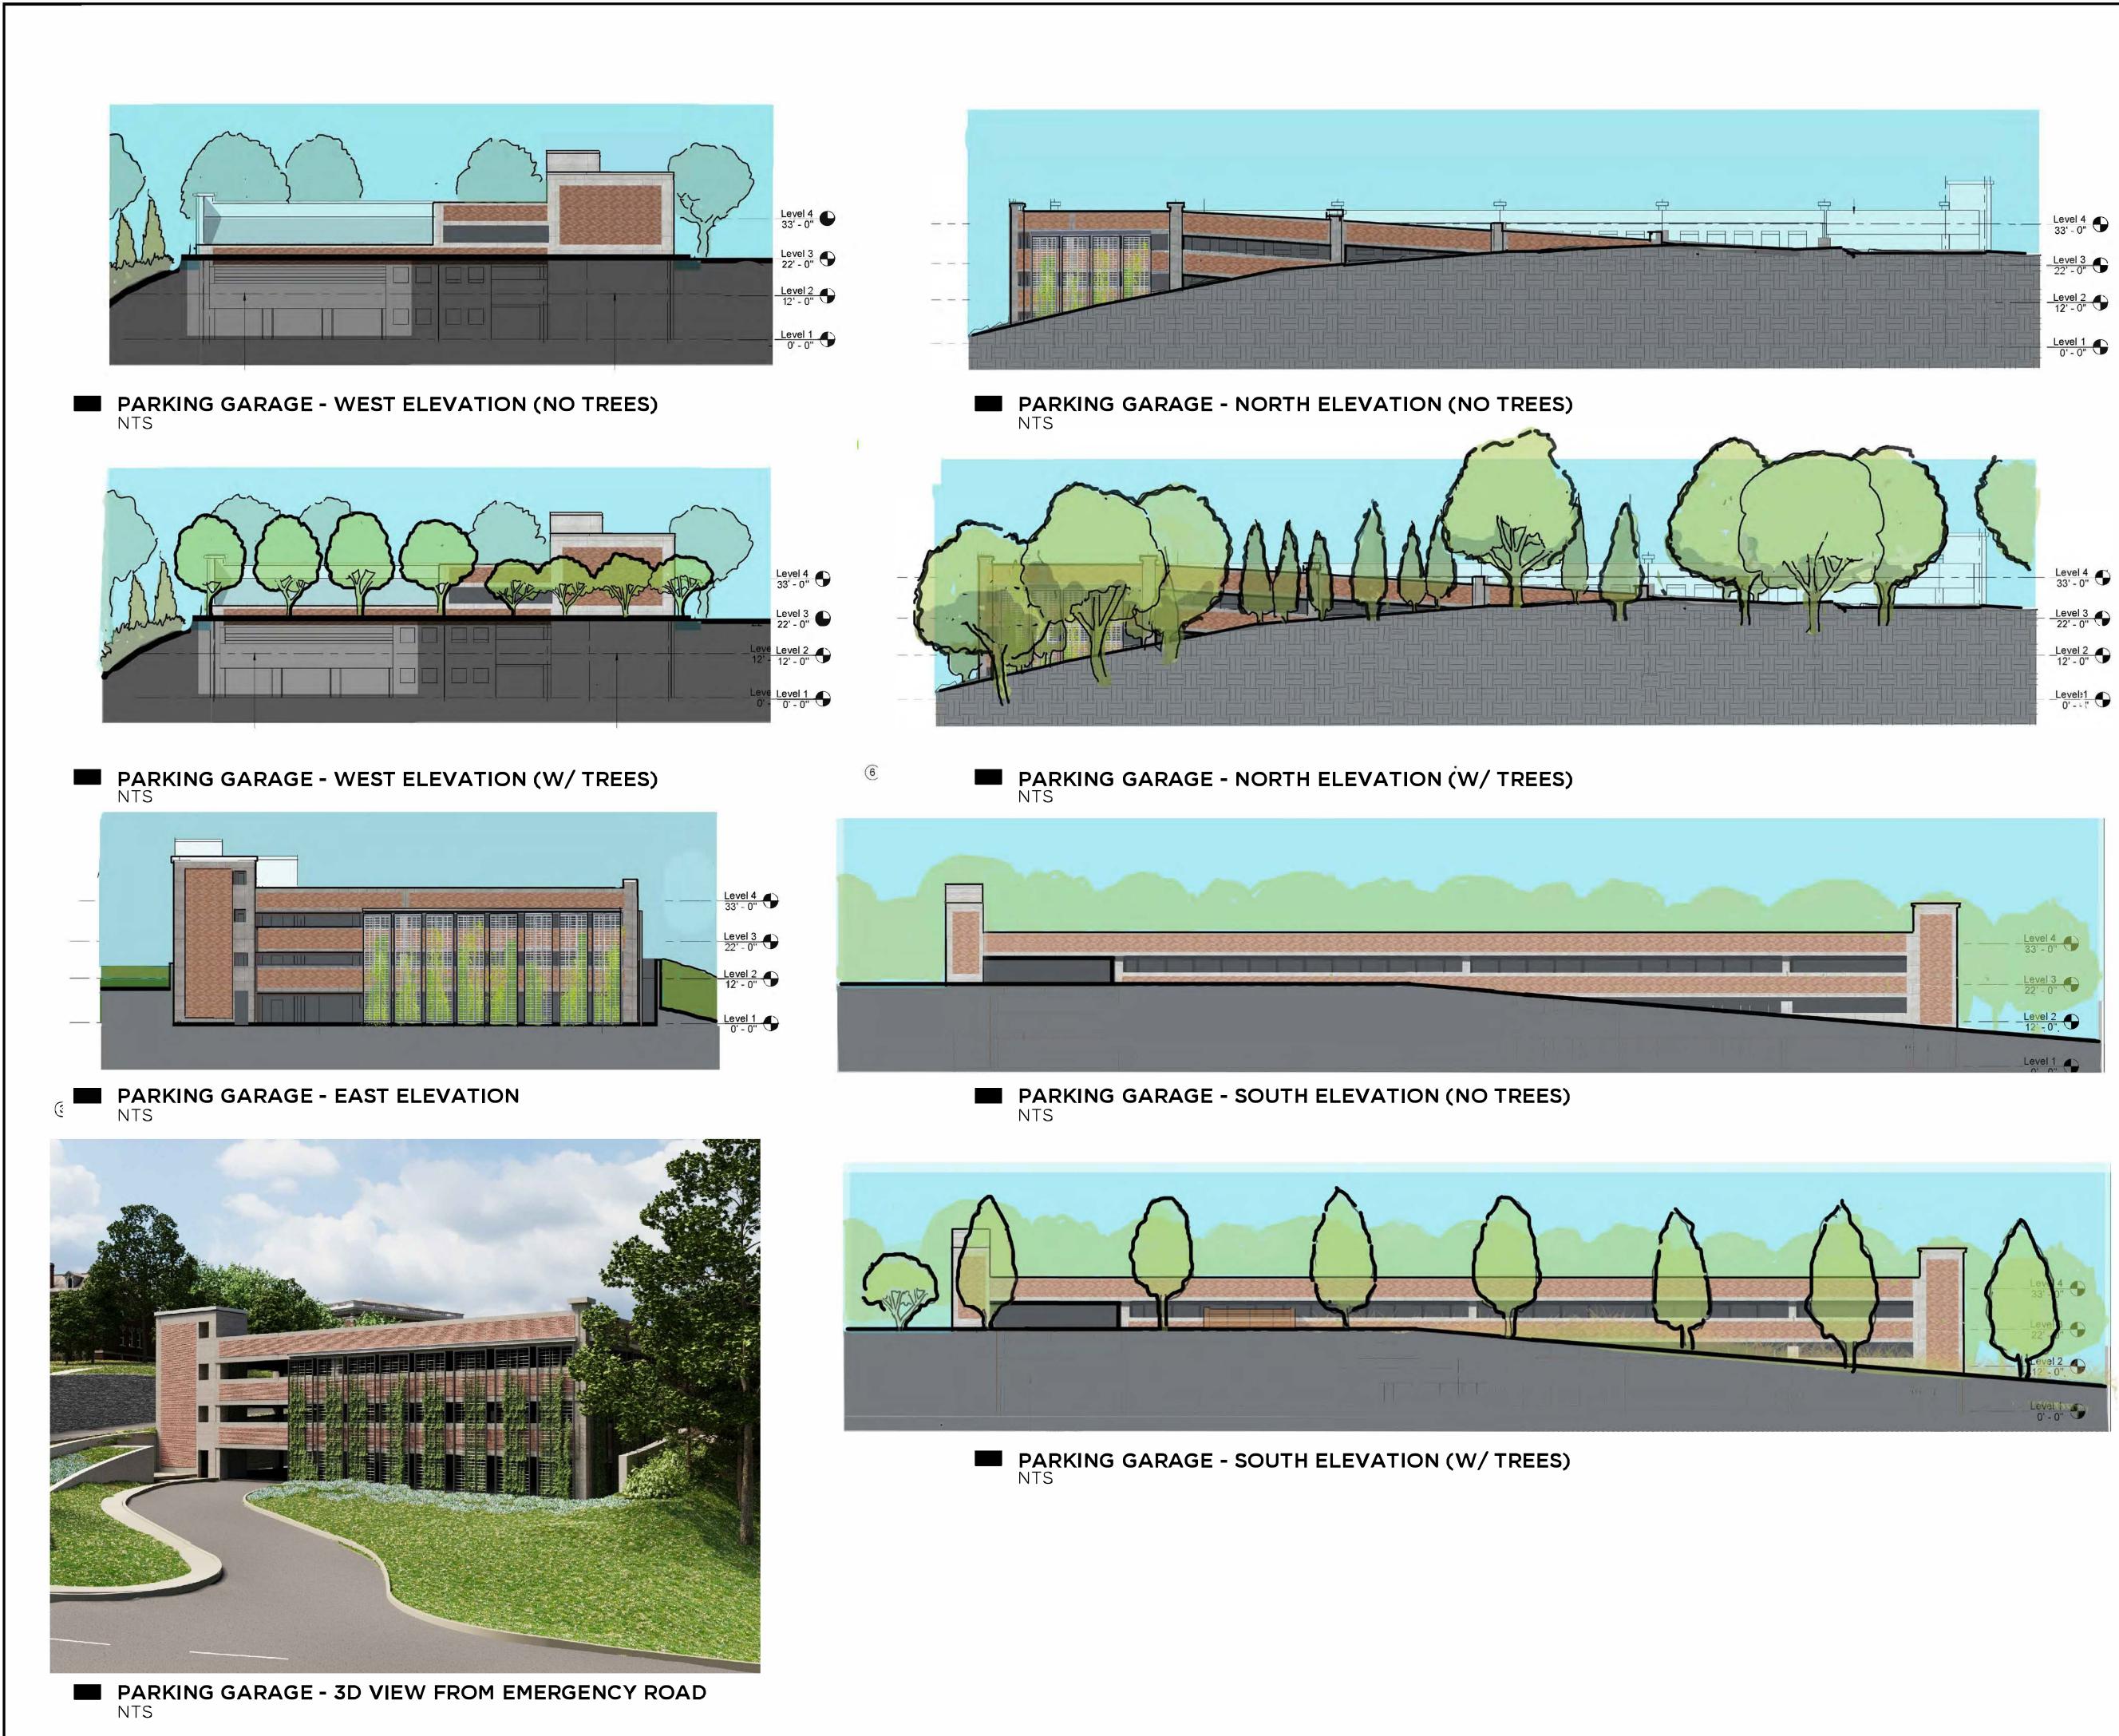


PROJECT NAME ELECTRIC OWL STUDIOS

1 S BROADWAY HASTINGS ON HUDSON, NY JOB NO.: **23003** DRAWN BY: **JS** PROJ. MANAGER: **AS** 02/07/24 DATE: SCALE: AS NOTED DRAWING TITLE DUDLEY ST. ARTICULATION **OPTION 2A - GREY METAL**

DRAWING NO.









330 RAILROAD AVENUE Greenwich, ct 06830

203.625.9460

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PROJECT NAME ELECTRIC OWL STUDIOS

1 S BROADWAY H≜STINGS ●N HUÐS●N, NY

JOB NO.: 23003

DRAWN BY: JS 02/07/24 DATE

PROJ, MANAGER: AS SCALE: AS NOTED BY:

DRAWING TITLE PARKING GARAGE RENDERED

SECTIONS

DRAWING NO.

A1.6



AERIAL VIEW OF EXISTING CAMPUS FROM ABOVE EMERGENCY ENTRY ROADWAY NTS



AERIAL VIEW OF EXISTING CAMPUS FROM ABOVE HUDSON RIVER NTS



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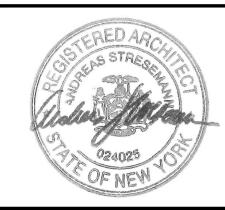
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E1.0



ADMINISTRATION BUILDING EXISTING CONDITION - REAR OF BUILDING NTS



ADMINISTRATION BUILDING EXISTING CONDITION - FRONT OF BUILDING NTS

ADMINISTRATION BUILDING EXISTING CONDITION - NORTH SIDE OF BUILDING NTS



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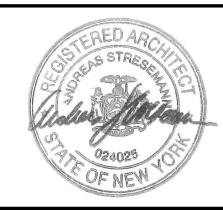
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PROJECT NAME **ELECTRIC OWL STUDIOS**

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DRAWING NO.







FRASER EXISTING CONDITION - REAR OF BUILDING NTS



FRASER EXISTING CONDITION - FRONT OF BUILDING NTS



SATTERLEE EXISTING CONDITION - REAR OF BUILDING NTS



SATTERLEE EXISTING CONDITION - FRONT OF BUILDING NTS





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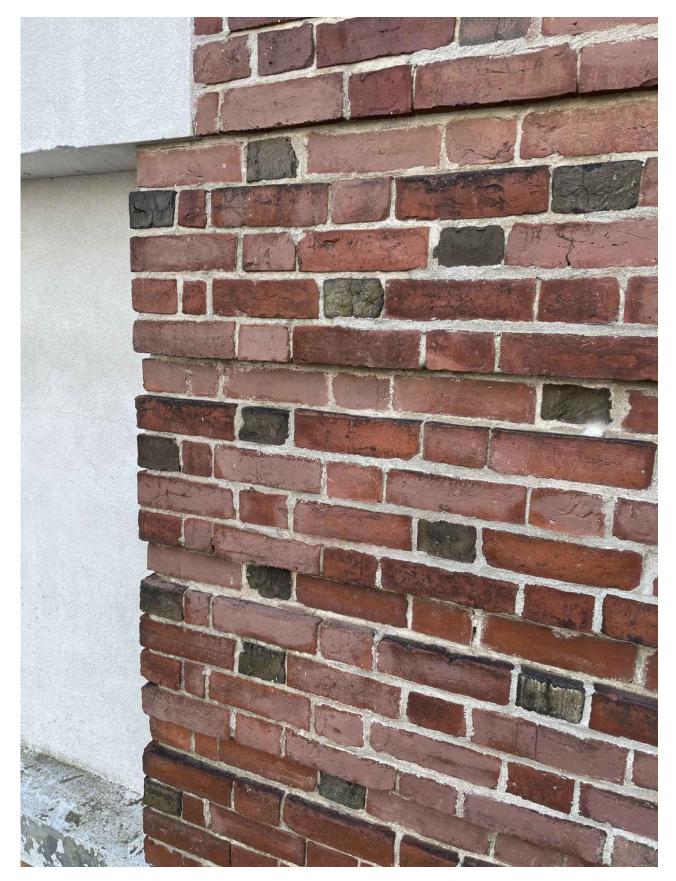
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1 S BROAD HASTINGS	DWAY 5 ON HUDSON, N	Y		
JOB NO.:	23003			
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DATE:	02/07/24	SCALE:	AS NOTED	
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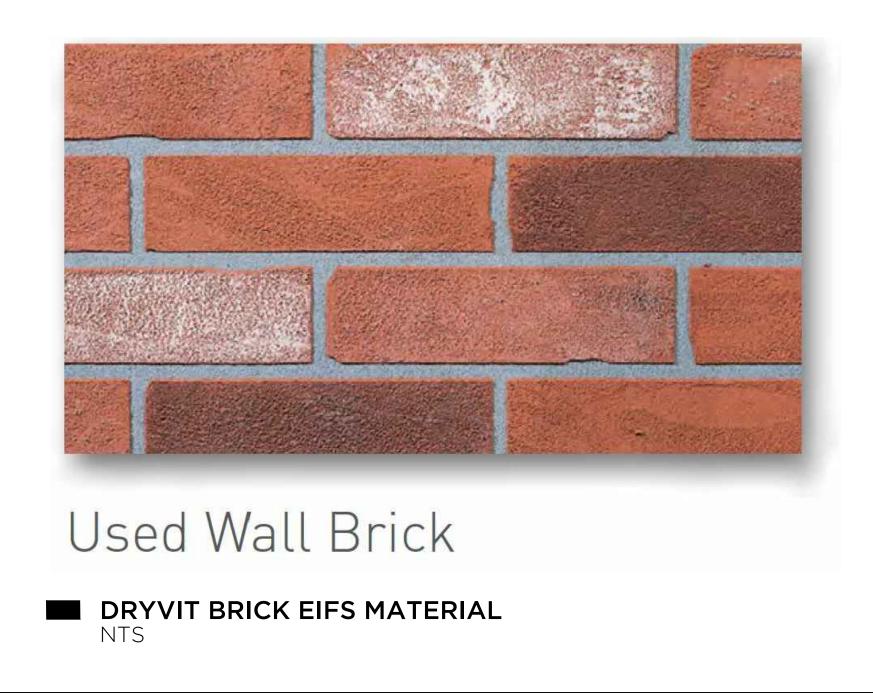
BUILDINGS

DRAWING NO.





EXISTING BRICK PATTERN TO MATCH NTS



OPTION 1







Charcoal THRIFTY | PRIME

POWDER COATED METAL BUILDING MATERIAL NTS

OPTION 2

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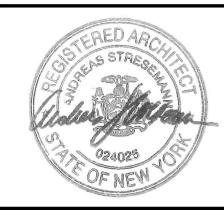
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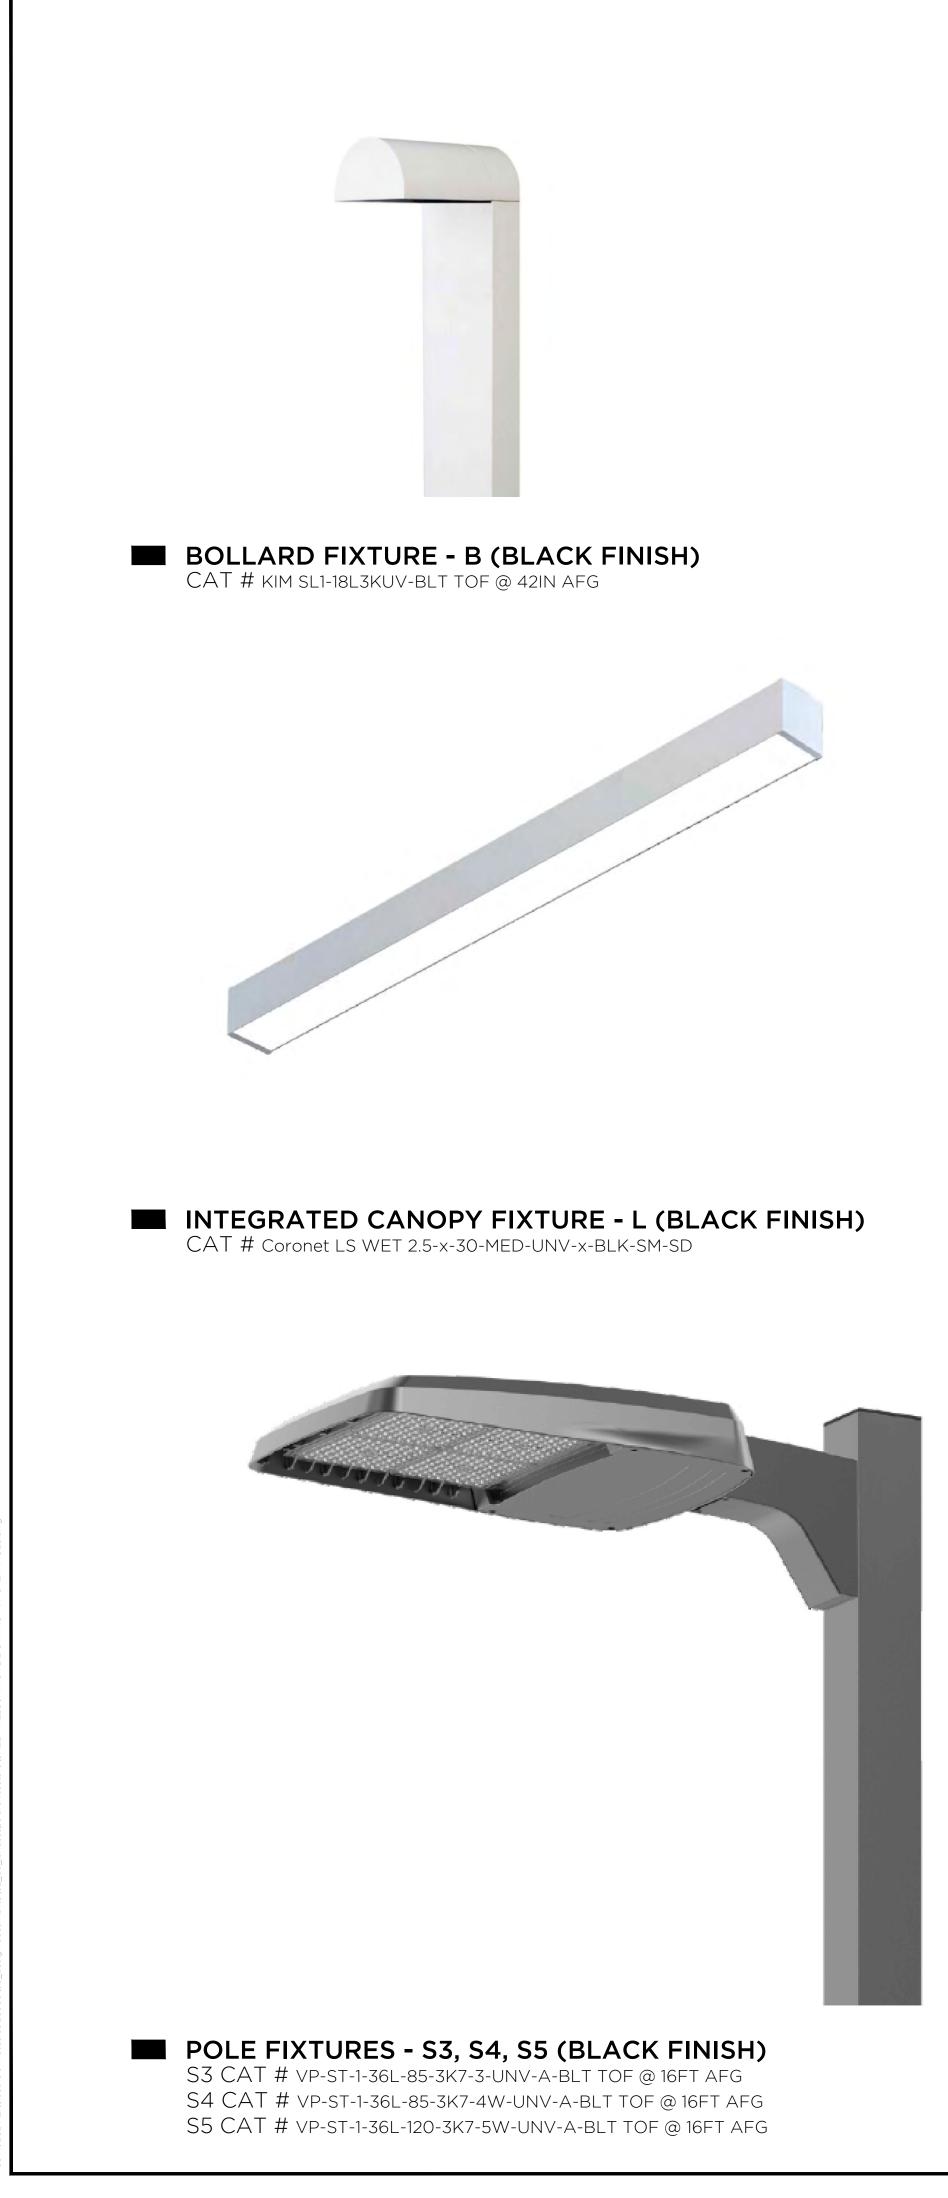


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DRAWING NO.

M1.0










LANDSCAPE WALL STEPS FIXTURE - (BLACK FINISH) B-K LIGHTING YUKON LED INDIRECT WALL LIGHT CAT # YK-I-LED- 2790-BLP-VR -B1-010-MT







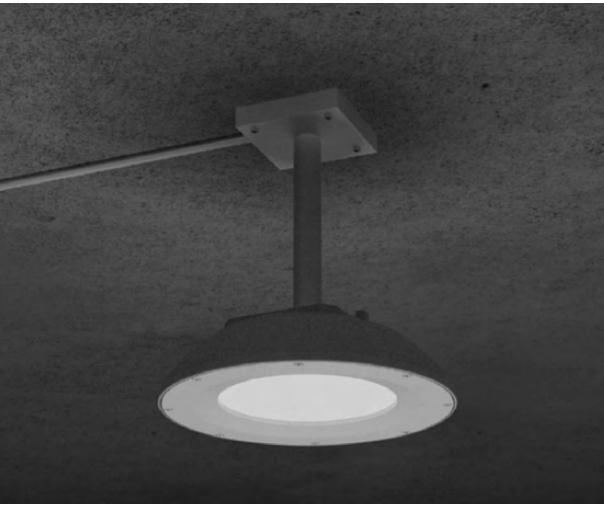

F1 CAT # SRT1-20-3K7-5QW-UNV-BL







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PROJECT NAME ELECTRIC OWL STUDIOS

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SITE LIGHTING FIXTURE IMAGES

DRAWING NO.

M1.1

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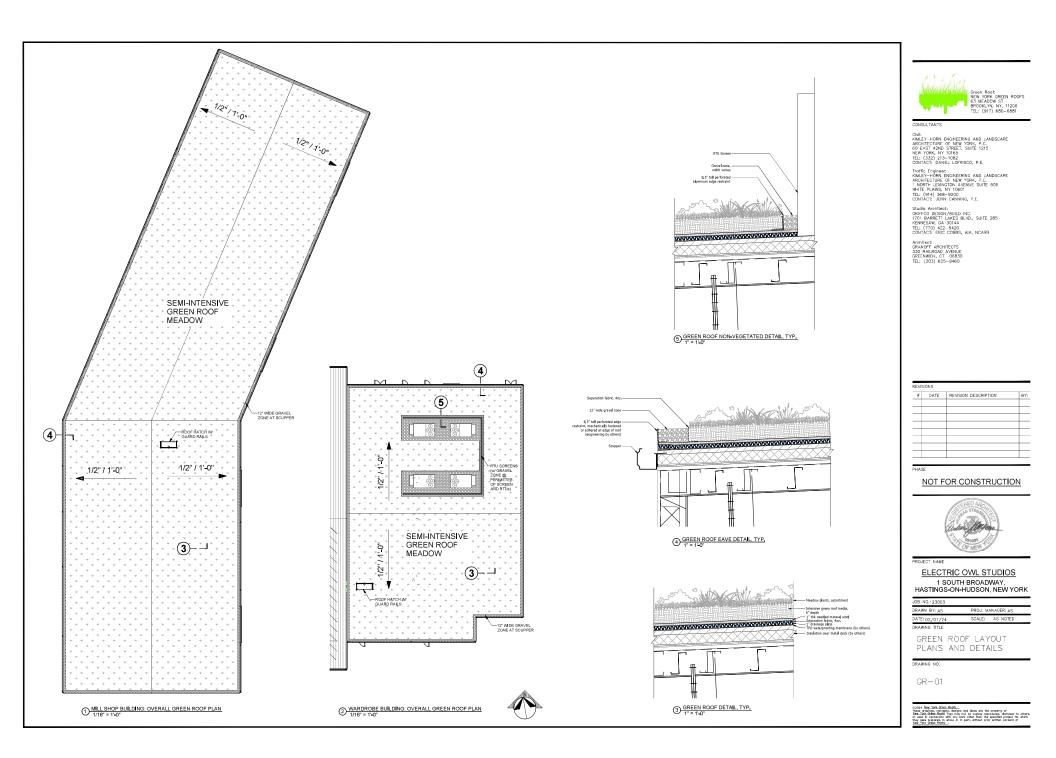
GARAGE WALL LIGHT - (BLACK FINISH) F2 CAT # RWL1-48L-10-3K7-4W-U-BLT BOF @ 3FT 6IN AFF


GARAGE CEILING LIGHT - (BLACK FINISH)



LANDSCAPE DOWN LIGHT FIXTURE - (BLACK FINISH)

CAT # LA-524(3000K)-BLP TREE AND STAKE MOUNTED



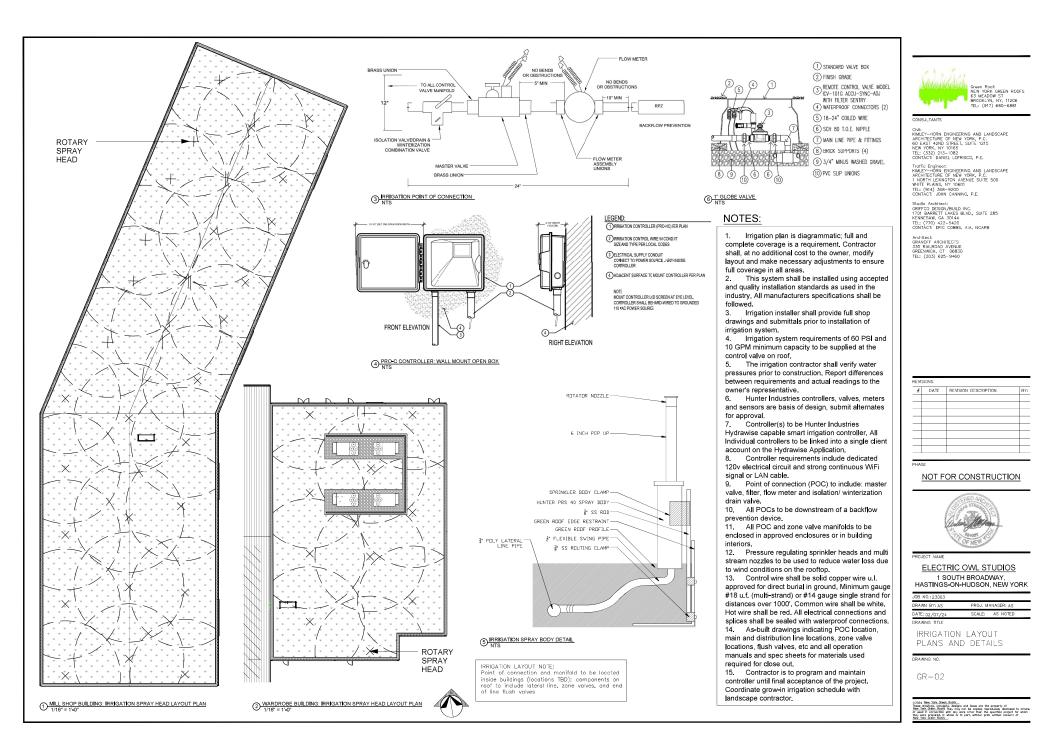



View of Proposed Green Roof on Wardrobe Building from Road Below



Aerial View of Electric Owl Studios Campus with Proposed Green Roofs at Wardrobe Building and Mill Shop Building

SEMI-INTENSIVE GREEN ROOF MEADOW POTENTIAL PLANT SPECIES (via SEED MIX)

PERENNIALS (NATIVE)

- Asclepias tuberosa (Butterfly Weed) .
- Symphotrichum laeve (Smooth Aster)
- Aster ericoides (White Heath Aster) . •
- Liatris aspera (Rough Blazing Star) ٠
- Monarda punctata (Spotted Beebalm)
- . Ruellia humilis (Wild Petunia) • Dalea purpurea (Purple Prairie Clover)
- Lupinus perennis (Wild Lupine)
- Solidago speciosa (Showy Goldenrod) •
- Verbena urticifolia (White Vervain)
- Geum canadensis (White Avens)
- Penstemon digitalis (Tall White Beardtongue)
- . Rudbeckia hirta (Black Eyed Susan)

GRASSES (NATIVE)

- . Bouteloua curtipendula (Sideoats Grama) • Koeleria macrantha (Junegrass)
- Schizachyrium scoparium (Little Bluestem)
- Sporobolus heterolepis (Prairie Dropseed) •

*Final selection of plant species and % for seed mix, TBD



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ELECTRIC OWL STUDIOS 1 SOUTH BROADWAY, HASTINGS-ON-HUDSON, NEW YORK

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DATE: 02/07/24	SCALE:	AS NOTED	
GREEN ROC	FS		
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