

SITE LOCATION


WESTCHESTER COUNTY, NEW YORK DEPARTMENT OF PUBLIC WORKS & DIVISION OF ENGINEERING TRANSPORTATION

MISCELLANEOUS ROADWAY IMPROVEMENTS LLAGE OF HASTINGS ON HUDSON, NY WARBURTON AVENUE (C.R. #75I) CONTRACT No. 16-526

LIST OF DRAWINGS

AREA H

LOCATION MAP

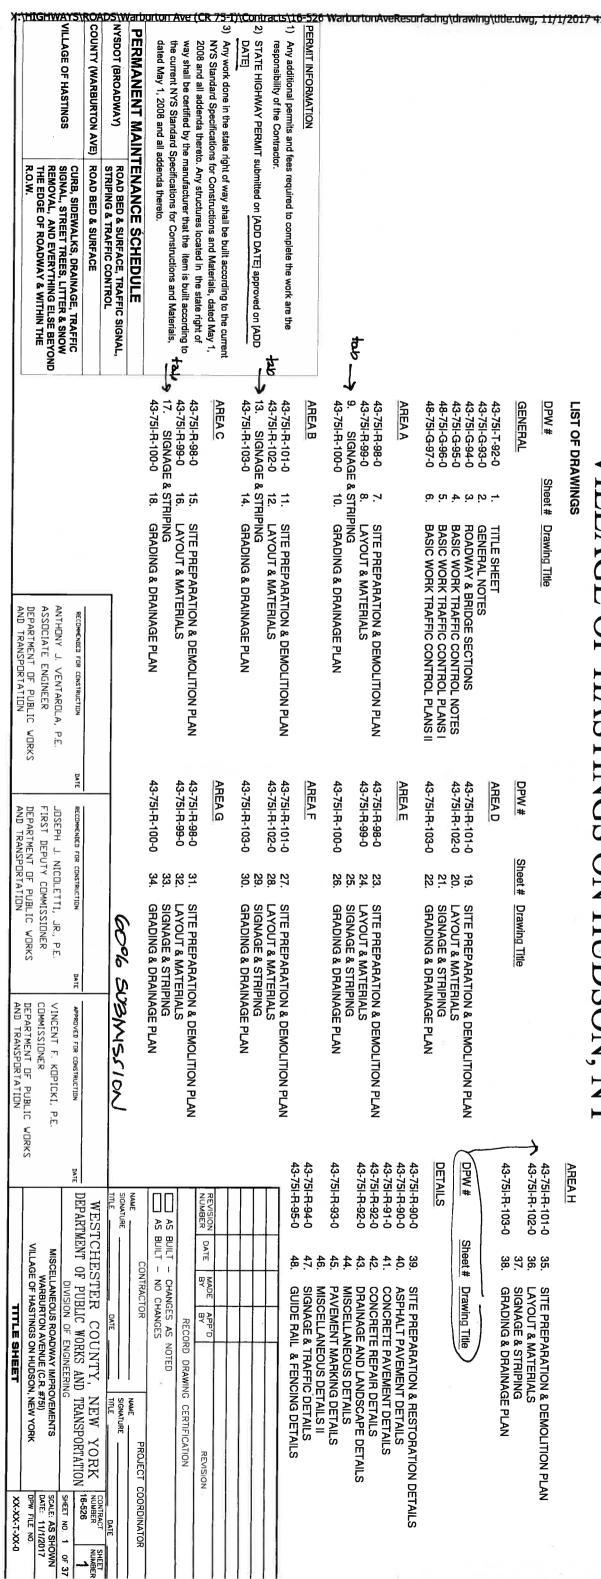

O VILLAGE OF HASTINGS

NYSDOT (BROADWAY)

SCOPE OF WORK

material and equipment required for milling and paving Warburton Ave (Ci 751) from Broadway to City line of Yonkers, including concrete sidewalks, replacement and other ancillary landscape and drainage work. roadway repair and curb replacement, pavement striping, traffic loop The work under this contract consists of providing all necessary labor, paving Warburton Ave (CR

General Notes

- County prior to the bid. The Contractor shall visit the site and familiarize himself with existing site conditions prior to submitting a bid. He shall check, and verify all conditions and dimensions and report any discrepancies, where evident, to Westchester
- Ю materials and all addenda thereto, excluding pay items that begin with a "W" which are Westchester County Special Specifications (see specifications) All pay items shown on Plans refer to the latest version of the New York State
- ω Work pertaining to modifications, as may be required, due to any difference between actual field conditions and those shown by the details and dimensions on the contract plans, will be paid at the unit bid price for the actual quantities of materials used or for the work performed, as indicated by the various items in the contract.
- The contractor is responsible for examining the areas of proposed work as to the actual conditions and requirements of work prior to submitting a bid. He/she shall check and verify all conditions and dimensions, and any discrepancies between the drawings and field conditions shall be brought to the attention of the Engineer in writing prior to commencement of work.
- caused by his operations which are not included as part of the intended work. All damages to the existing facilities which are not part of the intended work shall be repaired by the Contractor without cost to the County, and to the satisfaction of the Engineer. The contractor will be held responsible for all damages to the existing facilities
- All work shall be done and installed in compliance with all laws, rules and regulations of the local municipality and shall comply with the latest edition of the New York State Fire Prevention and Building Code, including all reference have approvals in accordance with any other public authorities or agencies having jurisdiction over the project. The contractor shall protect his workers at all times in conformance with applicable OSHA regulations. standards. All materials and equipment used in the project shall conform to and
- any temporary driveway closures. See Construction Staging Note #4. reasonably possible. Property manager/owners must be notified in advance of ð all adjoining facilities shall be maintained at all times where
- pavement when ordered by the Engineer. Maintenance cleaning shall mean the removal of debris from any source, which in the opinion of the Engineer impedes flow of traffic or storm water. This requirement shall not be construed to change the provisions of Article 619-1.02B Snow and Ice Control (NYSDOT The Contractor will be required to perform maintenance cleaning of Ħe

X:\HIGHWAYS\ROADS\Warburton Ave (CR 75-I)\Contracts\16-526 WarburtonAveResurfacing\drawing\title.dwg, 11/1/2017 11:44:21 AM, 1:2

- Areas beyond the work limits disturbed for any reason by the Contractor and his employees, shall be restored to the satisfaction of the Engineer at the Contractor's expense.
- ö details and work quantities. The contractor shall perform accordance with field conditions and as directed by the Engineer. reconstruction projects, the exact extent of reconstruction work cannot always be accurately determined prior to the commencement of work. These contract documents have been prepared based on field inspection and other available The Contractor's attention is directed to the fact that due to the nature of Actual field conditions may require modifications to construction work quantities. The contractor shall perform the work in
- "A.O.B.E." indicates work to be performed as ordered by Engineer

CHECKED BY IN CHARGE OF

> LOPANE VENTAROLA,

SITZMAN

DATE

MADE BY

APP'D

REVISION

SIGNATURE NAME

DATE

SIGNATURE

DATE

PROJECT

COORDINATOR

AS AS BUILT BUILT

CHANGES AS NOTED NO CHANGES

RECORD DRAWING

CERTIFICATION

MADE BY

12. The Contractor shall take positive steps to prevent the splattering vehicles. The Contractor shall provide for the prompt cleaning of a vehicles splattered by Contractor's operations and shall pay for cleaning. The cost for this work shall be include in the price bid for any the 앜

Paving and Milling

confirm *Gimes*

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- Ņ Tack coat shall be applied to any asphalt concrete pavement except when the existing surface is excessively flushed, as determined by the Tack coat shall be applied to any asphalt concrete pavement
- ω for the overlay at the limits of resurfacing, prior to reopening the roadways to traffic, the Contractor shall either place the proposed asphalt overlay immediately or place a temporary wedge (4' min. width a.o.b.e.) of asphalt to eliminate the bump created by the pavement key. The cost of this work shall be included in the price bid for the paving items. Where pavement keys are cut into the existing pavement in preparation
- 4. which are to remain in place. If the contractor damages any materials that are to remain in place, the damaged materials shall be either repaired or contractor. The Contractor shall keep the roadway within the project limits clear of debris and dust and is responsible for any street cleaning replaced in a manner satisfactory to the Engineer at the expense of the necessary during the course of the project. operations so as not to unduly disturb or damage underlying materials contractor shall exercise care in his cold milling and removal
- ĊΩ Prior to opening crosswalks to pedestrians after milling operations, the crosswalk area shall be inspected by the Engineer to ensure an even walking surface for pedestrians for safety issues. Walking surfaces deemed unsafe shall be corrected by the Contractor as directed by the
- Ģ water for milling, saw cutting and other o municipalities will not be able to provide this The contractor is solely responsible for <u>properly</u> securing any required water for milling, saw cutting and other operations. The County and and
- Pavement shall be cleaned after milling, and directly before paving. This work is included in the milling

Staging Areas

- Due property. Therefore, equipment must be removed from work areas at the end of each work day, unless approved in writing by the Engineer. to the populated locations of some of the work sites, there will be ed areas for staging available for work operations on or off County
- і'n original condition after completion of the project. No separate payment will be made for this work. Any staging area for equipment and material storage, for the contract must be approved by the Engineer and municipality and restored to its
- ω The Contractor's attention is directed to the fact that because of the proximity of adjacent property, within the limits of this contract, there may not be exclusive occupancy of the territory within the limits of this
- ω Whenever items in the contract require materials to be removed and disposed of, the cost of supplying a disposal area and transportation that area shall be included in the unit price bid for those items. ಠ

Construction Staging

- 'n This roadway is a major arterial and as such has a large volume of traffic Roads are limited to a single lane closure at any given time. Full closures and detours will not be permitted without written permission from the Engineer, and the Village of Hastings
- limited to one "segment" or zone, only one side of the travelled way at a time only with the written permission of the Engineer. A work "segment" or zone is defined as that the contract of the travelled way at a or zone is defined as that area in which traffic is restricted because construction activities in the travel way, or that area that invokes Contractor will be required to perform the milling and paving operations at night between 10:00 pm and 6:00 am. No lane closures are permitted on weekends or 7:00 am to 9:30am and 3:00 pm to 7:00 pm on weekdays. Work may be permitted on weekends only with the written permission of the Engineer and the Village of Hastings. All work shall be drop-off next to the pavement.
- A schedule of operations shall be provided to the County prior to start work, indicating which roads will be affected by work and allowing prop allowing proper

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- contract limits before commencing any operations which will temporarily interfere with their use. The Contractor shall assign a responsible employee to give the aforementioned notices in writing after concurrence give forty-eight (48) hours prior notice to the County, and the Village of Hastings. In addition, he shall give forty-eight (48) hours notice to all residents and/or businesses having driveways and entrances within the Before restricting the normal flow of traffic in any way, the Contractor shall with the Engineer.
- ĊΩ Police for traffic services shall be utilized at work locations where required by municipal regulation, or at the discretion of the Engineer, paid accordingly from item W911. and is

Utilities

required under this contract, the Contractor shall verify actual locations by excavating test pits under the direction. 1. The location, state, and the contractor shall agree to existing utilities are not guaranteed. The Contractor shall agree to existing utilities are not guaranteed. The Contractor of Public Service the regulations of the State of New York, Department of Public Service code 16 NYCRR Part 753- "Protection of Underground Facilities," call the commencing any work. Where excavation is Test pits paid for under Item 206.05

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Engineer and the taken not to damage said facilities, or bury them under new layers pavement. Existing damaged facilities should be reported to t The Contractor shall be responsible for locating surface utility is, such as valve boxes & electrical manholes. Care should be appropriate utility company. to the

Testing of Materials


- Material testing shall be paid under Item W851, and shall used at the discretion of the Engineer. Such testing involves, but I limited to, asphalt density testing, concrete cylinders and slu measurement and may include pavement cores. shall be but not slump
- 2. 7 on site. The County reserves the right to weigh all asphalt material trucks

Erosion Control Notes

- All proposed soil erosion and sediment control practices have been designed in Specifications for Erosion and Sediment Control. The contractor shall comply Management Design Manual and the New York State Standards and sediment control laws, rules, regulations and permits with all applicable stormwater management, water quality control, erosion, and accordance with the most recent editions of the New York State Stormwater
- Sediment and erosion control practices shall be installed prior to any major soil disturbances and maintained until permanent protection is established.
- $\underline{\omega}$ order. The sediment level in all sediment traps shall be closely monitored and a regular basis, and after rainfall events greater than half an inch to ensure The contractor shall be responsible for the timely maintenance of sediment and construction administrator. All sediment control practices shall be inspected on sediment removed when maximum levels are reached or as ordered by the erosion control practices. All practices shall be maintained in good working
- deemed included in the various items of the contract. No Direct Payment. days once it is known the soil stockpile will not be used for a period of time as approved by the construction administrator. All soil stockpiles shall be limed All soils not being used for final grading shall be immediately, protected fertilized, temporarily seeded with annual or perennial ryegrass or oats within 14 stabilized and stockpiled in a location away from storm drains and waterbodies than 14 days. The cost of such protection and stabilizat
- Any disturbed areas that will be left exposed for more than 21 days and are not Erosion control fabric or mulch shall be used on all disturbed areas if the fertilize prior to temporary seeding. slopes (slope gradient of 2:1 or greater). Disturbed areas shall be limed and stabilization. Erosion control fabric shall be used to temporarily stabilize steep season prevents the establishment of a temporary cover for temporary subject to construction traffic shall be stabilized with temporary seeding.
- All disturbed areas within 500 feet of an inhabited dwelling shall be wetted necessary to ensure dust control
- Specifications for Erosion and Sediment Control. areas used during the course of construction has been properly stabilized by Temporary sediment and erosion control practices shall be removed and Management Design Manual and the New York State Standards and permanent practices in accordance with the New York State Stormwater specified, when the drainage area, including all roads, driveways, and parking permanent sediment and erosion control practices implemented, where
- <u>@</u> The contractor shall phase the construction in a manner that there will be no more than five acres of soil disturbance at any one time

THE CONTRACTOR IS ADVISED THAT ADDITIONAL NOTES WILL BE FOUND ON SUBSEQUENT SHEETS OF THE CONTRACT PLANS. SUCH NOTES WHILE PERTAINING TO SPECIFIC DRAWINGS WHERE THEY ARE PLACED, ALSO SUPPLEMENT THE GENERAL LISTED HEREIN.

GENERAL NOTES	VILLAGE OF HASTINGS ON HUDSON, NEW YORK	WARBURTON AVENUE (C.R. #751)	MISCELLANEOUS ROADWAY IMPROVEMENTS	DIVISION OF ENGINEERING	DEPARTMENT OF PUBLIC WORKS AND TRANSPORTATION 16-526	WESTCHESTER COUNTY, NEW YORK NUMBER
C-XX-T-XX-0	DPW FILE NO	DATE: 11/1/2017	SCALE: AS SHOWN	SHEET NO. 2 OF 3	16-526	NUMBER NUMBE

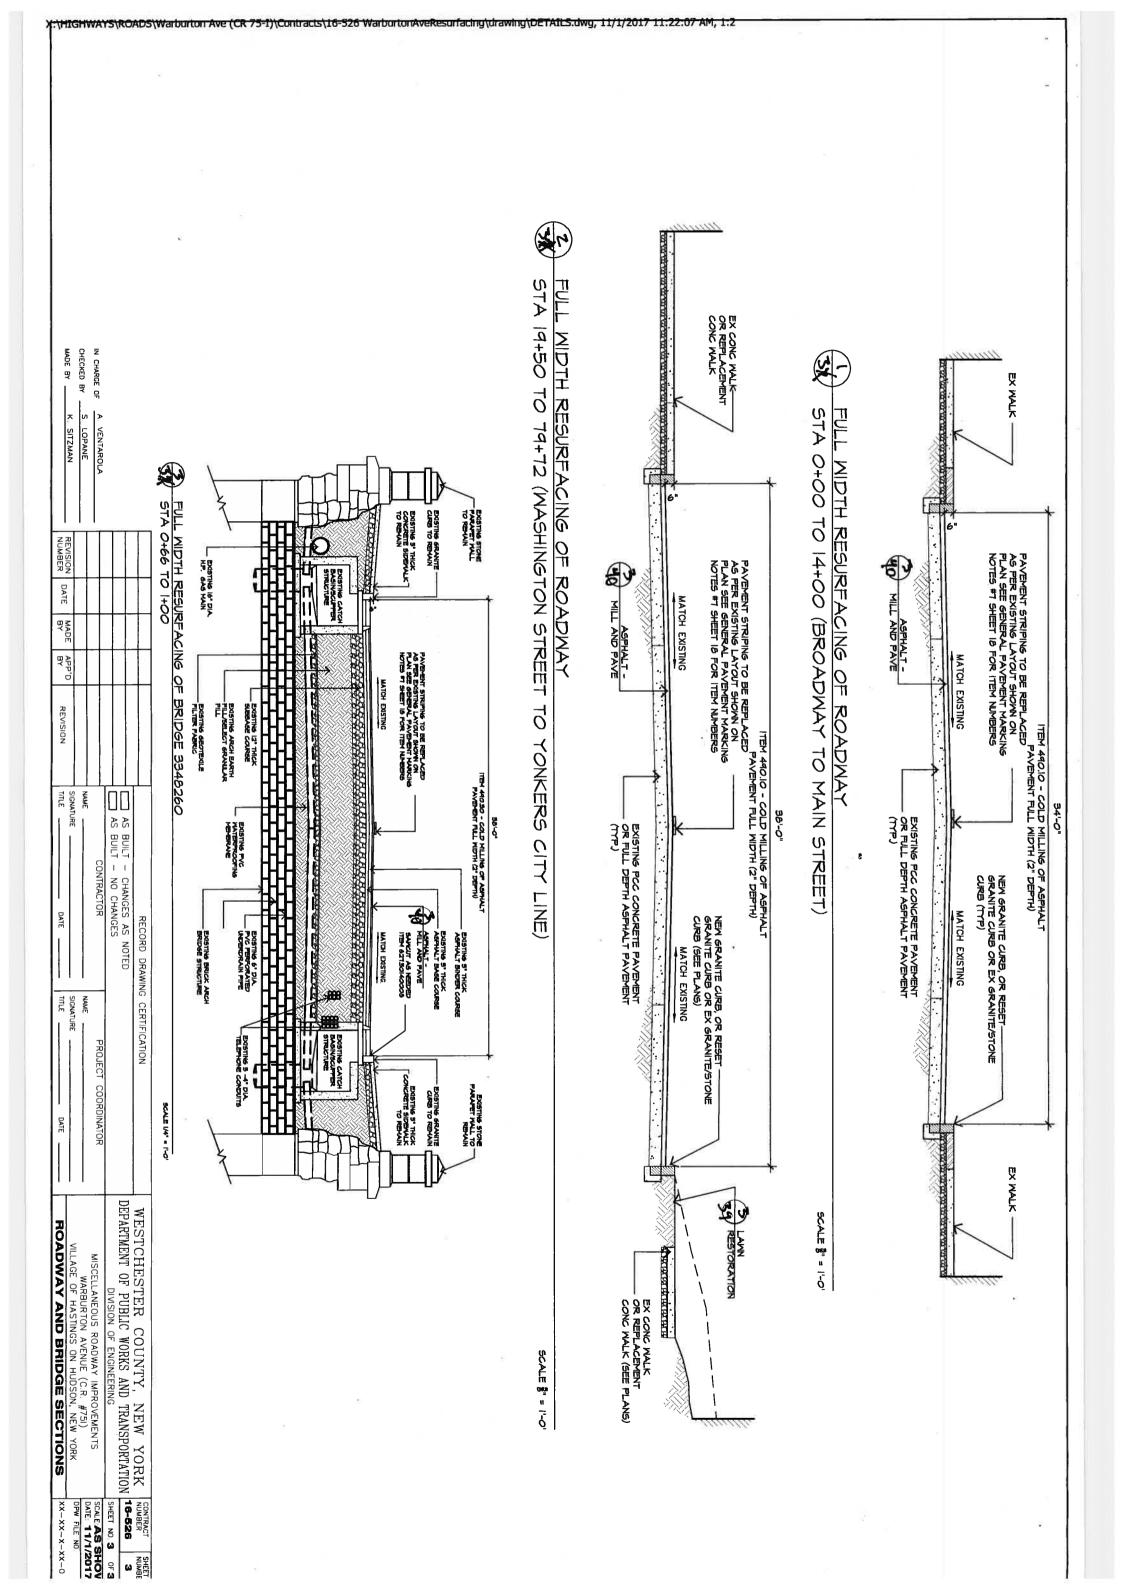

GENERAL NOTES (01/08/09)

THE TYPICAL DETAILS DEPICTED ON THE STANDARD SHEETS AND IN THE MUTCD, REFLECT THE MINIMUM REQUIREMENTS.

THE CONTRACTOR MUST SUBMIT TO THE ENGINEER, IN WRITING, PROPOSED REVISIONS TO THE TRAFFIC CONTROL PLAN FOR REVIEW AND APPROVAL BY THE REGIONAL DIRECTOR OR HIS/HER DESIGNEE FIVE (5) WORK DAYS PRIOR TO THE PLANNED IMPLEMENTATION OF SUCH PROPOSED REVISIONS, EXCEPT FOR CHANGES THAT ALTER THE SCOPE OF THE TRAFFIC CONTROL PLAN. SUCH CHANGES IN SCOPE MUST BE SUBMITTED TO THE ENGINEER FOR APPROVAL BY THE REGIONAL DIRECTOR OR HIS/HER DESIGNEE THIRTY (30) WORKING DAYS PRIOR TO IMPLEMENTATION OF SUCH REVISIONS.

THE CONTRACTOR SHALL PROVIDE THE ENGINEER, IN WRITING, WITH THE NAMES, AND TELEPHONE NUMBERS OF STAFF WHO ARE AUTHORIZED TO SECURE LABOR, ADDRESSES, AND TELEPHONE NUMBERS OF STAFF WHO ARE AUTHORIZED WORKING HOURS. THE MATERIALS, AND EQUIPMENT FOR EMERGENCY REPAIRS OUTSIDE NORMAL WORKING HOURS. THE ENGINEER WILL PROVIDE THE SUBMITTED INFORMATION TO REGIONAL MANAGEMENT, THE NEW YORK STATE POLICE, THE RESIDENT ENGINEER, AND THE LOCAL POLICE

ACTIVITY AREA

THE CONTRACTOR SHALL MAINTAIN A MINIMUM 500' LONGITUDINAL DISTANCE BETWEEN CONSTRUCTION OPERATIONS ON ALTERNATE SIDES OF THE ROADWAY, UNLESS OTHERWISE APPROVED BY THE ENGINEER.

WHEN TWO OR MORE AREAS ARE ADJACENT, OVERLAP, OR ARE IN CLOSE PROXIMITY, THE CONTRACTOR SHALL ENSURE THERE ARE NO CONFLICTING SIGNS AND THAT LANE CONTINUITY IS MAINTAINED THROUGHOUT ALL WORK AREAS.

SIGNS

THE LOCATIONS OF THE SIGNS SHOWN ON THE WORK ZONE TRAFFIC CONTROL PLANS AND DETAILS MAY BE ADJUSTED BASED ON SIGHT DISTANCE AND OTHER CONSIDERATIONS. THE FINAL LOCATIONS OF SIGNS ARE SUBJECT TO APPROVAL OF THE ENGINEER.

ANY EXISTING SIGNS, INCLUDING OVERHEAD SIGNS, WHICH CONFLICT WITH THE TEMPORARY TRAFFIC CONTROL SIGN LAYOUT SHALL BE COVERED, REMOVED, STORED OR RESET, AS APROVED BY THE ENGINEER. ALL APPROPRIATE EXISTING SIGNS SHALL BE RESTORED TO THE CONTRACT CONTRACT ON THIS OTHERWISE REPLACED IN THIS CONTRACT.

SIGNS AT OR NEAR INTERSECTIONS SHALL BE PLACED SO THAT THEY DO NOT OBSTRUCT A MOTORIST'S LINE OF SIGHT.

A:\HIGHWAYS\ROADS\Warburiton Ave (CR.75-1)\Contracts\146-526, Warburiton Ave (CR.75-1)\Contracts\146-526, Warb ALL WARNING AND REGULATORY SIGNS SHALL BE POSTED ON BOTH SIDES OF MULTI-LANE DIVIDED HIGHWAYS, MULTI-LANE RAMPS, AND ONE-WAY STREETS, IN CASES WHERE LANE RESTRICTIONS REDUCE THE TRAVEL LANE TO ONE LANE, SIGNS SHALL BE POSTED ON THE RIGHT SIDE OF THE ACTIVE TRAVEL LANE, UNLESS OTHERWISE AUTHORIZED BY THE ENGINEER.

SIGNS MOUNTED ON THE MEDIAN OF DIVIDED HIGHWAYS WHERE MEDIAN BARRIER IS IN PLACE MAY BE MOUNTED ON THE BARRIER WITH A SADDLE TYPE BRACKET. LAYING THE SIGN DOWN IN A HORIZONTAL POSITION IS NOT PERMITTED.

THE DIMENSIONS OF WORK ZONE TRAFFIC CONTROL SIGNS ARE DESCRIBED IN THE MUTCD ANY CHANGES TO THE DIMENSIONS SHALL BE APPROVED BY THE REGIONAL DIRECTOR OR BY HIS/HER DESIGNEE.

NYR9-12 MAY BE USED IN PLACE OF NYR9-11.

ANNELIZING DEVICES

JBLIC ACCESS WHERE POSSIBLE ALL CHANNELIZING AND GUIDING DEVICES ARE PROVIDE A MINIMUM 2' LATERAL CLEARANCE TO THE TRAVELED TO BE PLACED SO AS WAY. 징

PROPERTY OWNERS WHOSE DRIVEWAYS WILL BE MADE INACCESSIBLE SHALL BE NOTIFIED BY THE CONTRACTOR AT LEAST 24 HOURS PRIOR TO RESTRICTING USE OF THE DRIVEWAY. FOR MULTIPLE ACCESS PROPERTIES, AT LEAST ONE DRIVEWAY SHALL BE OPEN AT ALL TIMES. ACCESS SHALL BE RESTORED TO ALL DRIVEWAYS AS SOON AS POSSIBLE.

SUITABLE RAMPS SHALL BE INSTALLED TO MAINTAIN SMOOTH TRANSITIONS FROM RESIDENTIAL AND COMMERCIAL DRIVEWAYS TO AND FROM THE WORK AREA.

THE CONTRACTOR SHALL LOCATE LANE CLOSURES TO PROVIDE OPTIMUM VISIBILITY, I.E. BEFORE CURVES AND CRESTS, TO THE EXTENT CONDITIONS PERMIT.

THE ENGINEER MAY REQUIRE THAT ALL LANES BE RE-OPENED AT ANY TIME IF THE ROUTE IS NEEDED FOR EMERGENCY PURPOSES. THIS COULD INCLUDE INCIDENTS AT LOCATIONS OUTSIDE THE CONTRACT LIMITS.

UNLESS AUTHORIZED BY THE ENGINEER, THE MINIMUM LANE WIDTHS FOR WORK ZONE TRAVEL LANES SHALL BE AS FOLLOWS: FREEWAYS AND/OR EXPRESSWAYS IS 11. THE MINIMUM LANE WIDTH FOR ALL OTHER TYPES OF ROADWAYS IS 10.

THE CONTRACTOR SHALL PROVIDE A WRITTEN NOTICE TO THE ENGINEER, A MINIMUM OF 21 CALENDAR DAYS IN ADVANCE OF PERFORMING ANY, WORK THAT RESULTS IN THE REDUCED WIDTH OF AN EXISTING ROADWAY, SO THAT THE ENGINEER MAY NOTIFY THE REGIONAL PERMIT ENGINEER IN A TIMELY MANNER.

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CONTRACTOR

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טוטטוטבא כנטטטאב		LANE CLUSURE		CLOSURE TYPE	(LONG TERM,		
NON-TRAVERSABLE HAZARD (IE. EQUIPMENT, MATERIALS, EXCAVATION) ONLY NO WORKERS EXPOSED	WORKERS ON FOOT OR IN VEHICLES EXPOSED TO TRAFFIC	NON-TRAVERSABLE HAZARD (IE EQUIPMENT, MATERIALS, EXCAVATION) ONLY NO WORKERS EXPOSED	WORKERS ON FOOT OR IN VEHICLES EXPOSED TO TRAFFIC		EXPOSURE CONDITION		TABLE NYI-A BARRIER VEHICLE USE REQUIREMENTS (LONG TERM, INTERMEDIATE TERM, AND SHORT TERM STATIONARY CLOSURES)
RECYLINED 3	REQUIRED 3	REDUIRED	REQUIATED 3	LVCEMAI	CDCCWAY		Y1-A ¡E REQUIREM SHORT TERM
OP THOUAL 2	REQUIRED ³	RECOLUMED 3	REQUIRED ³	W 4. MPH	NON-FREEWAY (PRECONSTRUC	USE REQUIR	IENTS I STATIONAF
OP NOVAL 2	OPTIDMAL ²	opingwal ²	REQUARED 3	35-MQ MPH	NON-FREEWAY (PRECONSTRUCTION POSTED SPEED LIMIT)	USE REQUIREMENTS 4,5	₹Y CLOSURE
OPTIONAL 2	OPTIONAL 2	OPTIONAL 2	OPTIONAL 2	1 30 MPH	SPEED LIMIT)		S)

LATERAL SHIFT OF TRAFFIC FLOW PATH

(25

MPH)

(30 MPH)|(35 MPH)|(40 MPH)

(45 MPH)|(50 MPH)|(55 MPH)|(60 MPH)|

(65 MPH) (70 MPH)

TEMPORARY TRAFFIC CONTROL ZONE POSTED SPEED LIMIT

APER LENGTHS

65 75

105

190 135

315 225 270

250 300 350 400

360 420 300

325

55

8 2 8

95 | 85

105 145 165 185 225 245

275 330 385 440 495 550 660

390 455 520 585 715

350 420 490 560 560 700 770 840

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540 540 600 660

135 150 165

240 270

54 55 55 55

500 550 600

105 115 125

180

SPEED (MPH)

LIMIT

(S)

TAPER LENGTH (L) (FT.)

TABLE

6H-4 FORMULAS

FOR

DETERMINING TAPER LENGTHS

(45 MPH) OR MORE (40 MPH) OR LESS

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WS²

/60

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H=H=H

TAPER LENGTH
WIDTH OF OFFSET (FT.)
PRECONSTRUCTION POSTED SPEED LIMIT (MPH)

- THE EXPOSURE CONDITIONS DESCRIBED IN TABLE NYI—A ASSUMES THERE IS NO POSITIVE PROTECTION (TEMPORARY TRAFFIC BARRIER) PRESENT. WHERE WORKERS OR HAZARDS ARE PROTECTED BY A TEMPORARYTRAFFIC BARRIER, BARRIER VEHICLES ARE NOT REQUIRED.
- WHERE THE REQUIREMENT IS "OPTIONAL", EITHER A BARRIER VEHICLE OR THE STANDARD LONGITUDINAL BUFFER SPACE (TABLE 6C-2) SHALL BE PROVIDED
- REQUIREMENTS SHALL INCLUDE PROVIDING A SEPARATE BARRIER VEHICLE FOR EACH CLOSED LANE AND EACH CLOSED PAVED SHOULDER 8' OR GREATER IN WIDTH. IF THE WORK SPACE MOVES WITHIN THE STATIONARY CLOSURE, THE BARRIER VEHICLE SHALL REPOSITIONED ACCORDINGLY. BARRIER VEHICLES PROTECTING NON-TRANSVERSABLE UNTIL THE HAZARD NO LONGER EXISTS. EXCEPTIONS TO THESE REQUIREMENTS MAY BE MADE, AS APPROVED BY THE REGIONAL DIRECTOR OR HIS/HER DESIGNEE WHERE BARRIER VEHICLE PLACEMENT WOULD BE INEFFECTIVE OR WOULD INTERFERE WITH THE SAFE OPERATION OF TRAFFIC. HAZARDS SHALL REMAIN IN PLACE DURING BOTH WORKING AND NON-WORKING HOURS 투표 黑

PRECONSTRUCTION POSTED

(MPH)

DISTANCE

INTERMEDIATE-TERM STATIONARY IS WORK THAT OCCUPIES A LOCATION MORE THAN ONE DAYLIGHT PERIOD UP TO 3 CONSECUTIVE DAYS, OR NIGHTTIME WORK LASTING MORE THAN 1 HOUR.

SHORT DURATION IS WORK THAT OCCUPIES A LOCATION UP TO 1 HOUR.

WOBILE IS WORK THAT MOVES INTERMITTENTLY OR CONTINUOUSLY.

SHORT-TERM STATIONARY IS DAYTIME WORK THAT OCCUPIES A LOCATION FOR MORE THAN 1 HOUR WITHIN A SINGLE DAYLIGHT PERIOD.

LONGITUDINAL BUFFER

SPACE

LONG-TERM STATIONARY IS THAN 3 CONSECUTIVE DAYS.

WORK DURATION DEFINITIONS

WORK THAT OCCUPIES A LOCATION MORE

TABLE

6C-

- BARRIER VEHICLES ARE NOT REQUIRED FOR MILLING AND/OR PAVING OPERATIONS, THE STANDARD LONGITUDINAL BUFFER SPACE (TABLE 6C-2) SHALL BE PROVIDED. BUT
- Ç BARRIER VEHICLES ARE NOT REQUIRED FOR FLAGGING OPERATIONS, BUT THE STANDARD LONGITUDINAL BUFFER SPACE (TABLEGC-2) SHALL BE PROVIDED.

ZONE TRAFFIC CONTROL LEGEND

EXPRESSWAY / FREEWAY	RURAL	URBAN (w 45 MPH*)	URBAN (35-40 MPH*)	→URBAN (30 MPH*)	ROAD TYPE		ADVANCE WARNING SIGN SPACING	
1000	500	350	200	100	A (FT.)	DISTANCE	WARNIN	TABLE NY6H-3
1500	500	350	200	100	A (FT.) B (FT.) C (FT.)	DISTANCE BETWEEN SIGNS	IG SIGN	NY6H-3
2640	500	350	200	100	C (FT.)	SIGNS	SPACIN	
1 MILE	1500 FT.	1000 FT.	AHEAD	AHEAD	XX	SIGN LEGEND	G	
? MILE	1500 FT. 1000 FT.	AHEAD	AHEAD	AHEAD	YY .	EGEND		,
		_	-	个				

DRIVEWAYS PER MILE OR GREATER, MAJOR COMMERCIAL DRIVEWAYS, NUMEROUS RIGHT OF WAY CONSTRAINTS, HIGH DENSITY OF CROSS STREETS, 85TH PRECONSTRUCTION POSTED SPEED LIMIT
 URBAN: (MEETS MORE THAN 1 OF THE FOLLOWING CRITERIA) SIDEWALKS, BIC
 USAGE, CURBING, CLOSED DRAINAGE SYSTEMS, DRIVEWAY DENSITIES GREATER THAN 24 DRIVEWAYS PER MILE, MINOR COMMERCIAL DRIVEWAY DENSITIES OF 10 BICYCLE

ANY AREA NOT EXHIBITING MORE THAN ONE OF THE ABOVE CHARACTERISTICS

FREEWAYS/INTERSTATE: LOCAL OR INTER REGIONAL HIGH-SPEED, DIVIDED, HIGH-VOLUME FACILITIES WITH FULL OR PARTIAL CONTROL OF ACCESS. ACCESS AND GENERALLY WITH GRADE SEPARATIONS AT MAJOR CROSSROADS DIVIDED HIGHWAYS FOR TRAFFIC WITH FULL OR PARTIAL CONTROL

V-VV-1-VV-10	BASIC WORK TRAFFIC CONTROL NOTES	IC WORK TRAI	BAS	DATE	— IIILE —	DATE
DPW FILE NO.	VILLAGE OF HASTINGS ON HUDSON, NEW YORK	AGE OF HASTINGS O	VILL		SIGNATURE	
SCALE: AS SHOWN DATE: 11/1/2017	MISCELLANEOUS ROADWAY IMPROVEMENTS WARBURTON AVENUE (C.R. #751)	SCELLANEOUS ROADWAY IMPROVEN WARBURTON AVENUE (C.R. #751)	MIS	PROJECT COORDINATOR	NAME	CONTRACTOR
SHEET NO. 4 OF 37	TRANSPORTATION	OF PUBLIC WORKS AND O	DEPARTMENT			CHANGES AS NOTEDNO CHANGES
CONTRACT SHEET NUMBER NUMBER	COUNTY, NEW YORK		WESTCHESTER	CATION	ING CERTIFI	RECORD DRAWING CERTIFICATION
D ATTENUATOR	WORK VEHICLE WITH TRUCK MOUNTED ATTENUATOR	X		FLAG TREE	 	
	WORK VEHICLE			FLAGGER		
	WORK SPACE			DIRECTION OF TRAFFIC	À	
	WARNING LIGHTS	qĵ	TOUR	DIRECTION OF TEMPORARY TRAFFIC DETOUR	Ţ	
	TYPE III BARRICADE		ATTENUATOR	CRASH CUSHION/TEMPORARY IMPACT ATTENUATOR	#	
	TRAFFIC OR PEDESTRIAN SIGNAL	•		CHANNELIZING DEVICE	•	
LIGHTS	TEMPORARY BARRIER WITH WARNING LIGHTS			CHANGEABLE MESSAGE SIGN (PVMS)	Ι	
	TEMPORARY BARRIER			ARROW PANEL TRAILER OR SUPPORT		
	SIGN, TEMPORARY	-		ARROW PANEL, CAUTION MODE		
	PAVEMENT MARKINGS THAT SHALL BE REMOVED FOR A LONG TERM PROJECT	///		ARROW PANEL		
	LUMINAIRE			DESCRIPTION	SYMBOL	

Basic Work Traffic Control

- Basic Work Traffic Control shall be provided in accordance with section 619 of the NYS Standard Specifications and the 2009 edition MUTCD (including the 2010 NYS Supplement), and subsequent addenda, and any provisions contained in the plans and/or proposal of this contract.
- The Contractor shall be responsible for all basic work zone traffic control. Maintenance of traffic schemes shall be in accordance with the plans and as approved or directed by the Engineer. Traffic schemes shown on the plans are to be considered minimum requirements. The Engineer may order additional signs, flaggers, cones, reflectorization etc., if deemed necessary at no additional cost to the County. Payment for all such work shall be included in the Series 619 items.
- Prior to the start of work, the Contractor may submit any proposed changes to the traffic control plan to the Engineer for approval. Any changes which alter the basic concept of the plan must be approved by
- The Contractor must notify the Engineer, and all municipalities, police department, and fire departments involved of all work that might affect the mobility or access of the fire or police department 48 hours in advance of their implementation. In addition, the contractor shall ensure that hydrants and alarm boxes are kept clear and accessible
- The Contractor shall provide a flagger with appropriate signing whenever operations interfere with traffic. Examples include, but are not limited to: delivery and removal of materials, lift operations, restricted sight distances, impedance of normal traffic flow and other activities. Cost shall be included in item 619.01.
- All single type III construction barricades and drums shall be of like new and shall require type C - Low Intensity", steady lights unless
- Type A flashing low intensity warning lights shall be mounted on the first three drums in a taper. Cost to be included under item 619.01.
- For nighttime work, Type B flashing high intensity warning lights shall be mounted on all warning signs ("w-series"). Cost to be included under tem 619.01.
- Pedestrian access to businesses must be maintained throughout the construction process. In order to maintain access to existing building, the Contractor must provide ramps with handrails if the sidewalk is not
- responsibility of the Contractor. The maintenance of traffic for both pedestrians and vehicles shall be the
- X:\HIGHWAYS\ROADS\Warburton Ave (CR 75-1)\Contracts\16-526 WarburtonAveResurfacing\drawling\title.dwg, 11/1/2017-11:40:50 AM, When necessary the Contractor shall construct temporary ramps, crossovers, etc. to permit safe and easy passage through the contract area. He shall provide suitable areas and locations from the loading


serviced by motor buses. The Contractor shall be liable responsible for the materials and workmanship required to pro adequate and safe crossing structures for pedestrians. and unloading of passengers on roads within the contract limits that are ble and provide

Construction Signage

- 12 grade retroflective sheeting no. 4370, or approved equal. Sign materials must be in compliance with most recent version of NYSDOT specifications and MUTCD/NYS Supplement. All signs are to be in good condition with Type IV characters. Faded and deteriorated panels, as black letters and border unless otherwise specified, orange construction sign material requirements shall be: 1) Scotchlife durable fluorescent diamond grade sheeting (3924)g orange) as manufactured by the 3m All construction signs shall have a fluorescent orange background and well as non-standard text will not be acceptable. or 2) Stimsomite's fluorescent orange high-
- 13. The contractor shall erect signs to provide proper horizontal and vertical
- <u>‡</u> As per the MUTCD and NYS Supplement, the following stipulations shall apply unless otherwise specified by the Engineer:
- A. Where signs are shown in both diamond and rectangular shapes, only diamond shapes will be permitted, except in median applications where the rectangular signs will be used as specified by the Engineer.
- B. Where signs are shown in alternate sizes, the largest size must be used unless otherwise specified by the Engineer, or as shown on the plans.
- 55 In addition to the signing shown on the Basic Work Traffic Control plans, the Contractor shall also erect G11-1C, "road work, next____miles" signs. The Contractor shall also erect W8-1D, "road work ahead" signs signs. The Contract shall also erect W8-1D, "road work ahead" signs at intersecting cross streets within the contract limits. Payment for these signs will be made under Item 619.xx.
- 6. The contractor shall place W4-1 "bump" signs, W4-2 "dip" signs and/or W4-4 "rough road" signs where directed by the Engineer.
- 17. standard specifications. Existing traffic signs and construction signs within the work area which are no longer needed, even temporarily, or are conflicting, inappropriate or confusing, shall be removed (subject to the approval of the engineer) or shall be covered completely with an opaque material, the cost of this work shall be included in the price bid The Contractor's attention is directed to subsections 619-3.02H of the for the maintenance and protection of traffic item.
- <u>,</u> Type B - High Intensity, flashing lights are required on all W20 Advance Warning Signs.


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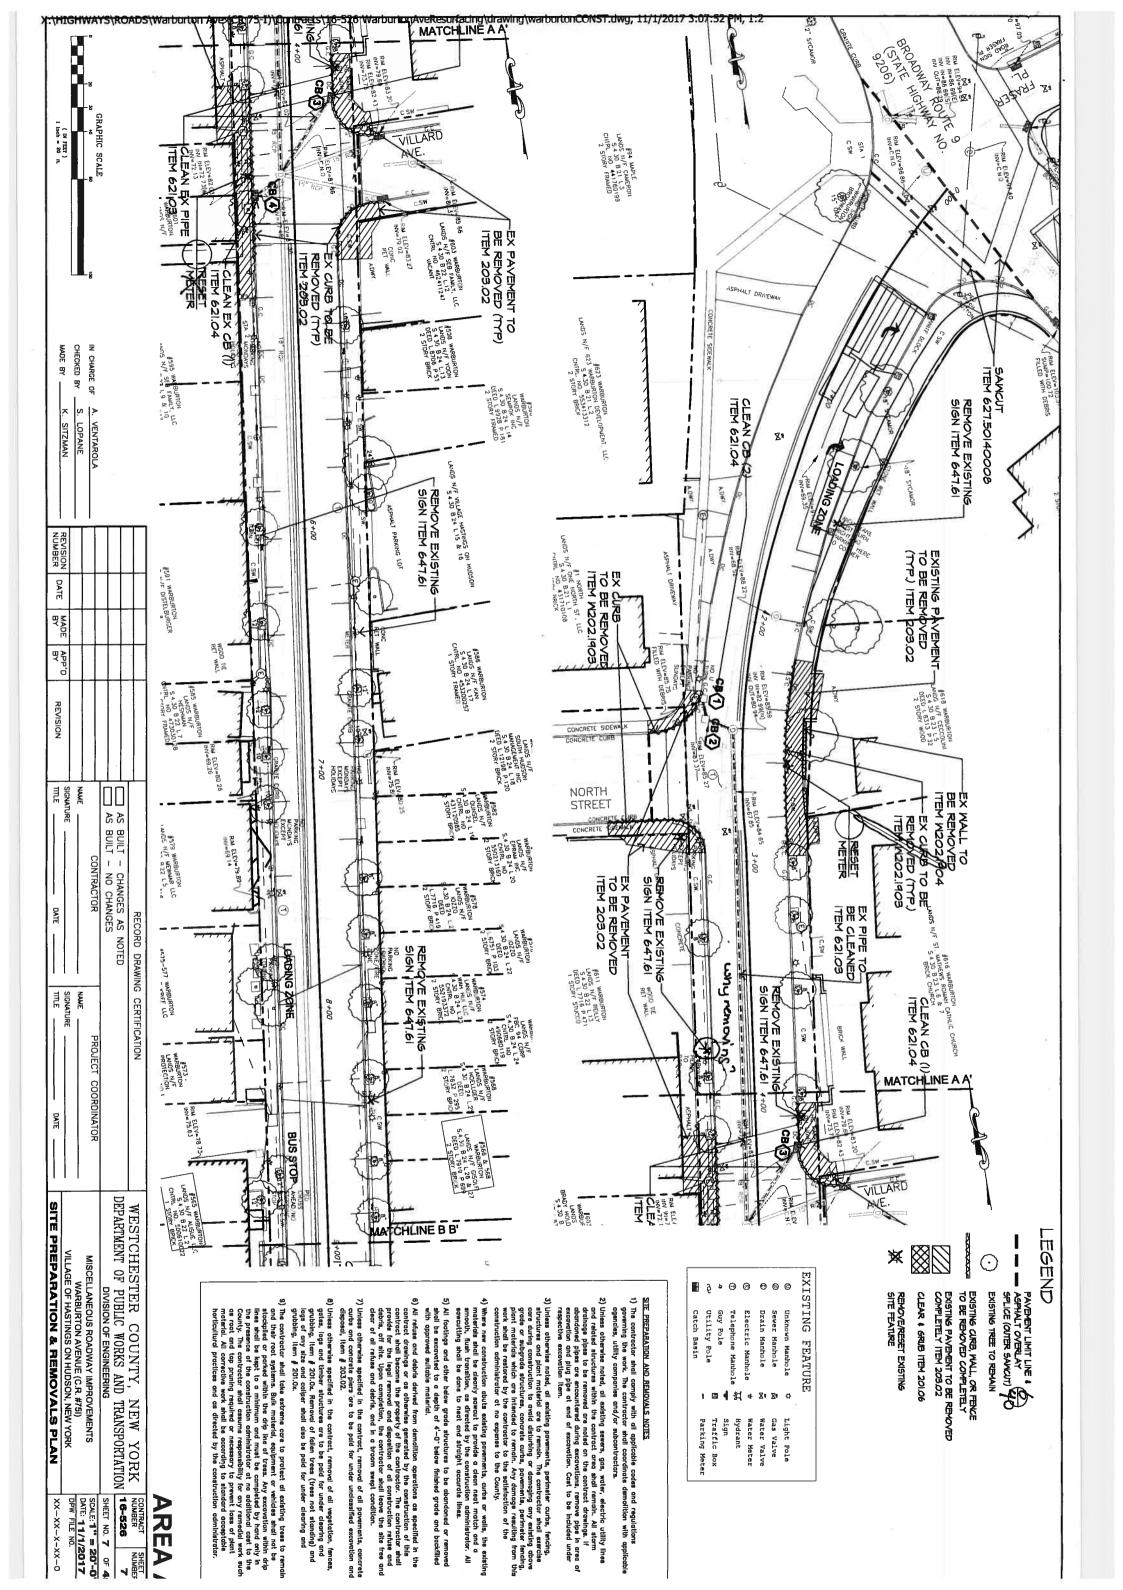
- WHEN CROSSWALKS OR OTHER PEDESTRIAN FACILITIES ARE CLOSED OR RELOCATED, TEMPORARY FACILITIES SHALL BE DETECTABLE AND SHALL INCLUDE ACCESSIBILITY FEATURES CONSISTENT WITH THE FEATURES PRESENT IN THE EXISTING FACILITY.
- CURB PARKING SHALL BE PROHIBITED FOR AT LEAST 50' IN ADVANCE OF THE MID-BLOCK CROSSWALK.
- PEDESTRIAN TRAFFIC SIGNAL DISPLAYS CONTROLLING CLOSED CROSSWALKS SHOULD BE COVERED OR DEACTIVATED
- ONLY THE WORK ZONE TRAFFIC CONTROL DEVICES RELATED TO PEDESTI-SIGNING OR ROAD NARROWS SIGNS (W5-4), MAY BEUSED TO CONTROL RIANS ARE SHOWN. OTHER DEVICES, SUCH AS LANE CLOSURE VEHICULAR TRAFFIC.
- FOR NIGHTTIME CLOSURES, FLASHING WARNING LIGHTS SHALL BE USED ON BARRICADES SUPPORTING SIGNS AND CLOSING SIDEWALKS
- FOR LONG-TERM STATIONARY WORK, THE DOUBLE YELLOW CENTERLINE TEMPORARY CROSSWALK LINES. AND/OR LANE LINES SHOULD BE REMOVED BETWEEN THE
- AREA SHALL BE RECONSTRUCTED TO BE ACCESSIBLE TO PEDESTRIANS.
- ALL MID-BLOCK CROSSINGS REQUIRE THE APPROVAL OF THE REGIONAL DIRECTOROR HIS/HER DESIGNEE.
- Type II Barricades may be substituted for type III Barricades as per 619 Standard Specifications.

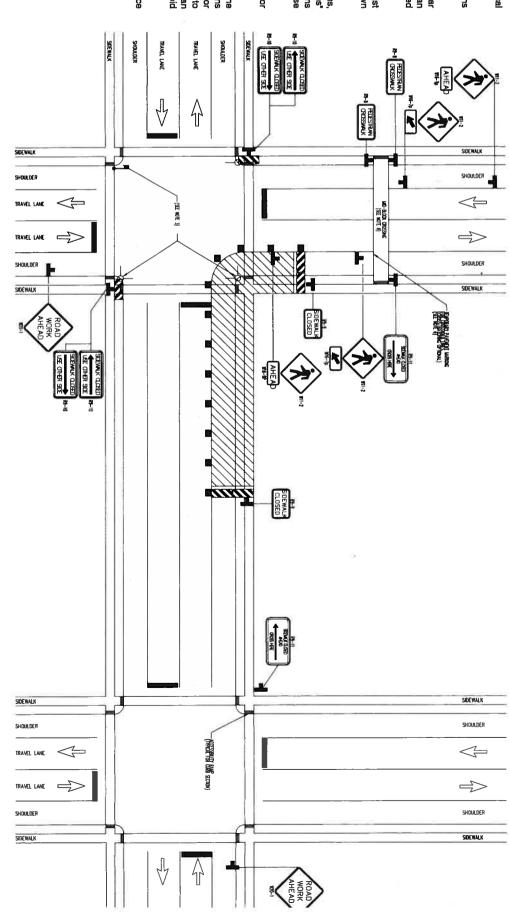



CROSSWALK CLOSURE ON 2-LANE SHORT, INTERMEDIATE, OR LONG CROSSWALK CLOSURE AND PEDESTRIAN DETOUR HORT, INTERMEDIATE, OR LONG TERM STATIONARY (NOT TO SCALE) 2-WAY ROADWAY


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BASIC WORK TRAFFIC CONTROL PLANS I XX-XX-I	VILLAGE OF HASTINGS ON HUDSON, NEW YORK	WARBURTON AVENUE (C.R. #75I)	MISCELLANEOUS ROADWAY IMPROVEMENTS	DIVISION OF ENGINEERING		DETAKIMENI OF TOBLIC WORKS AND IKANSTOKIALION	מונים אווים ביים ווים ביים אווים ביים ביים ביים ביים ביים ביים ביים	TELL TELL CLEEK COCKET, NEW LOWER	MESUCATION COLINAR ALINIOS CELESTROLOS MESUCATION CONTRACT
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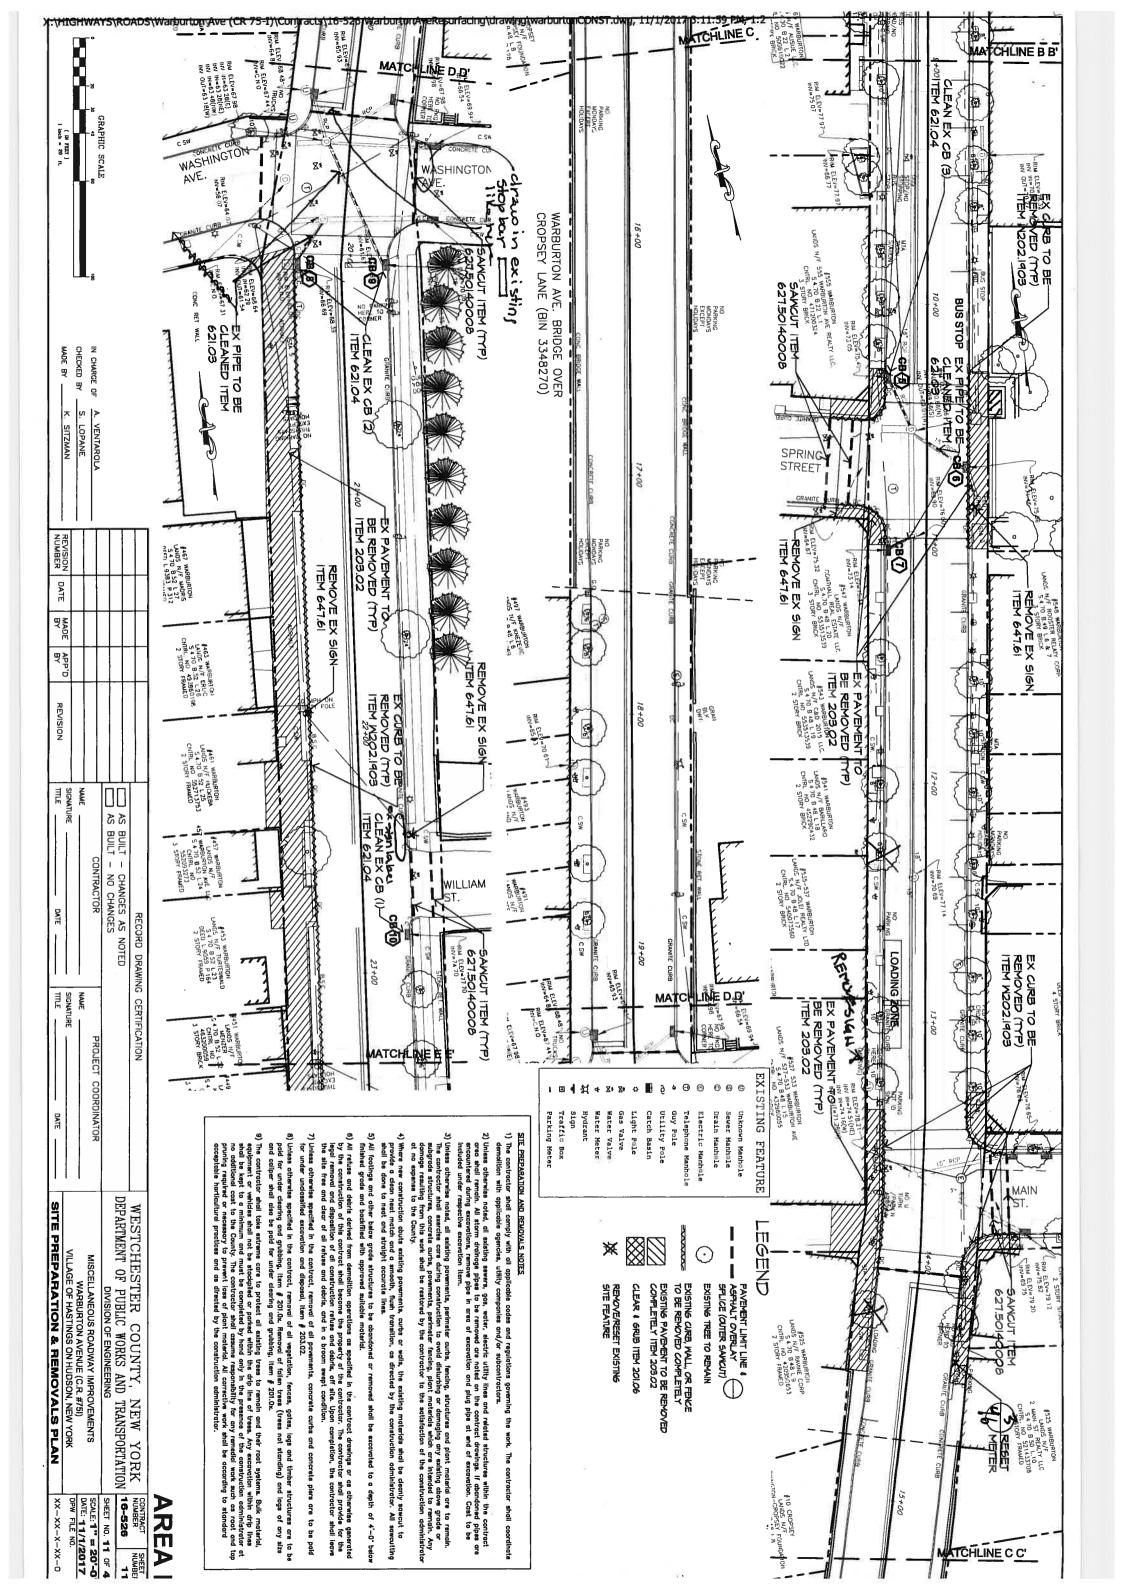





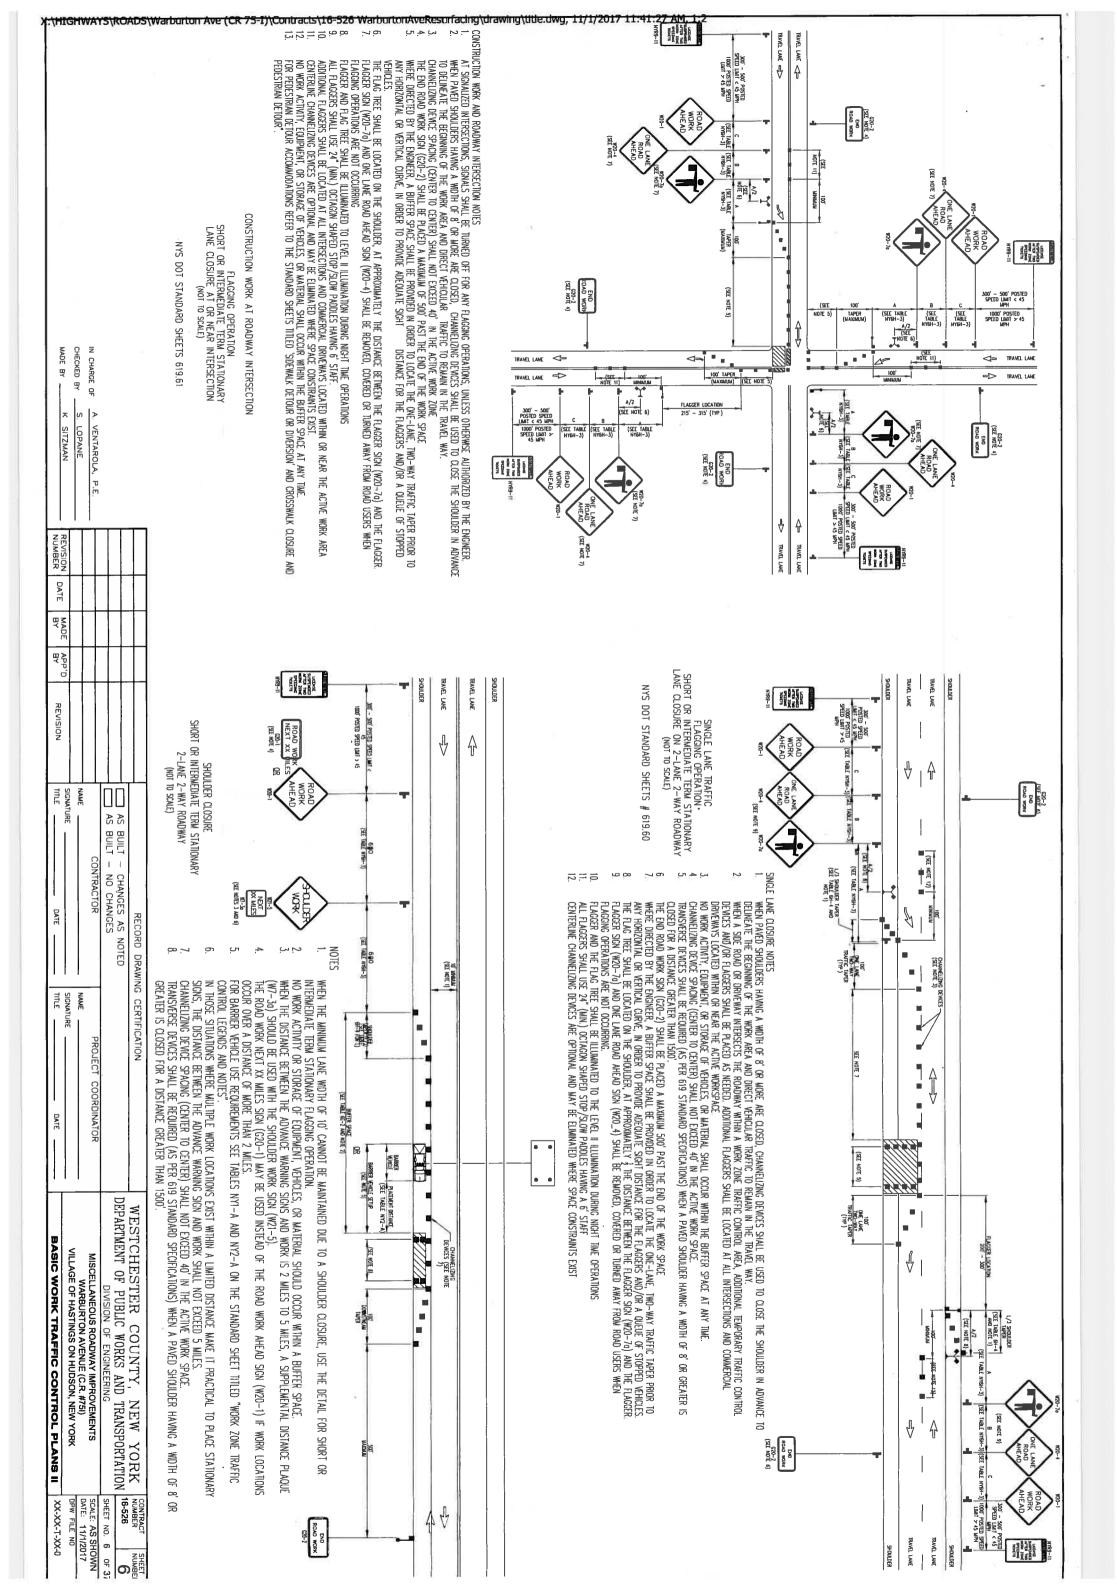


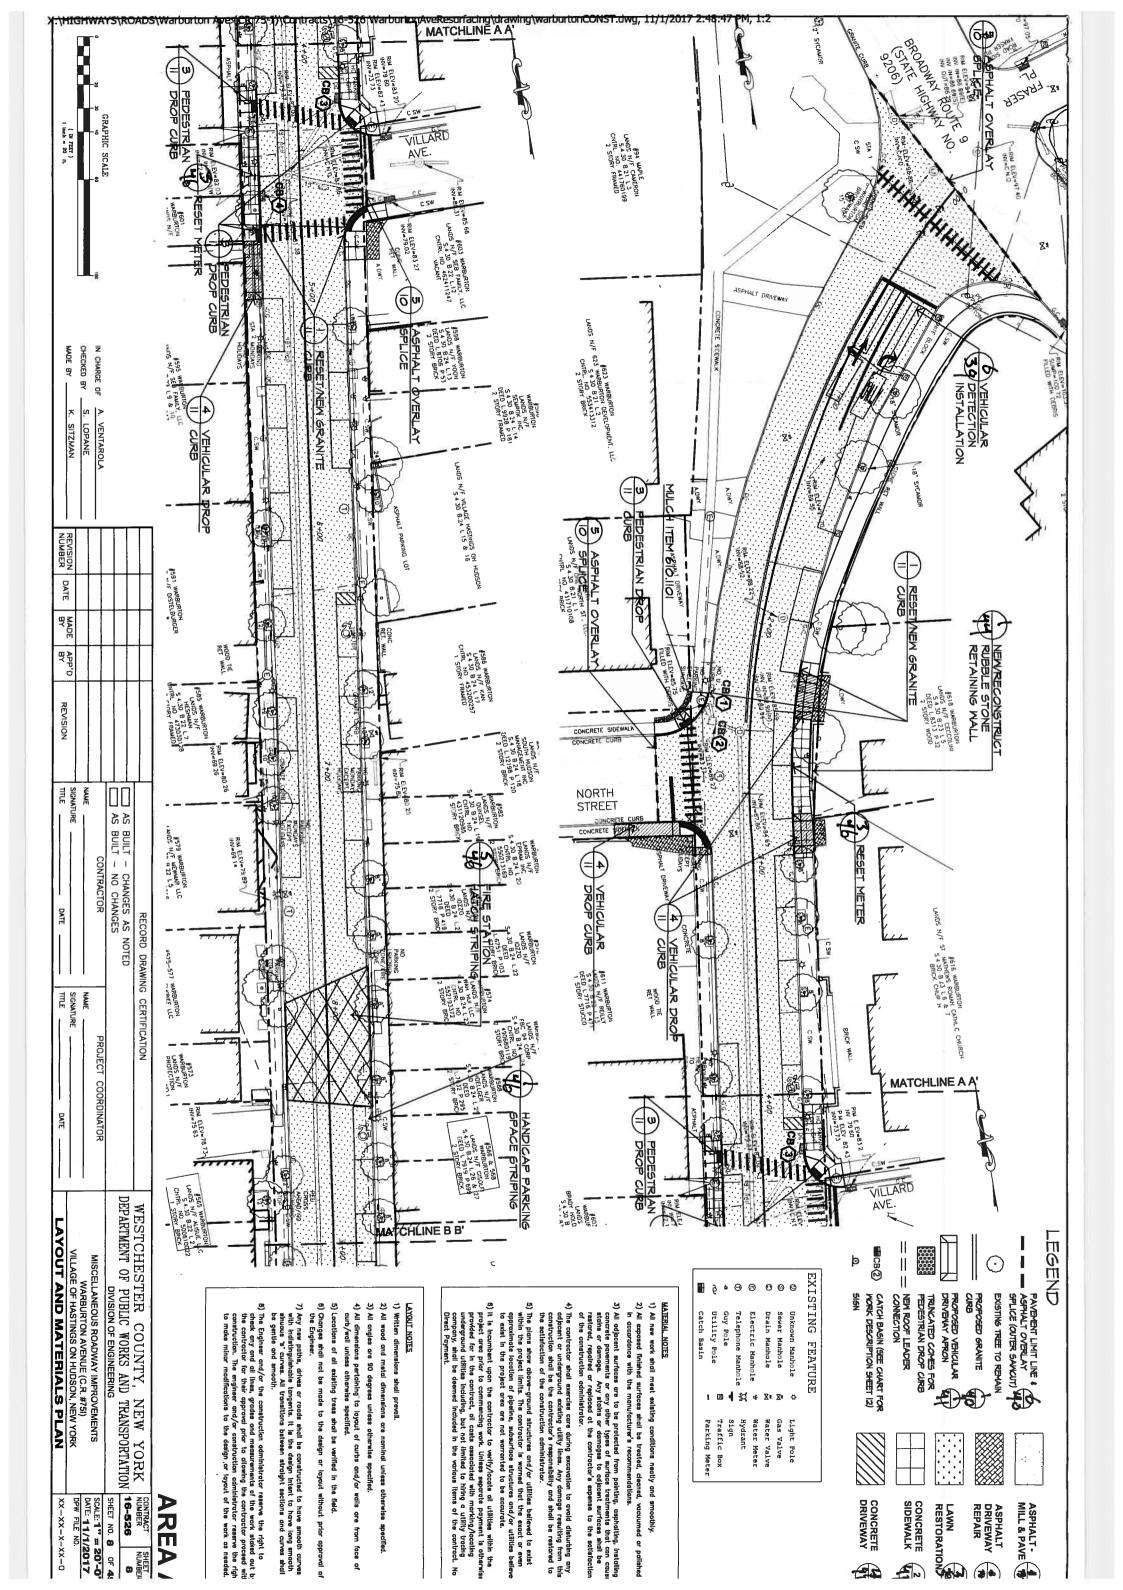


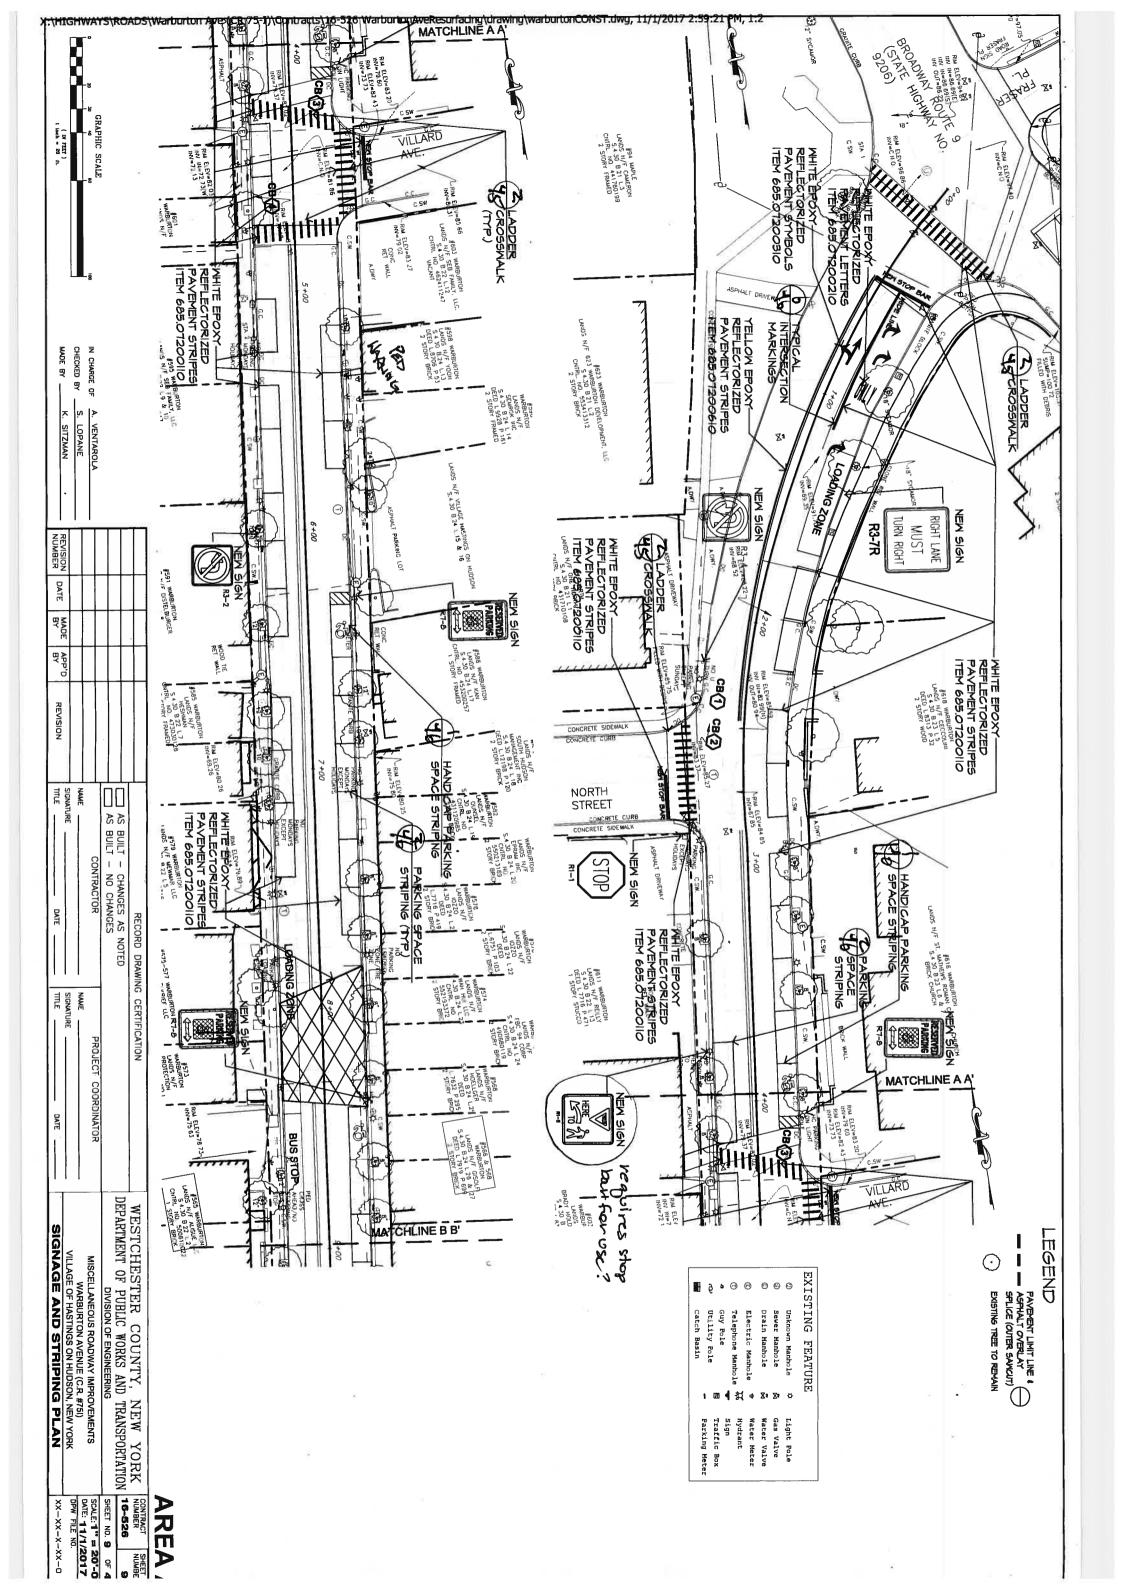


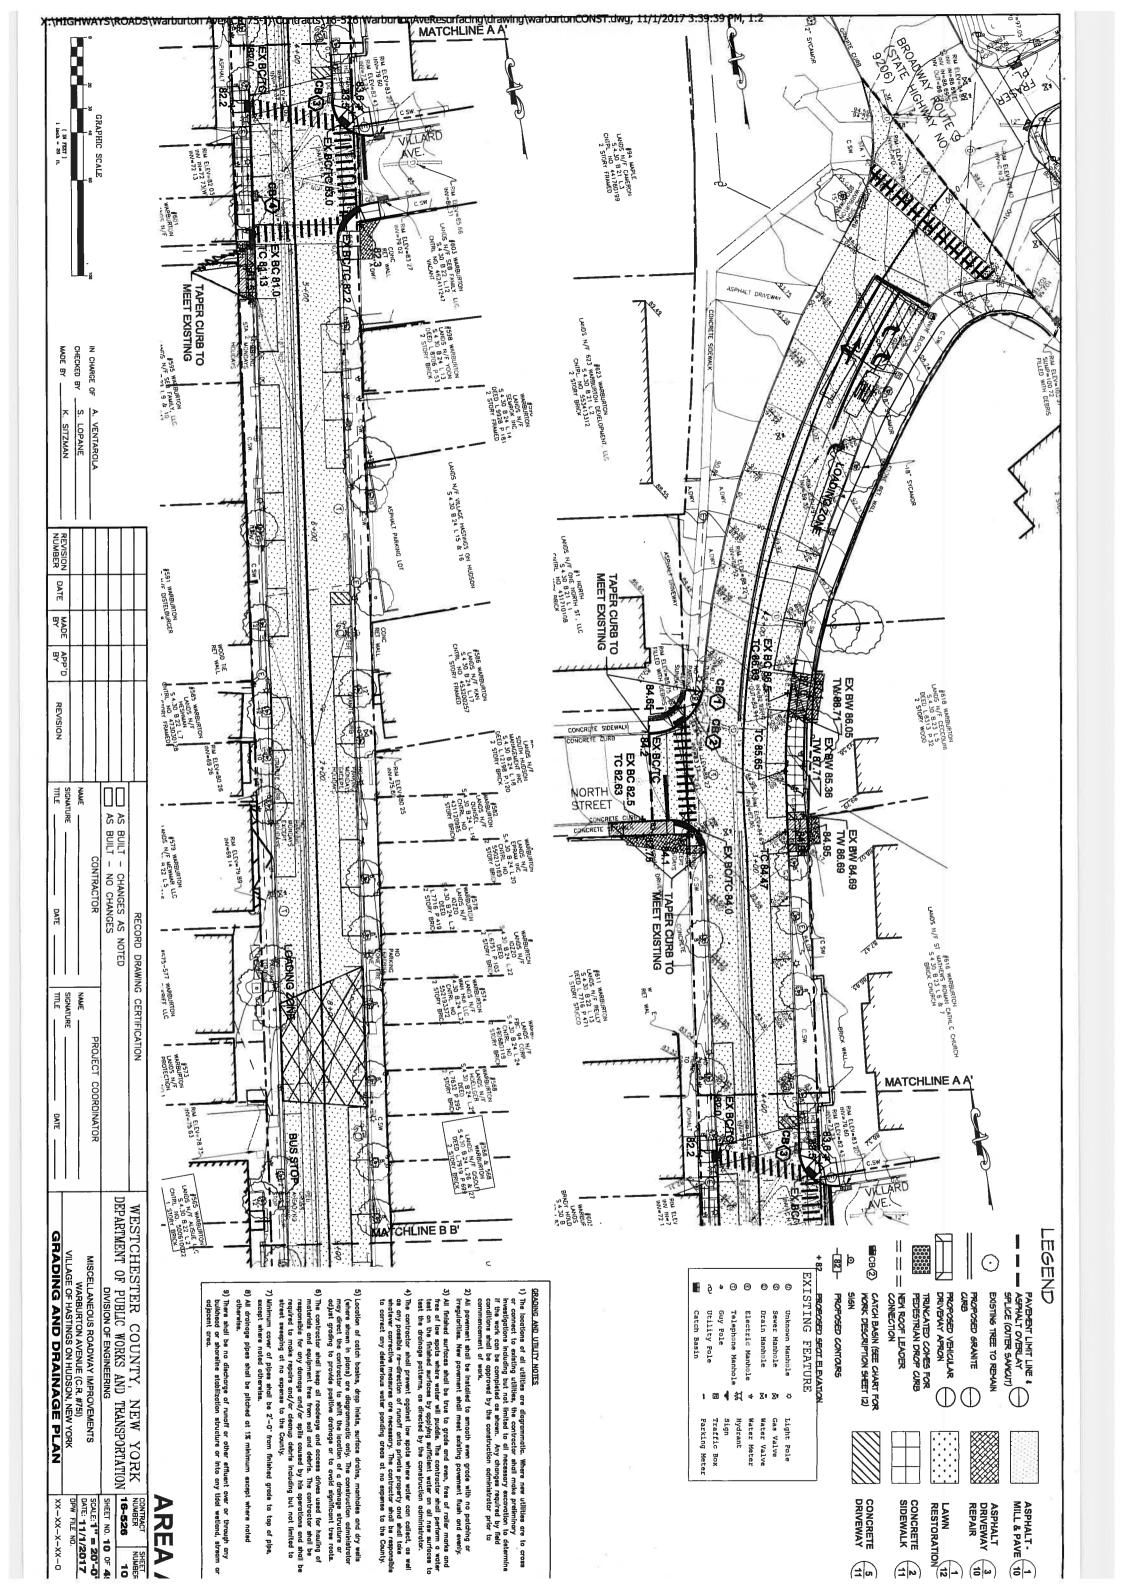


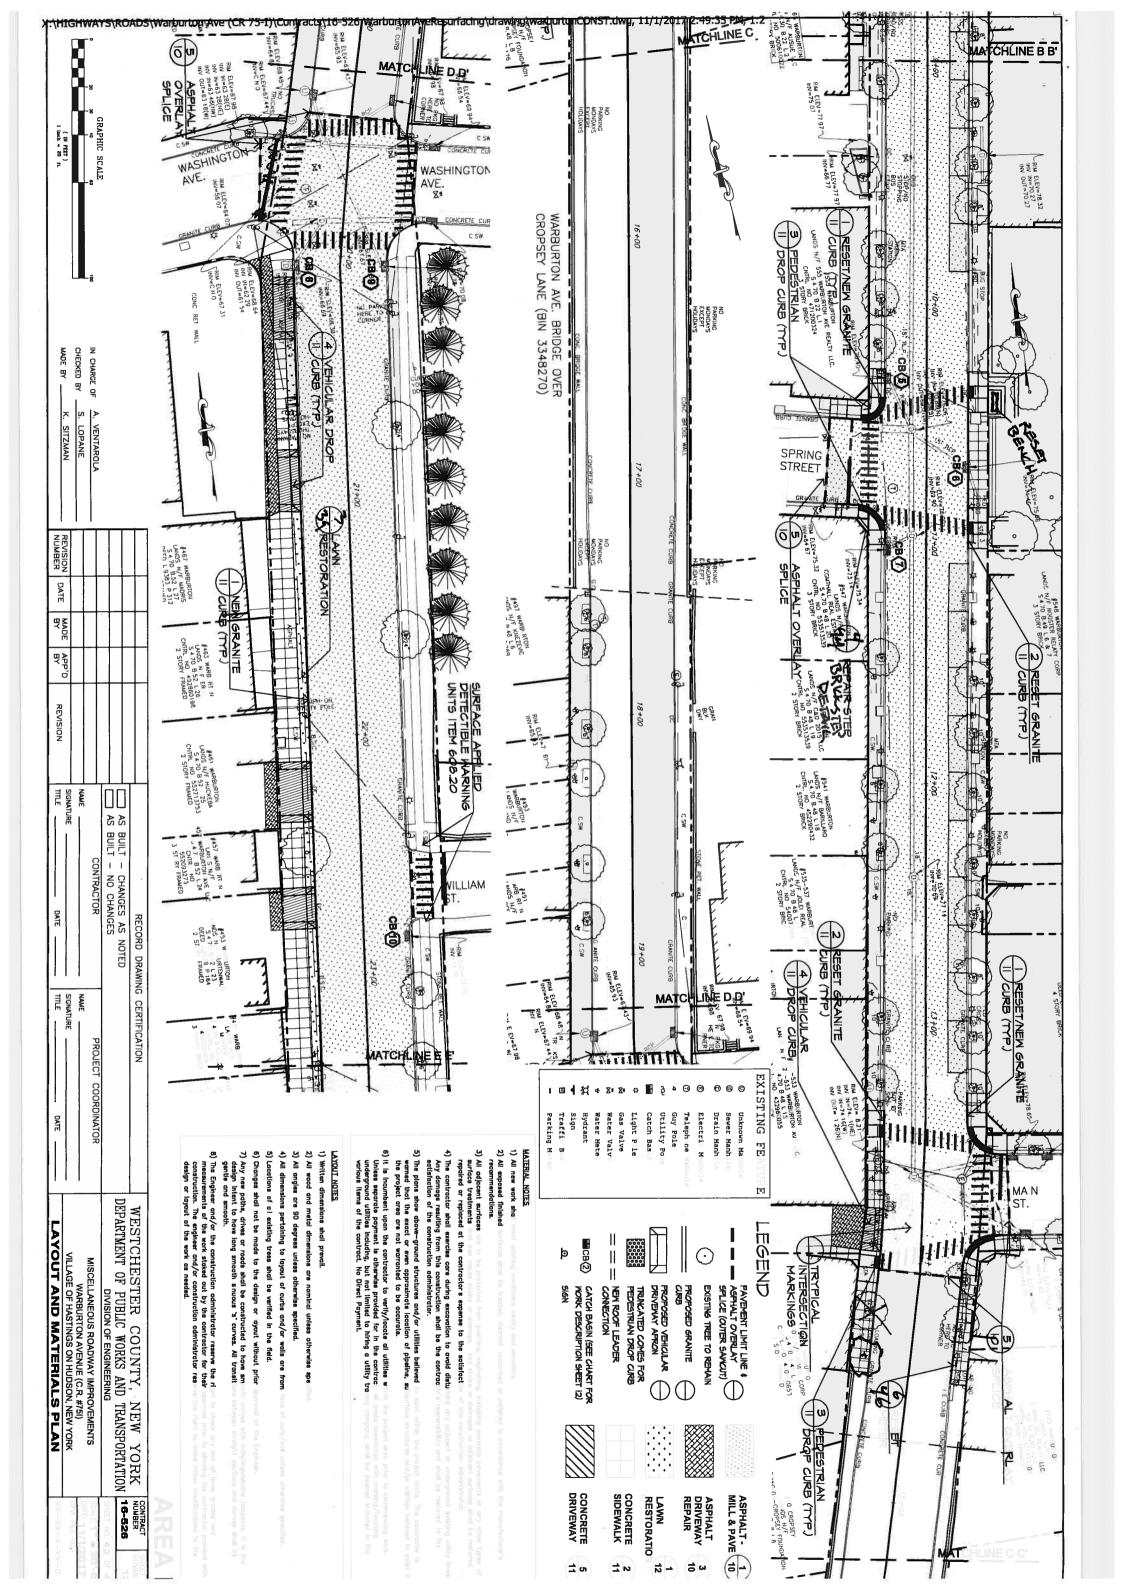


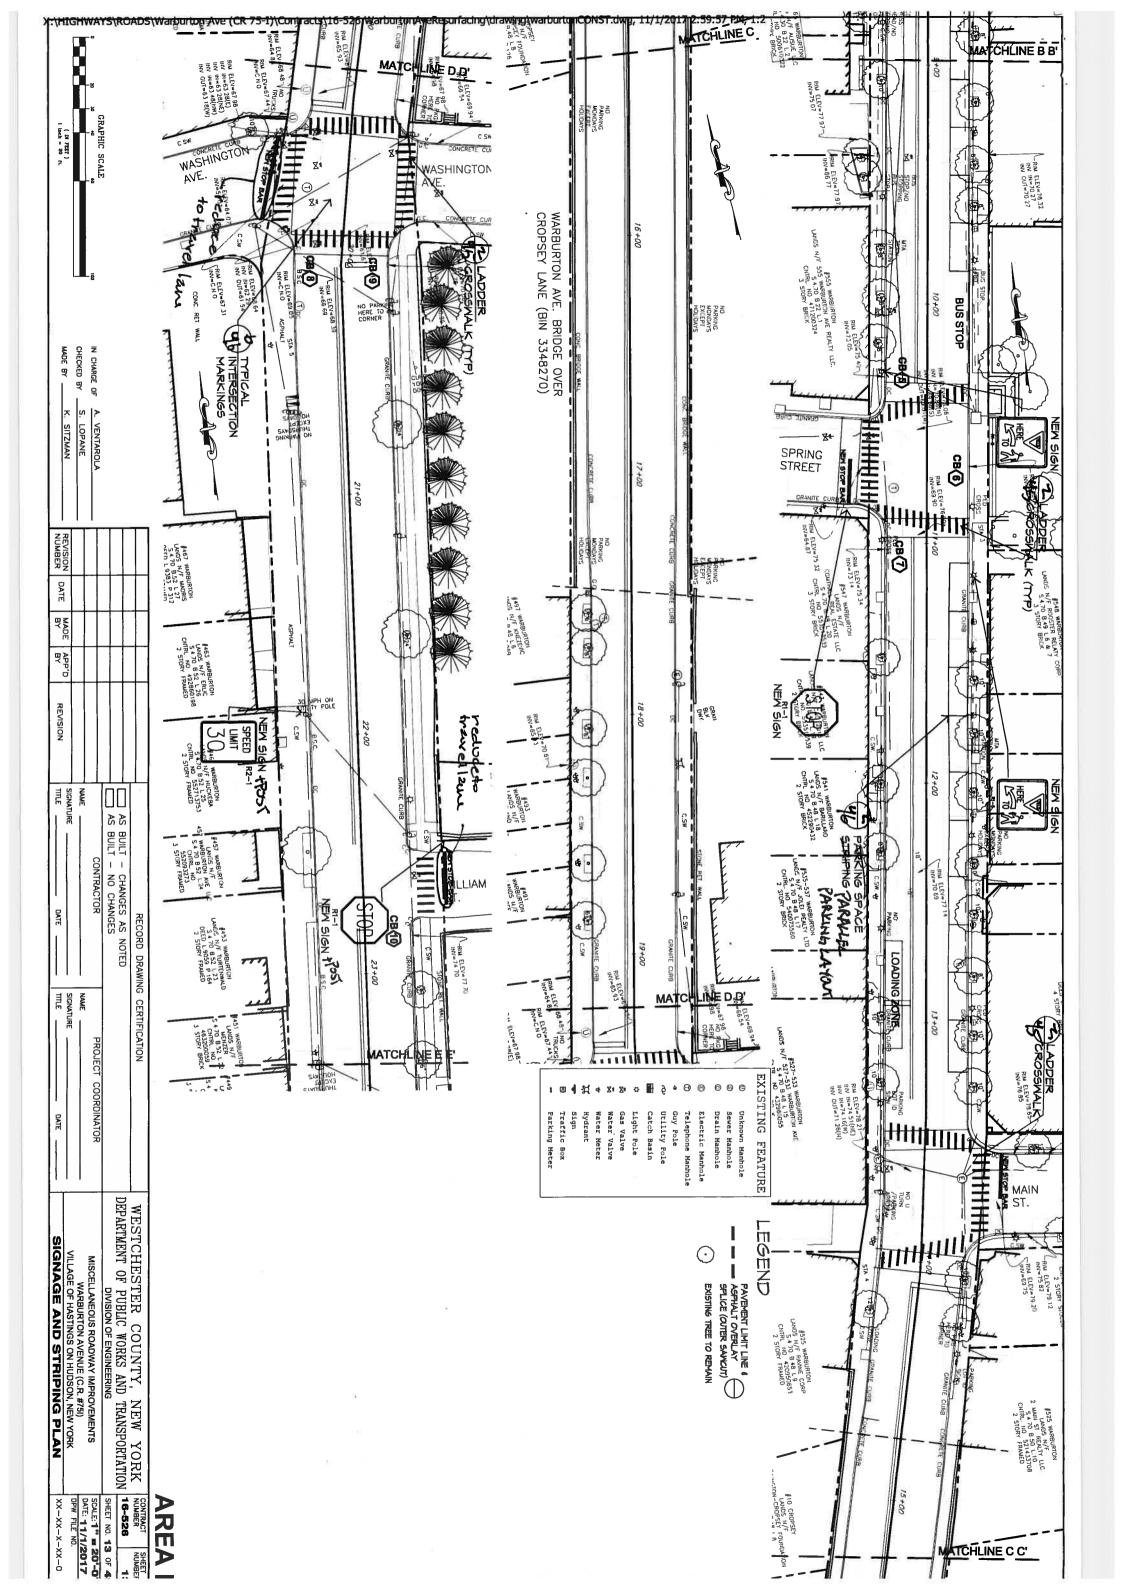


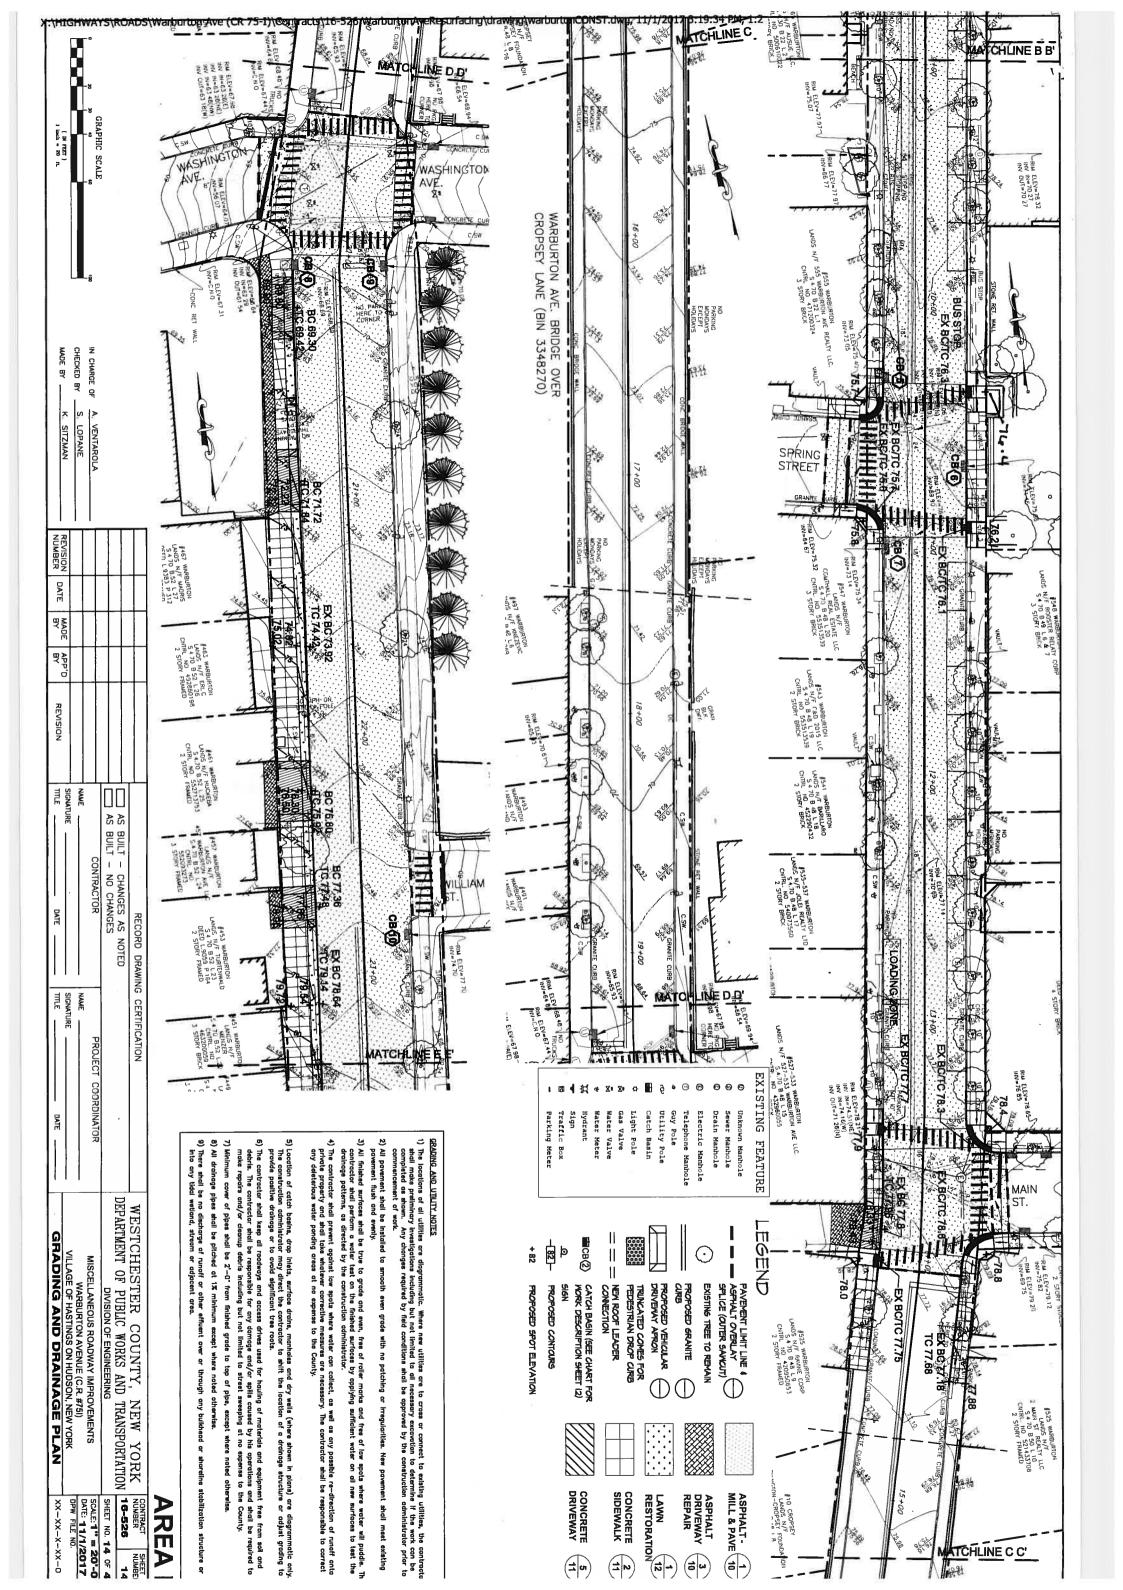


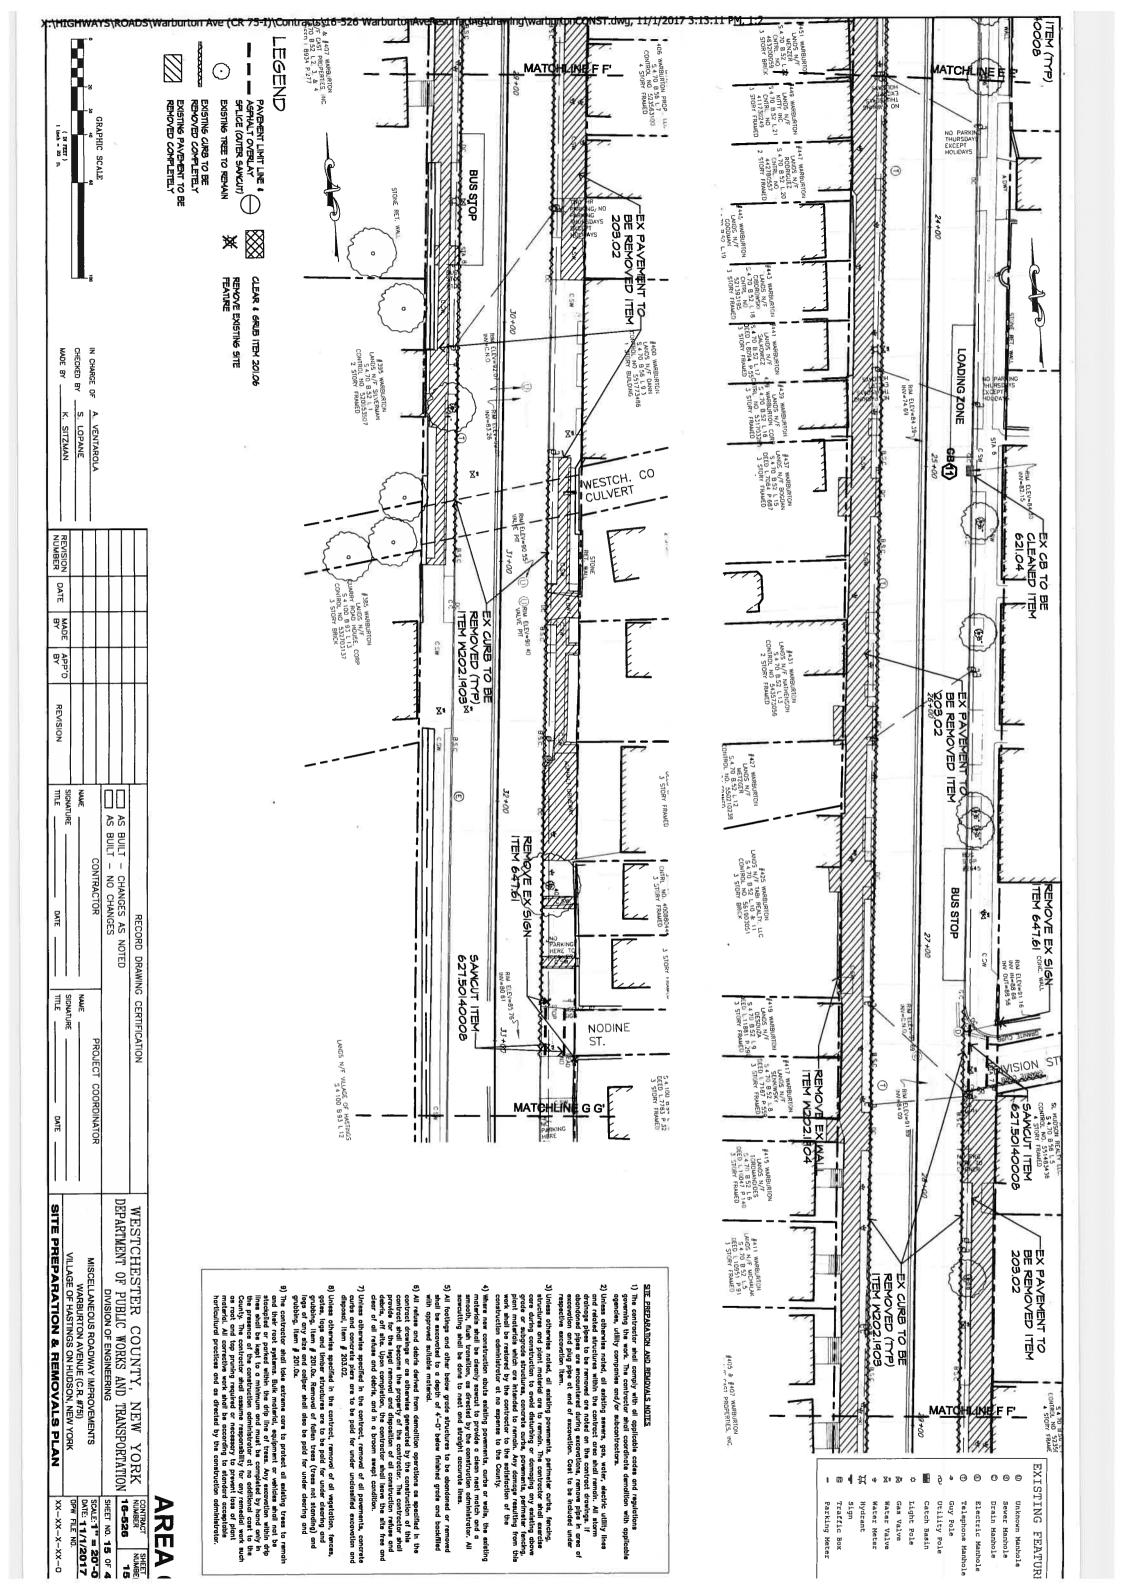


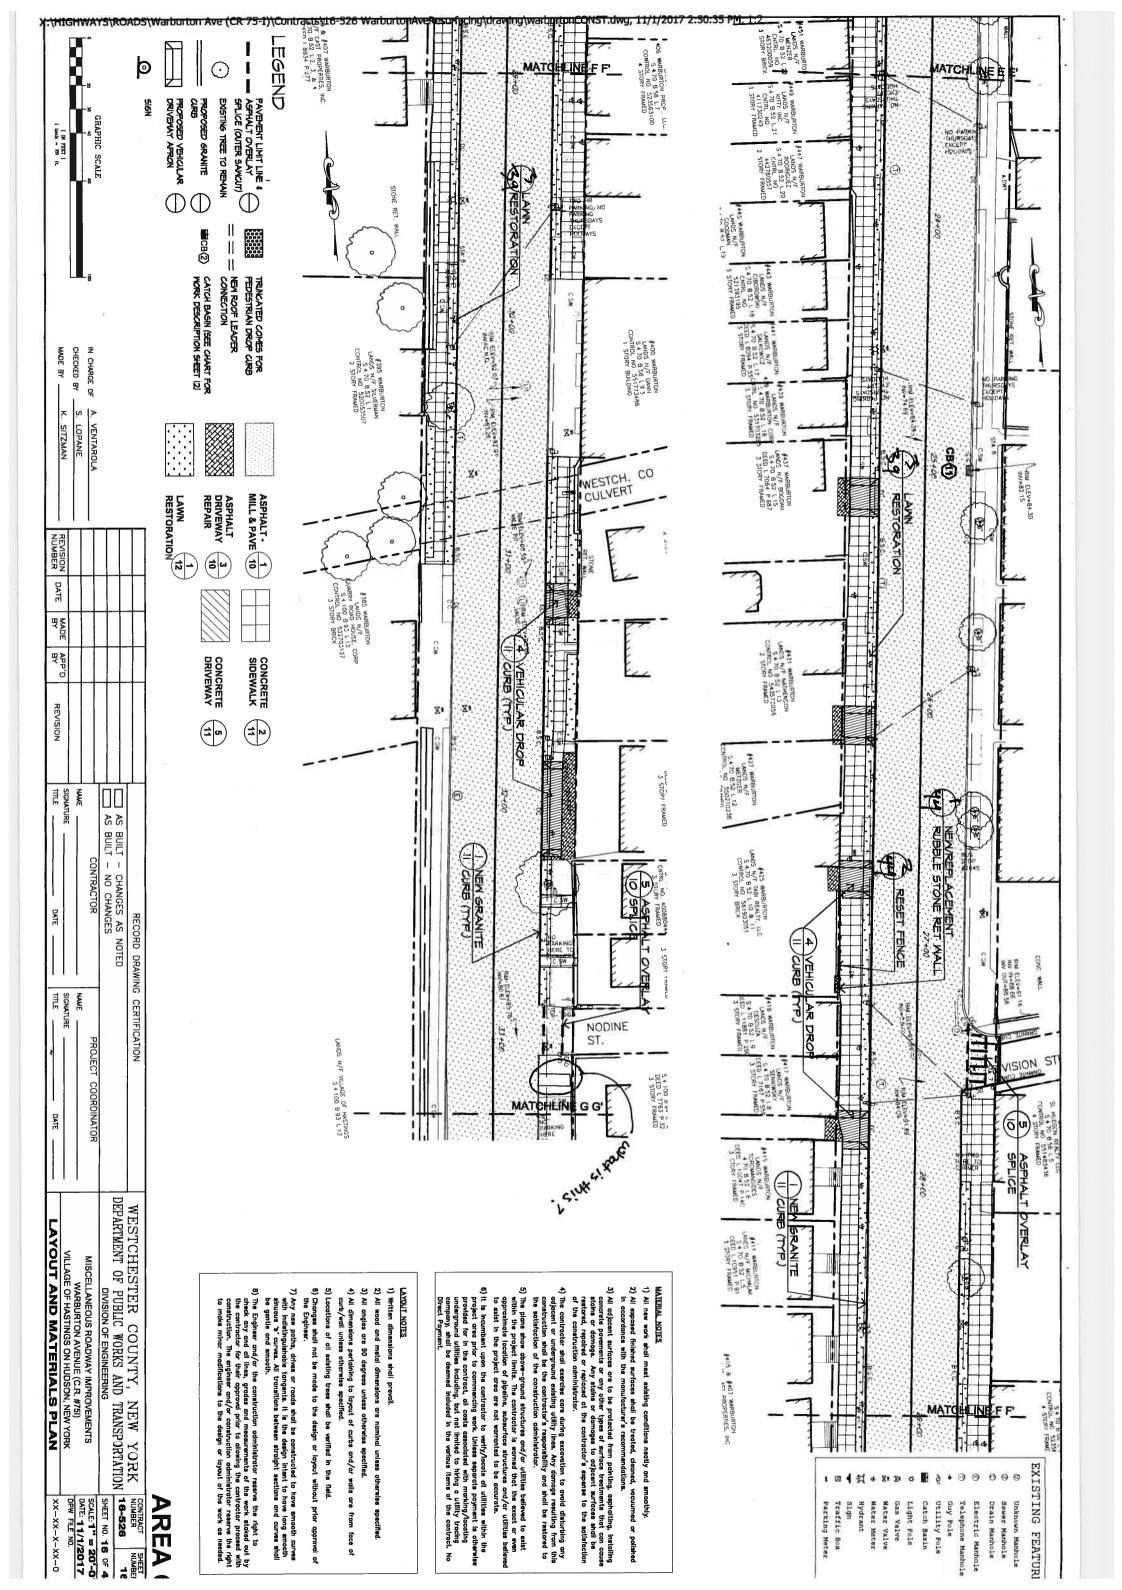


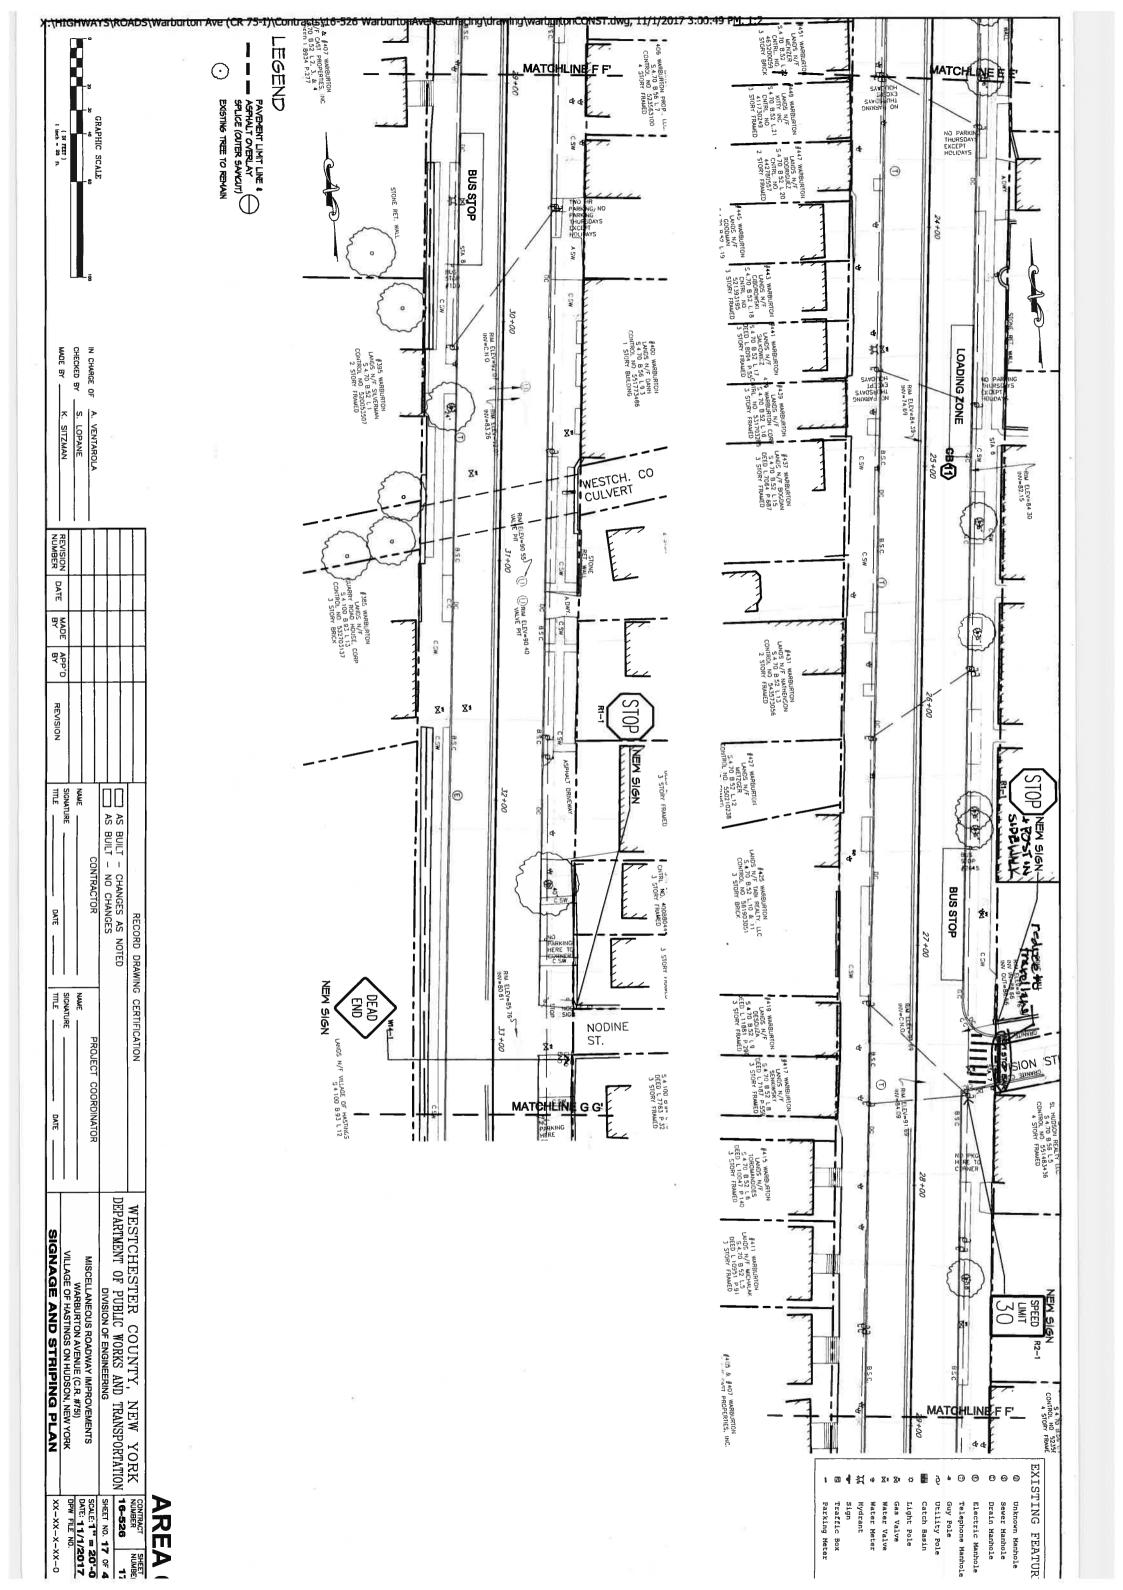


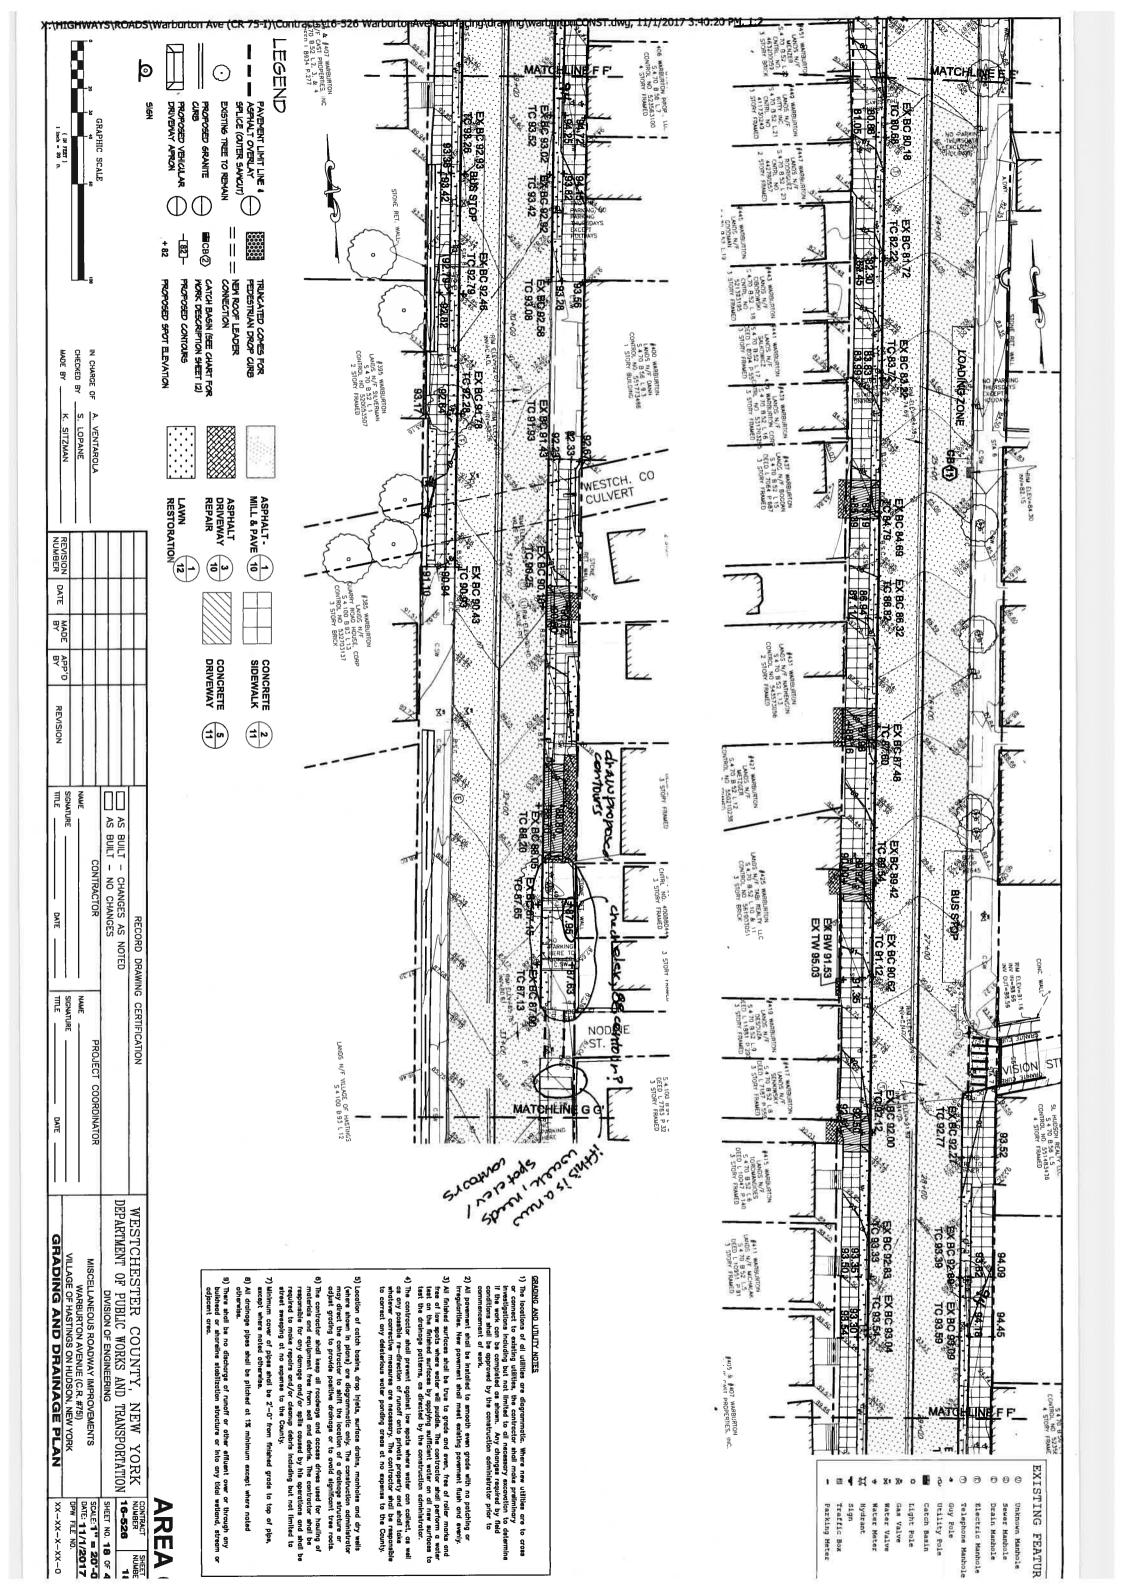


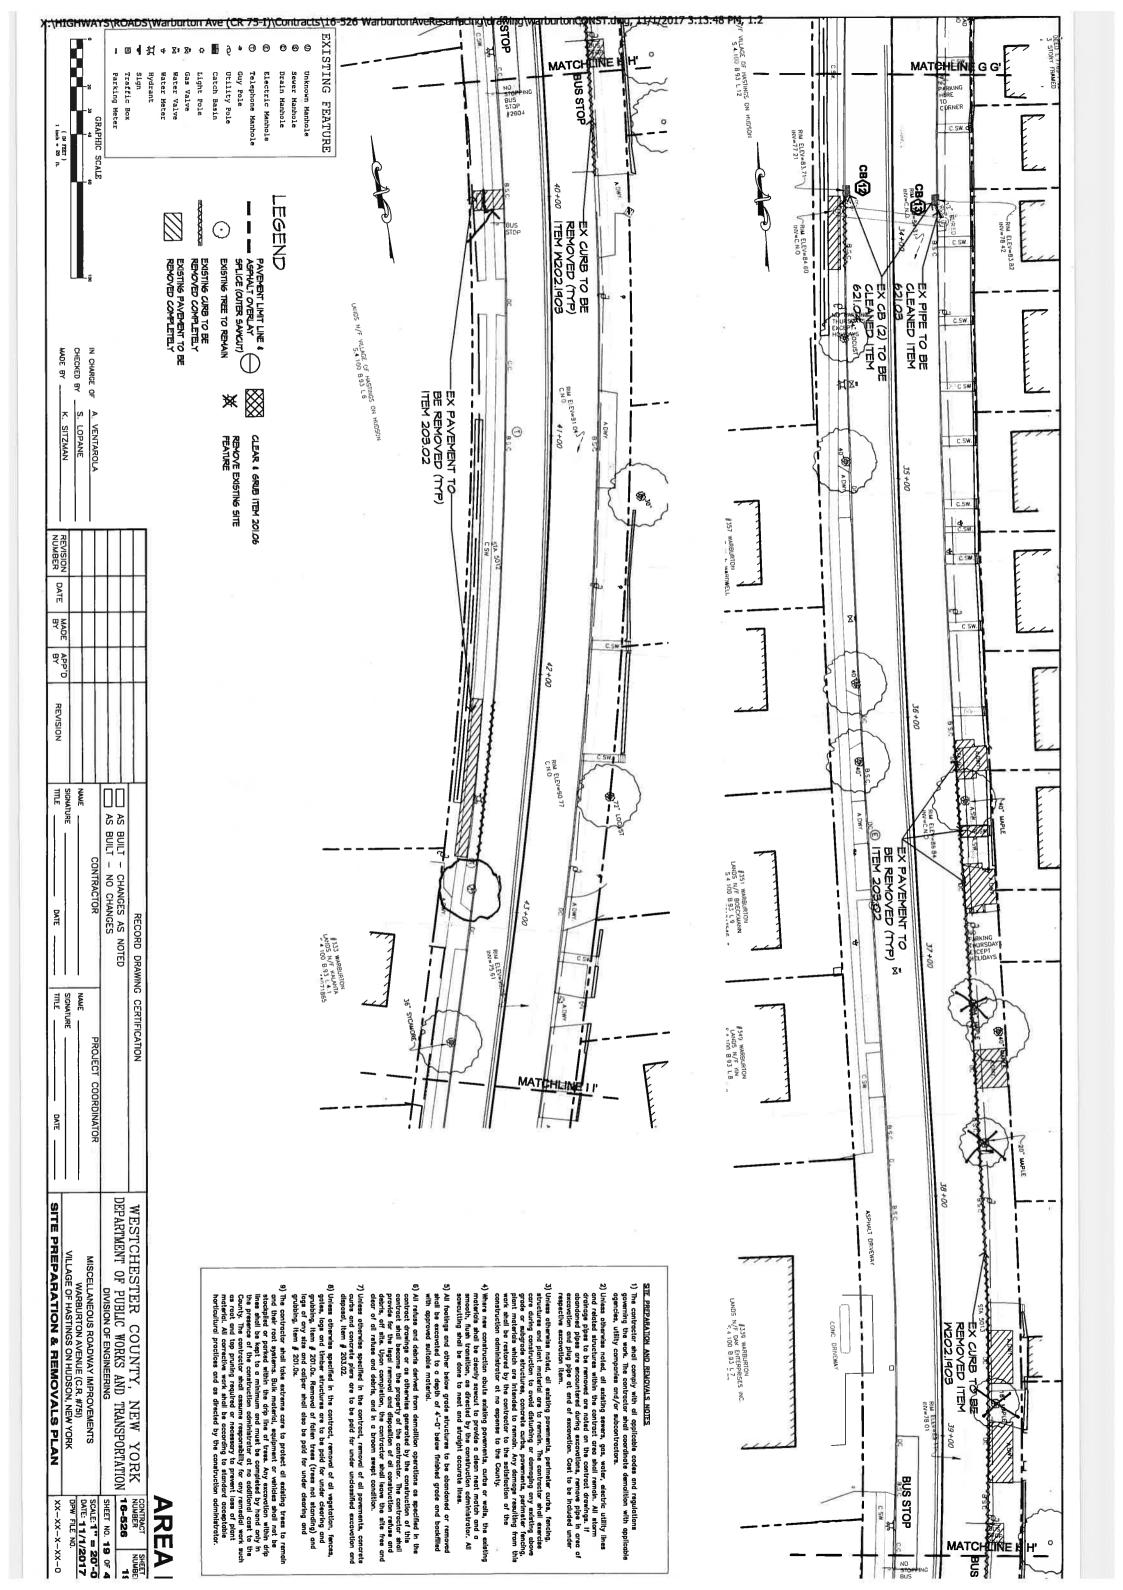


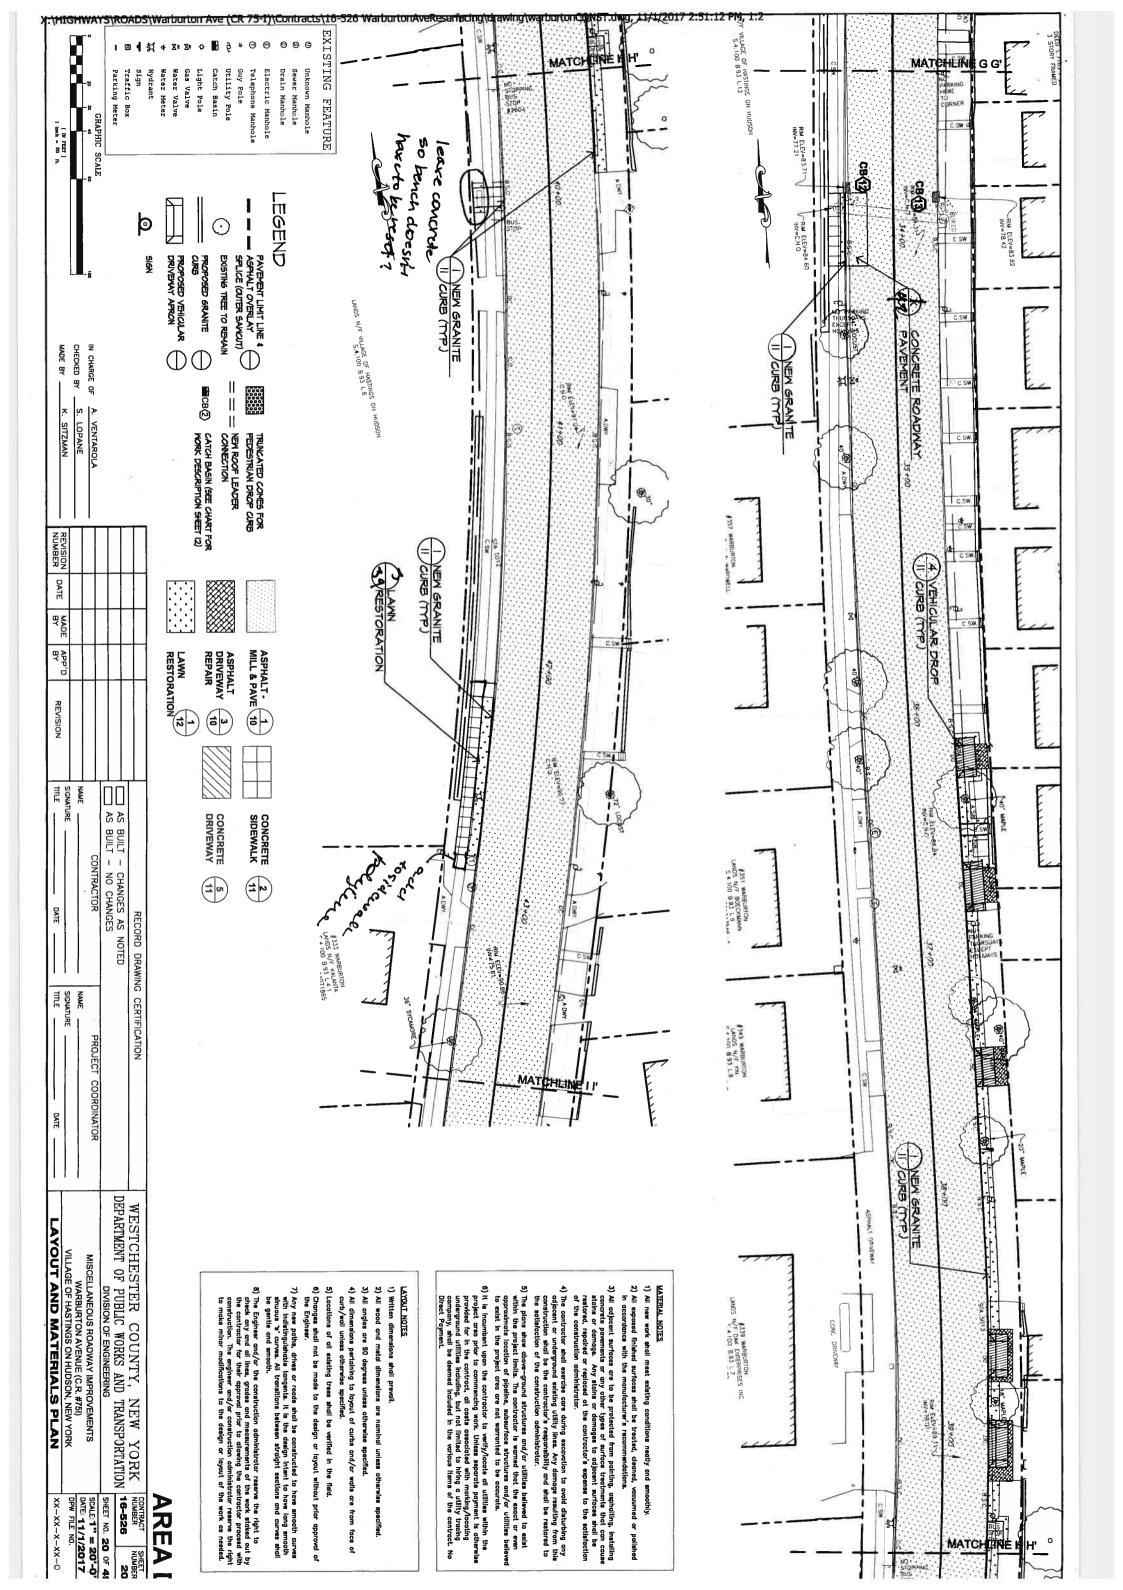


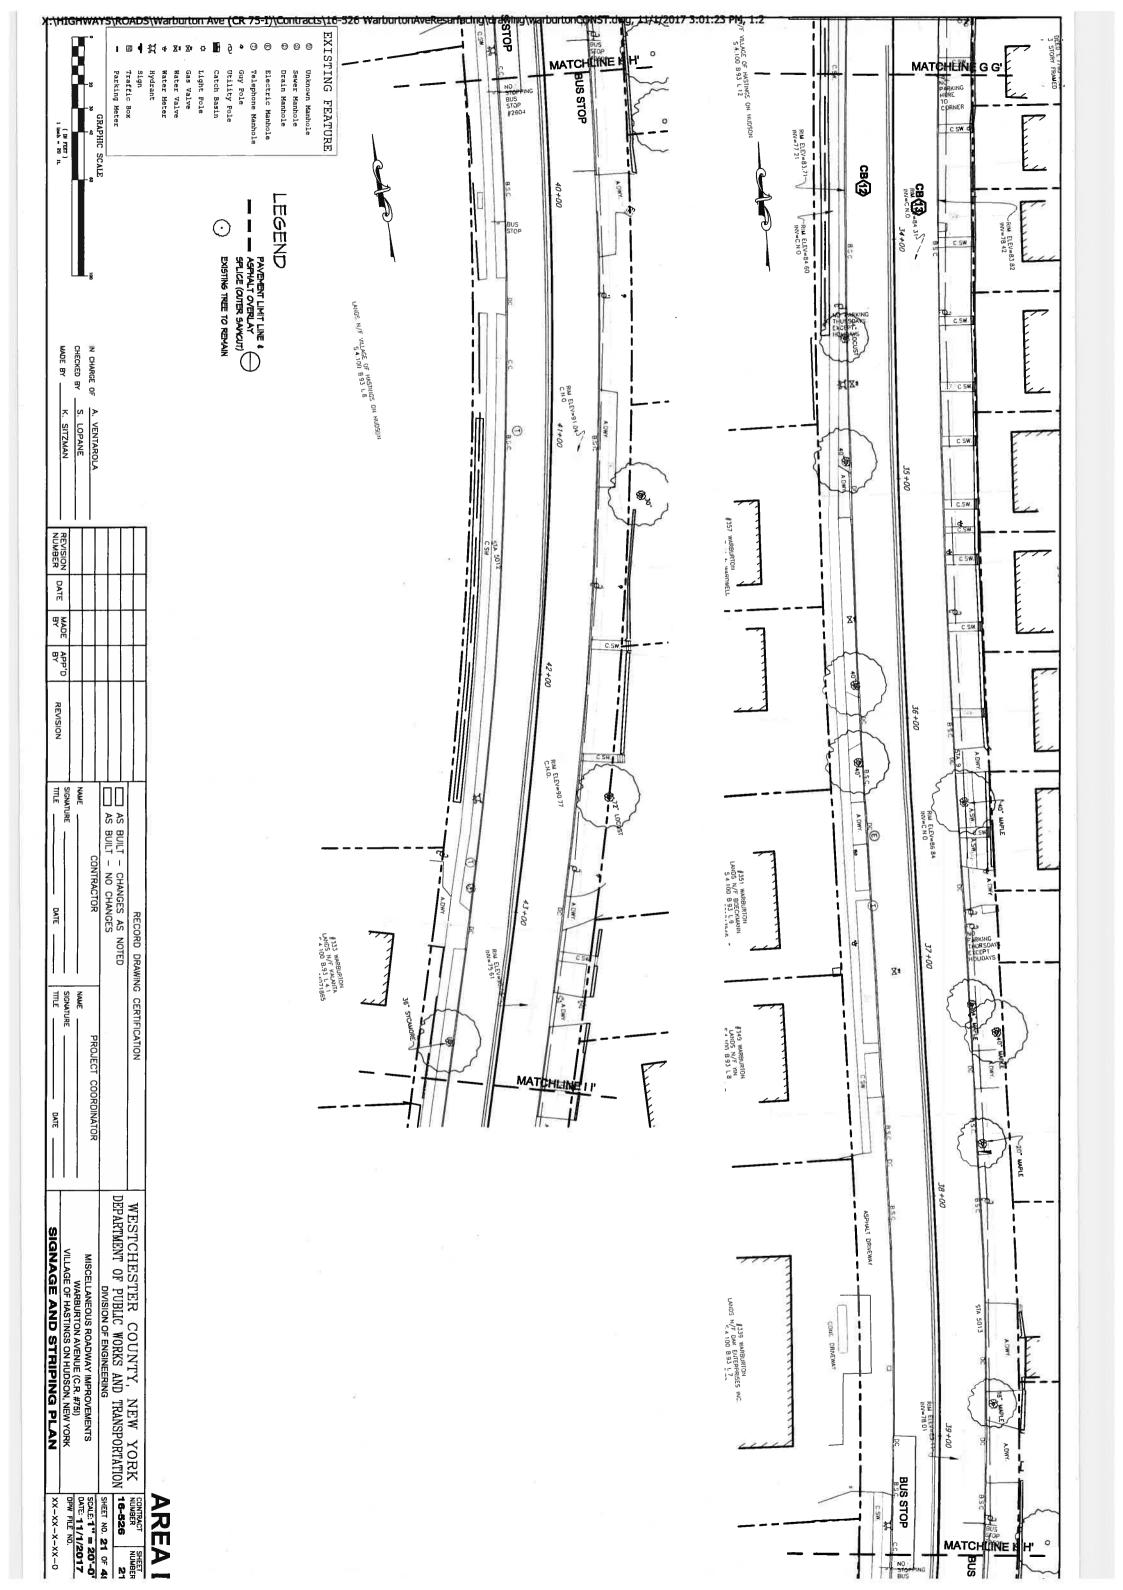


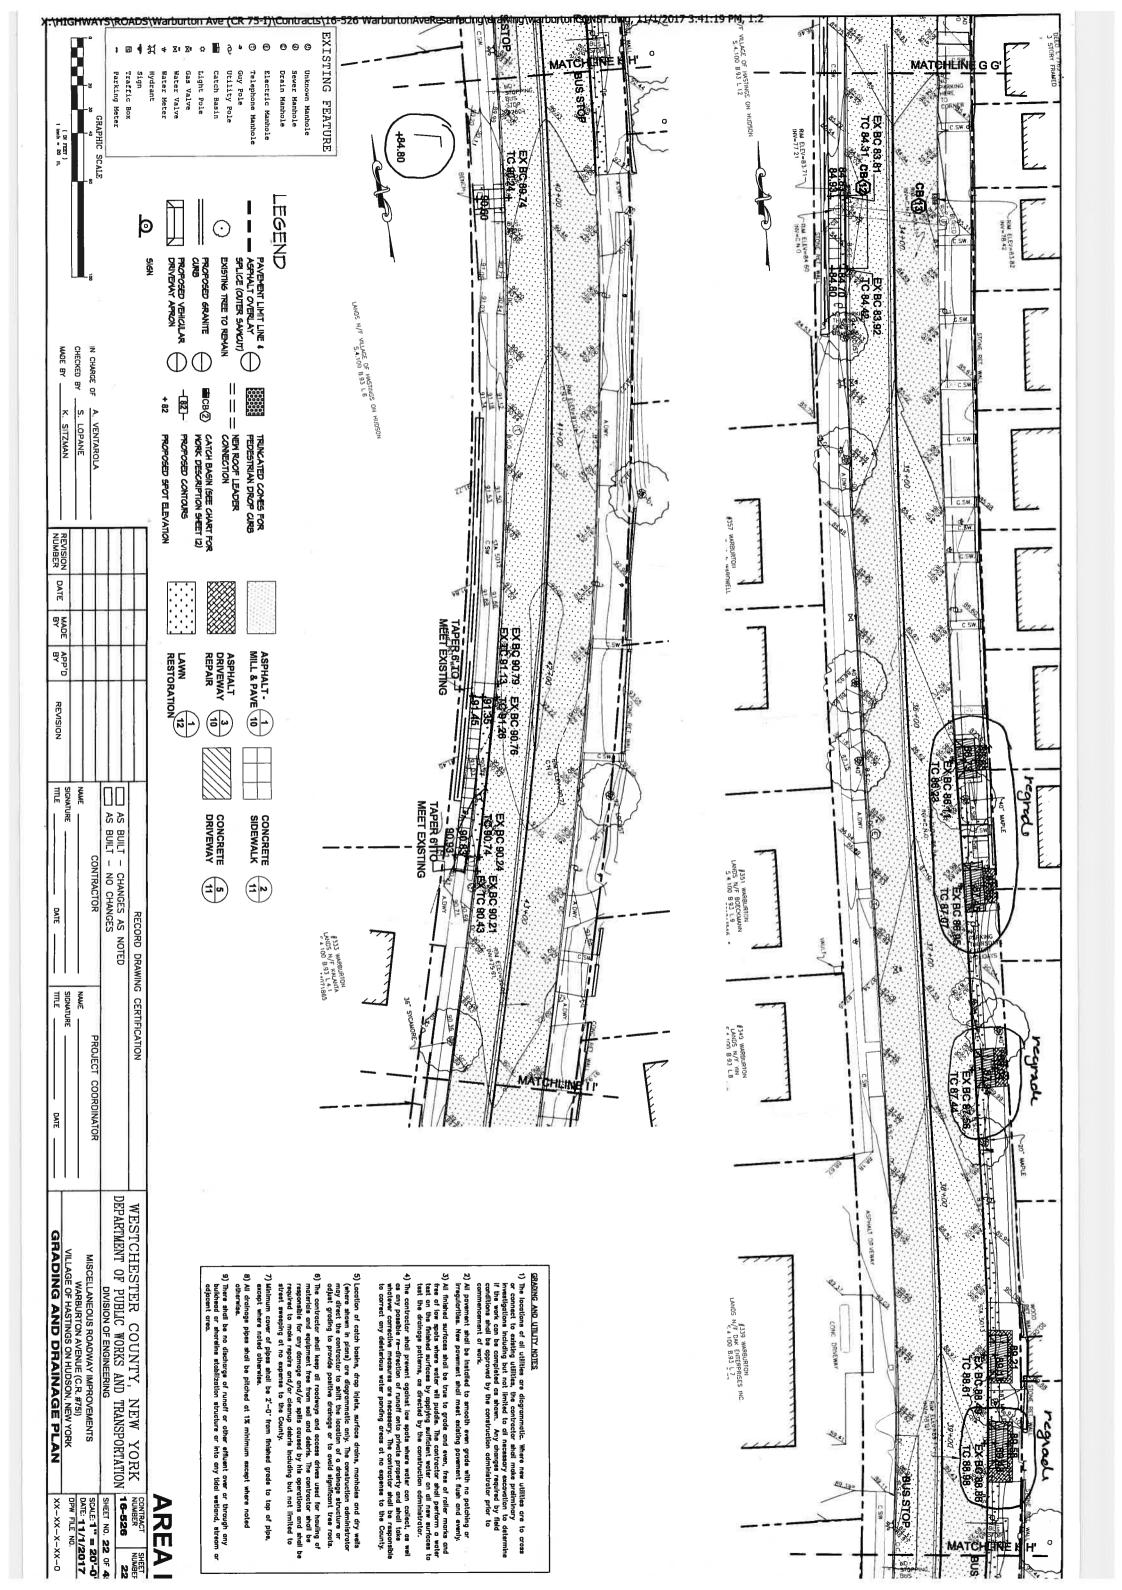


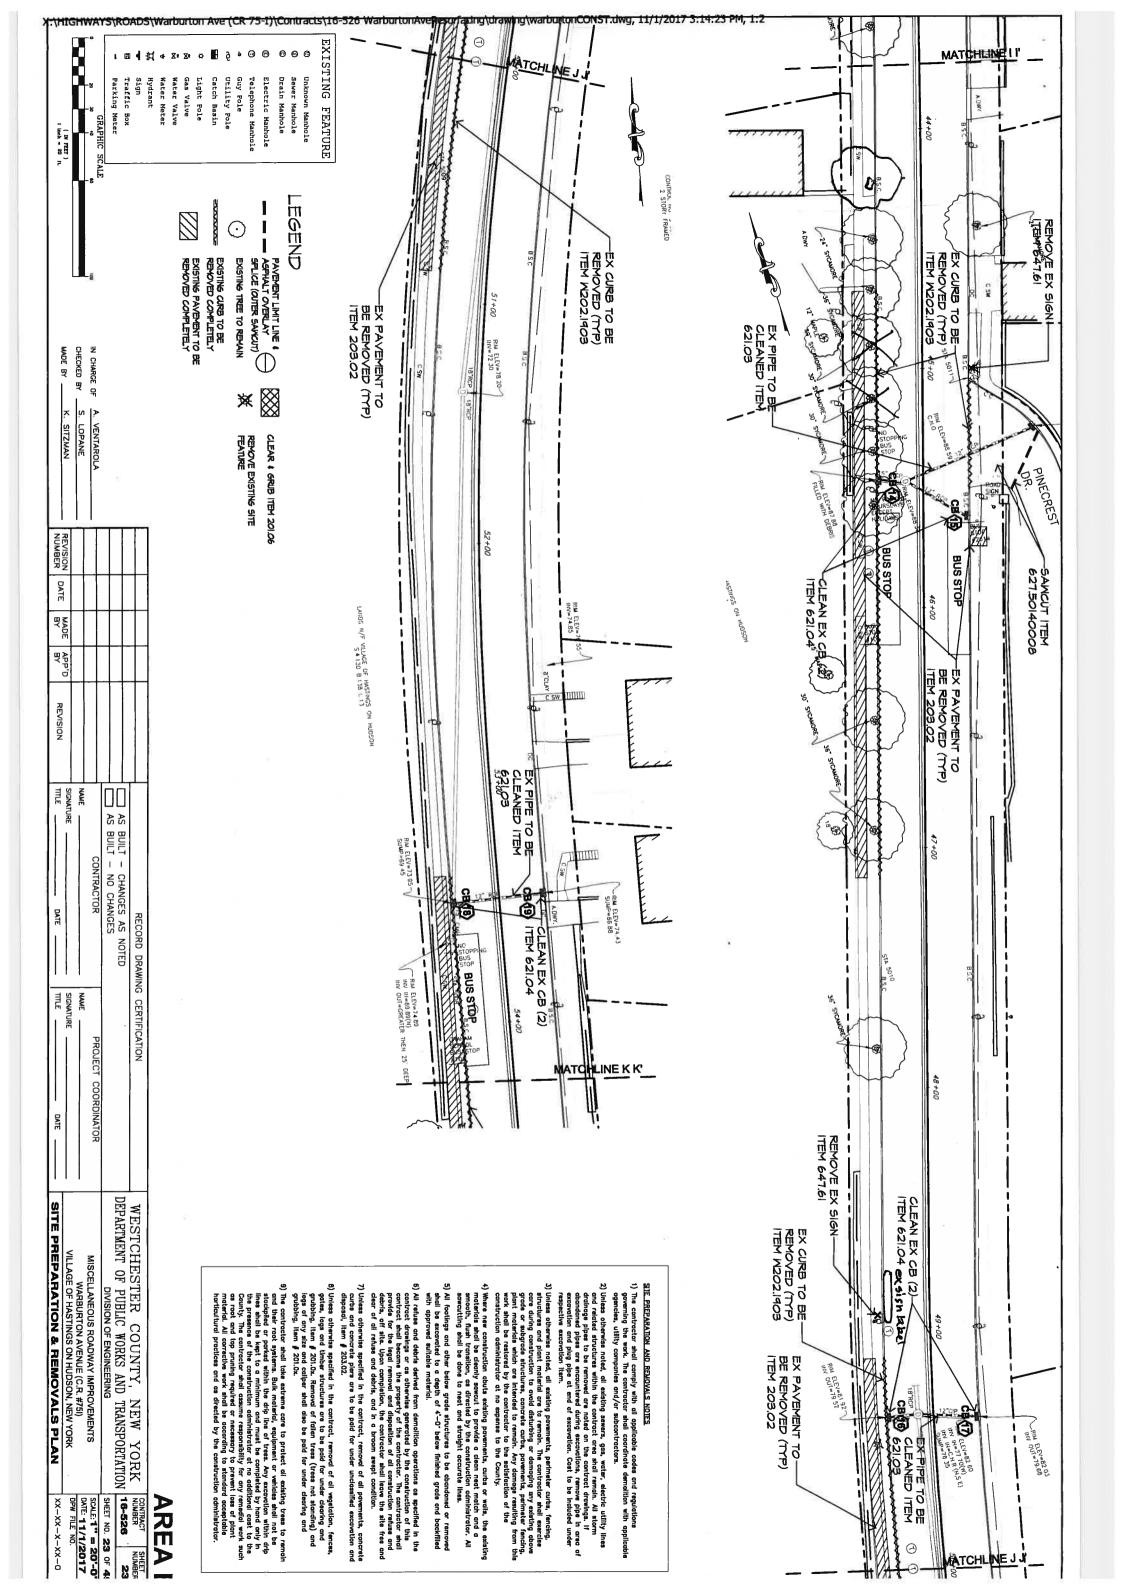


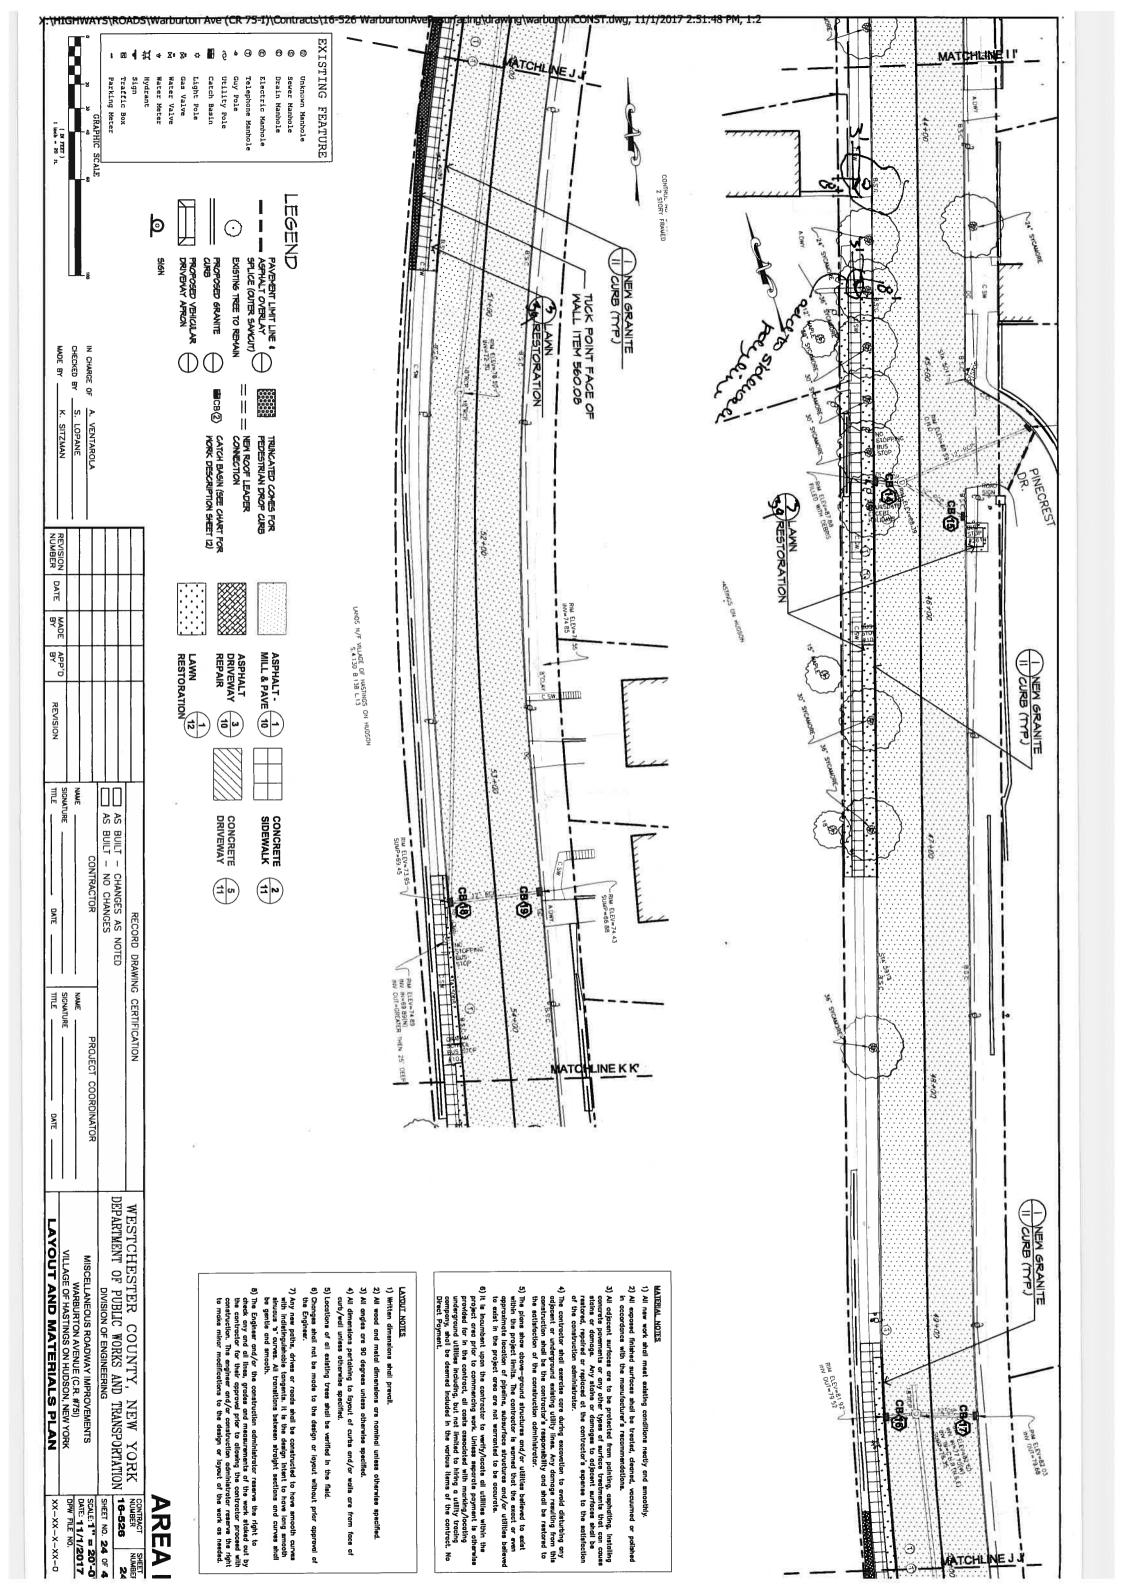


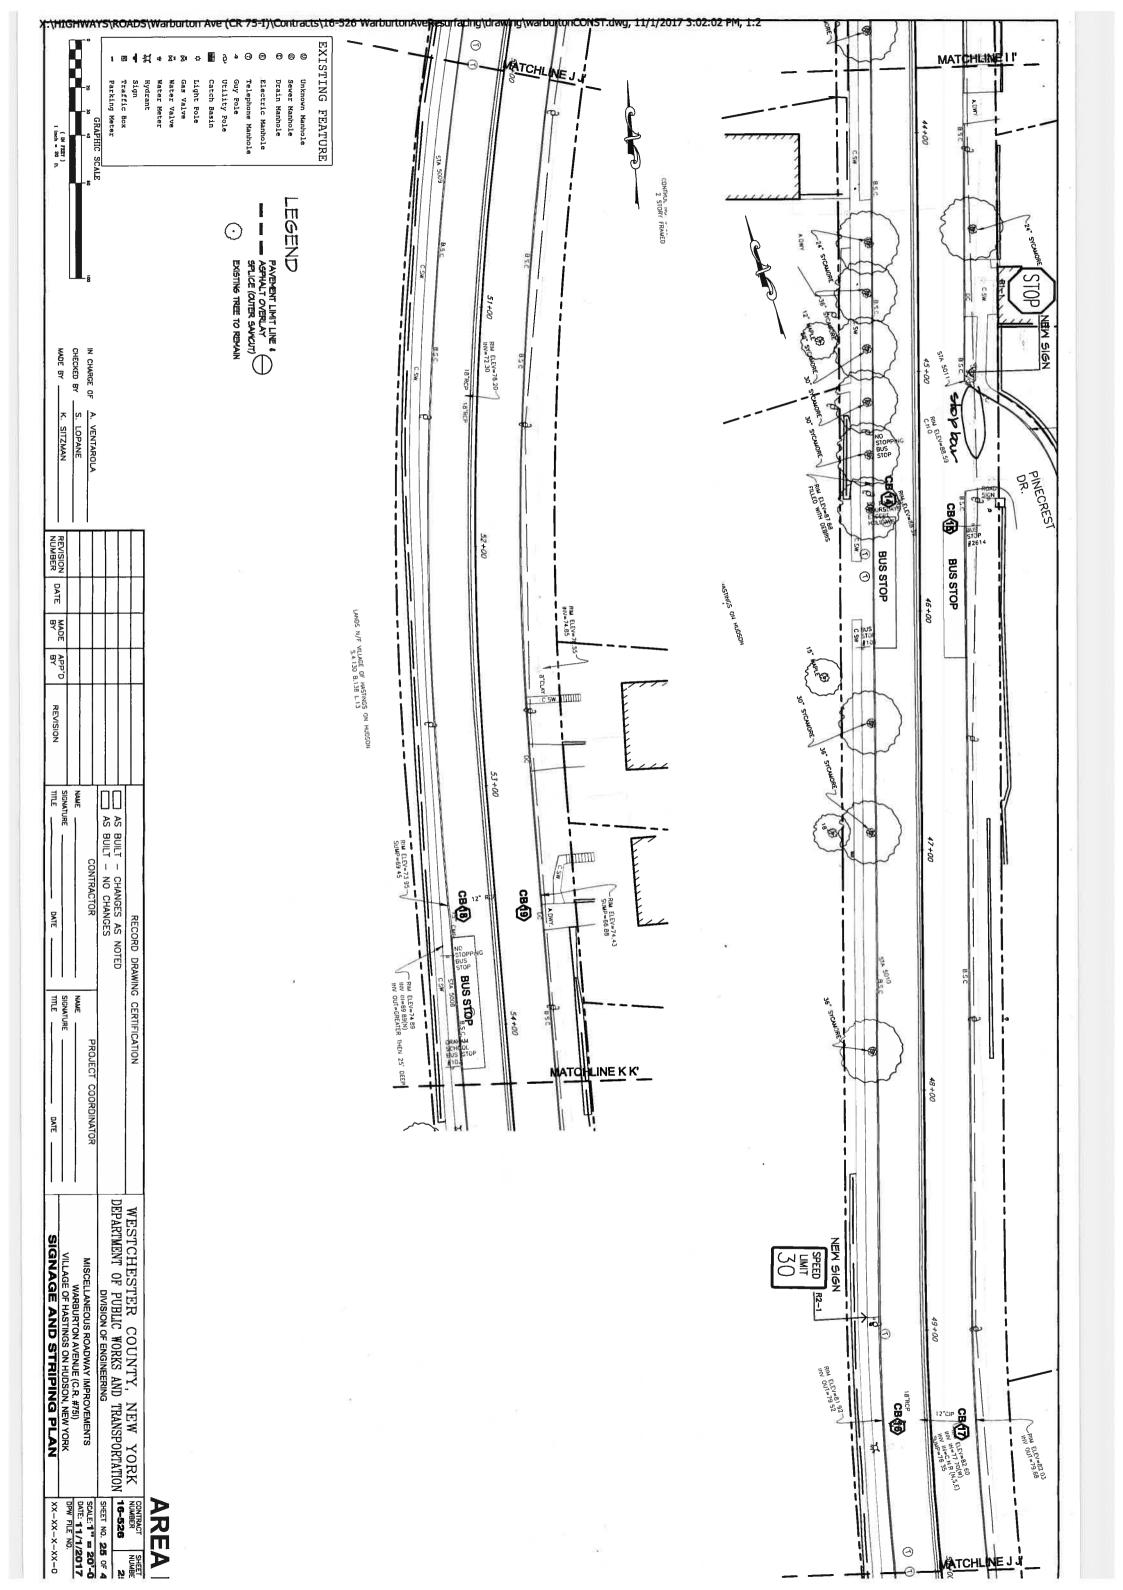


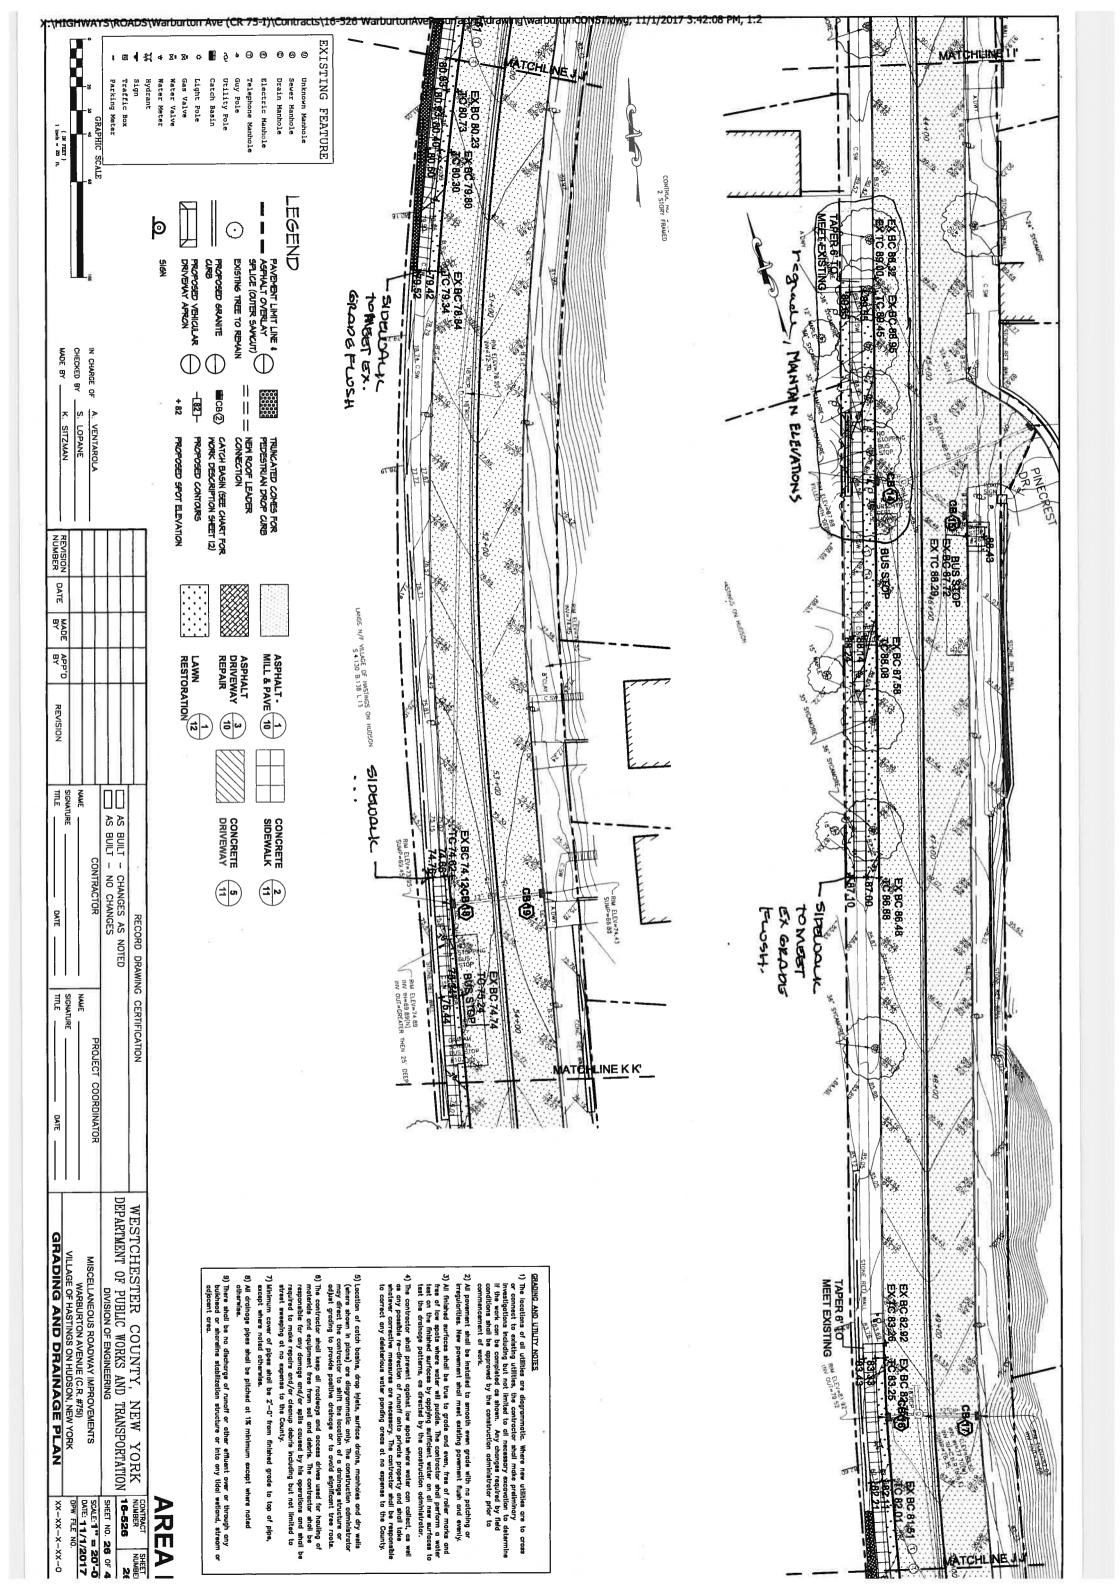


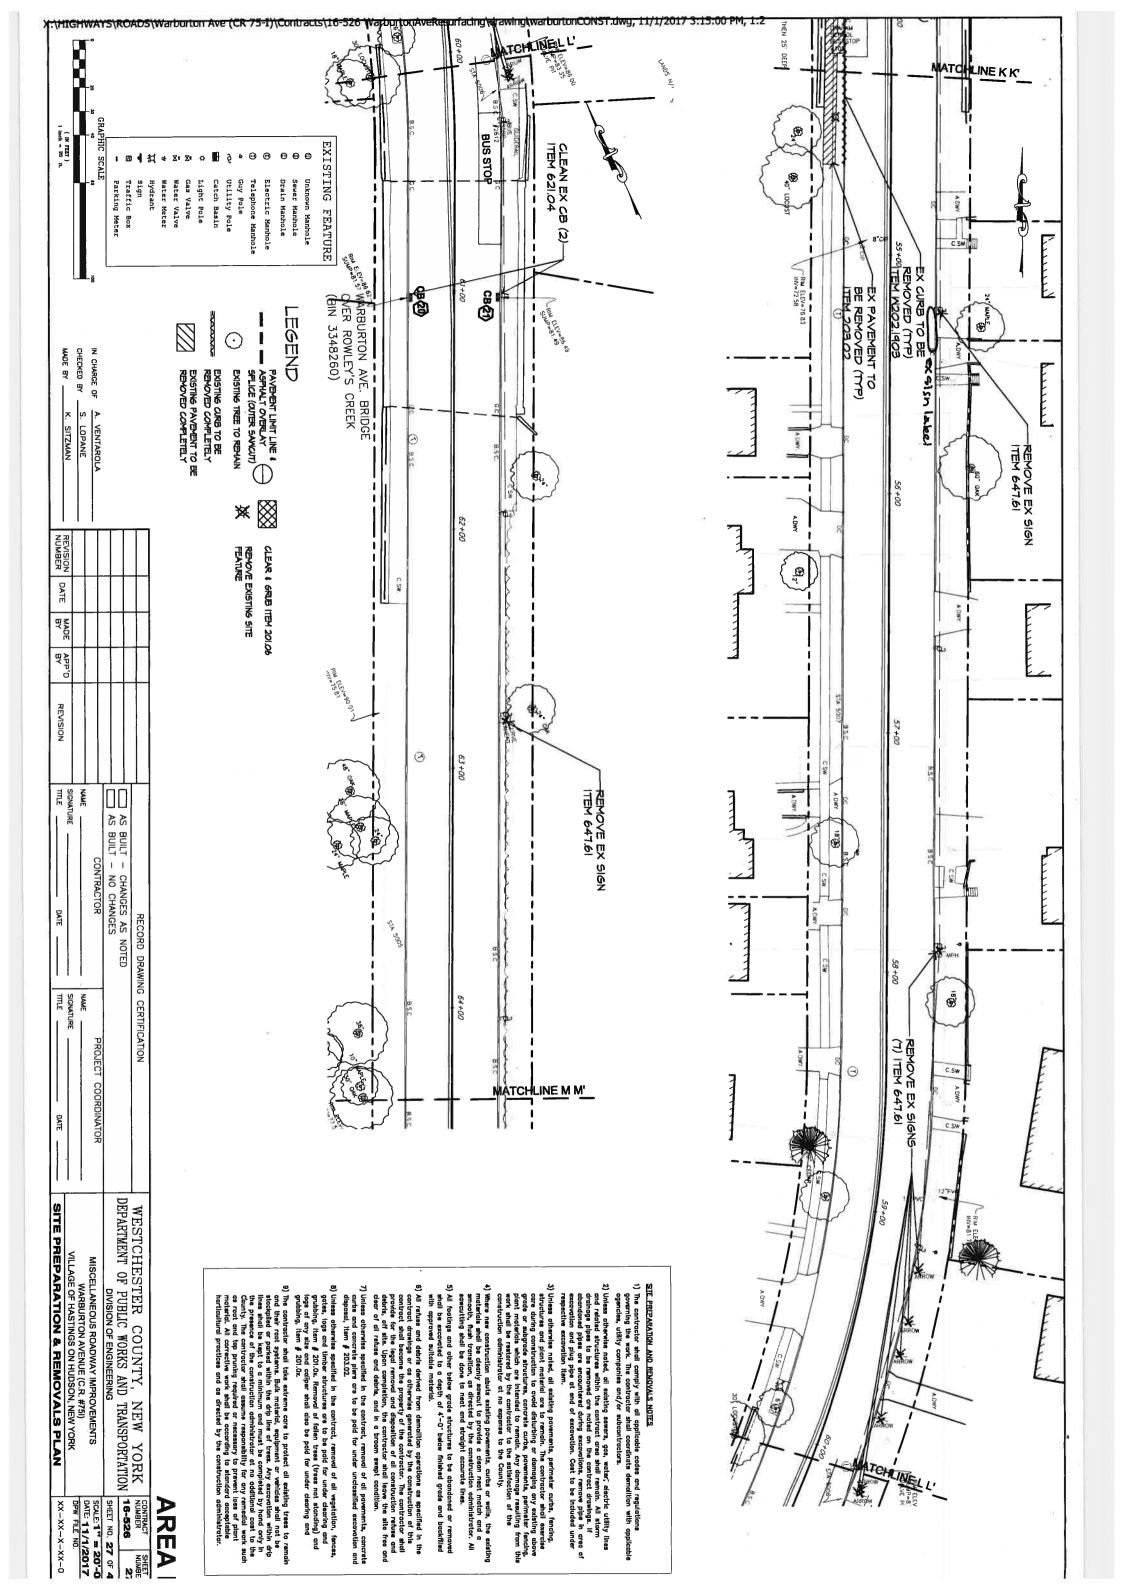


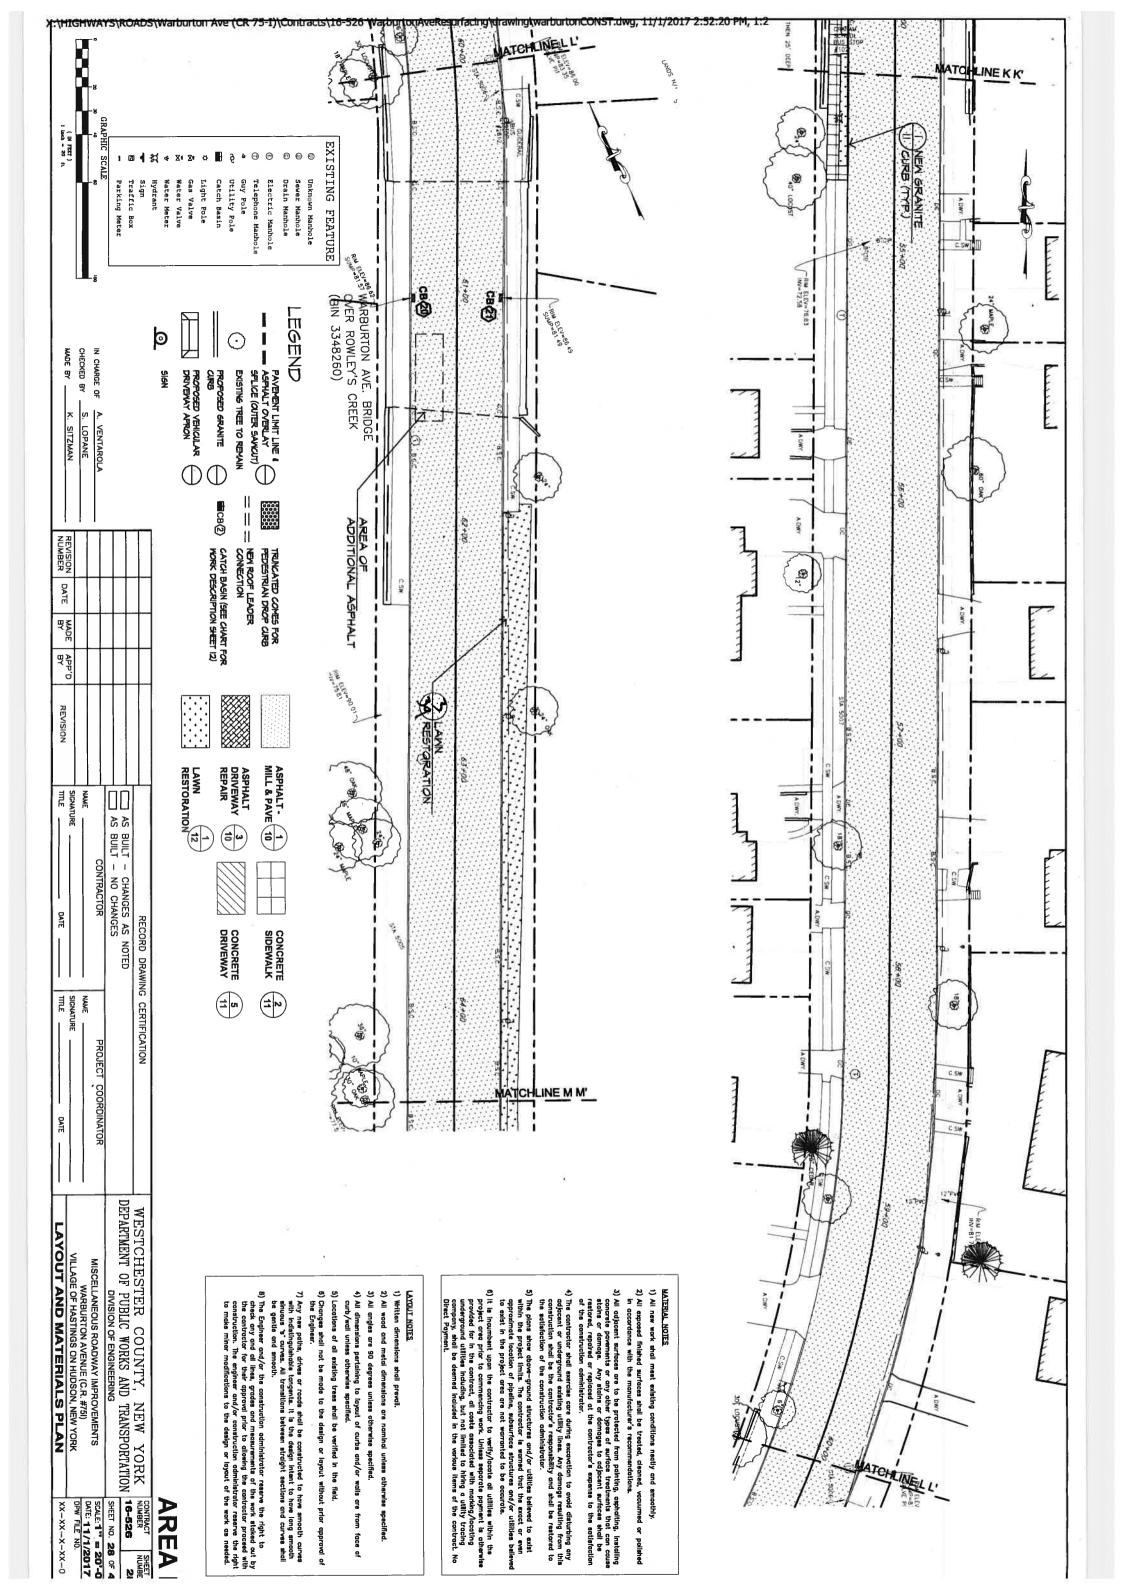


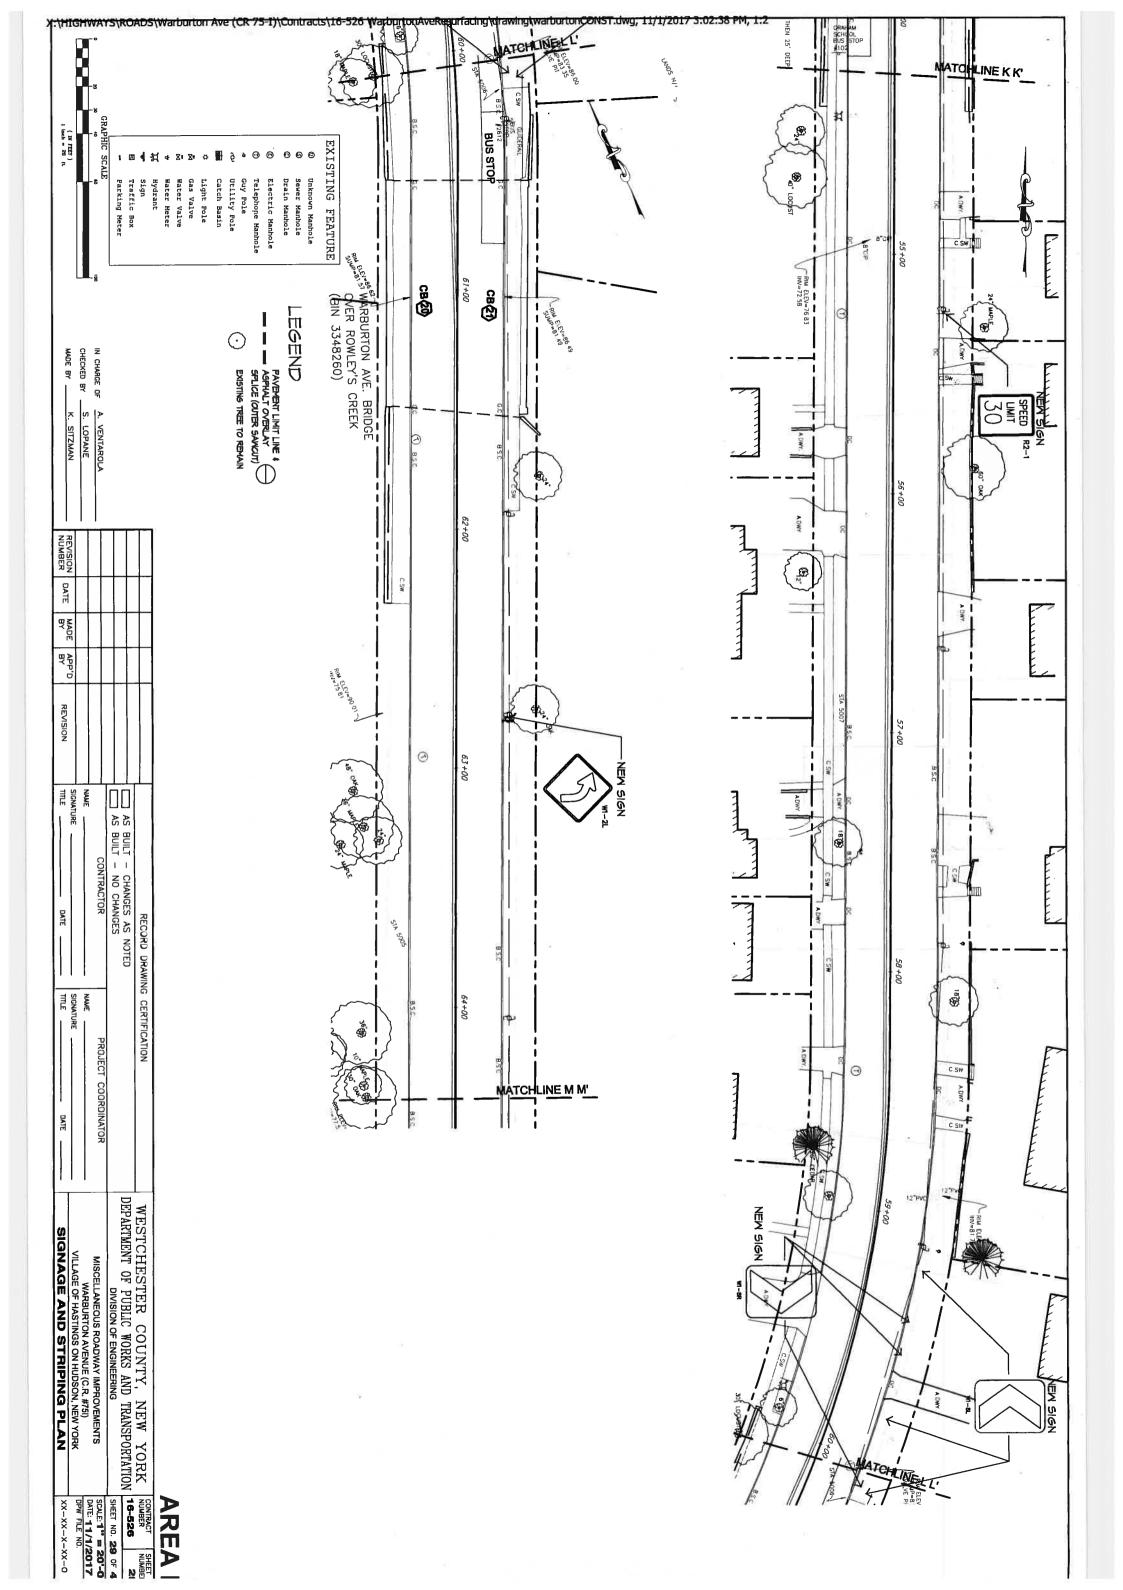


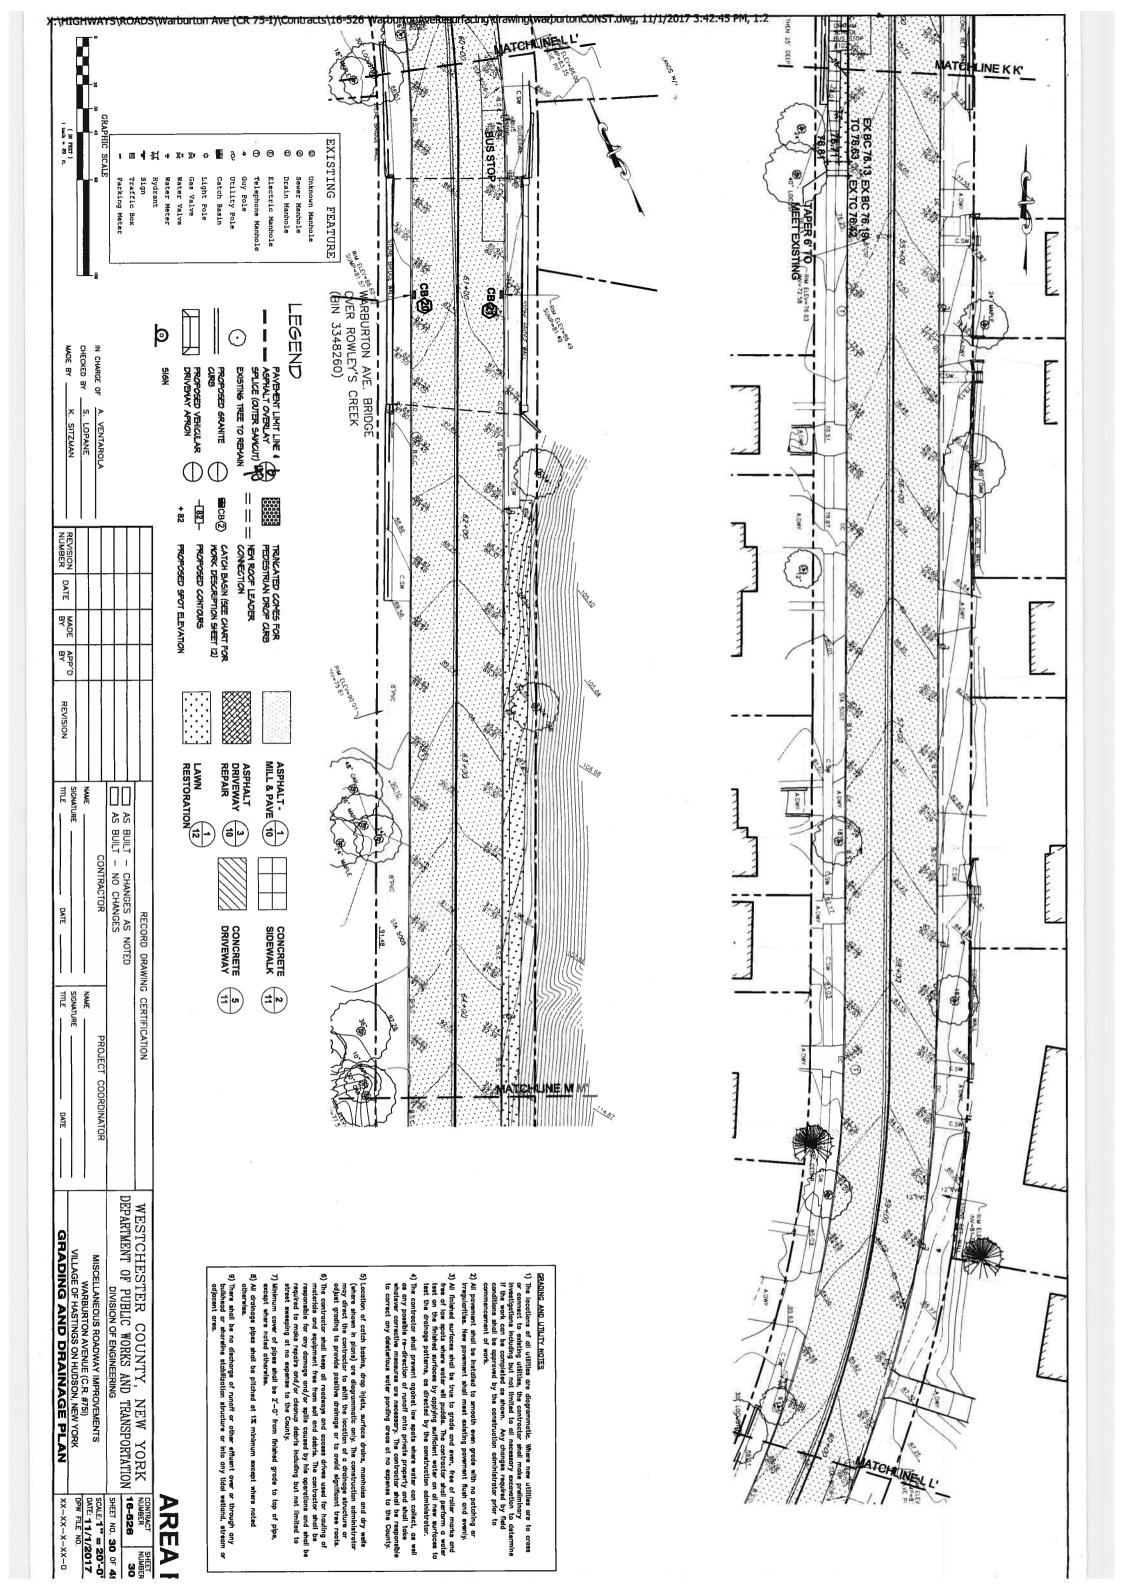


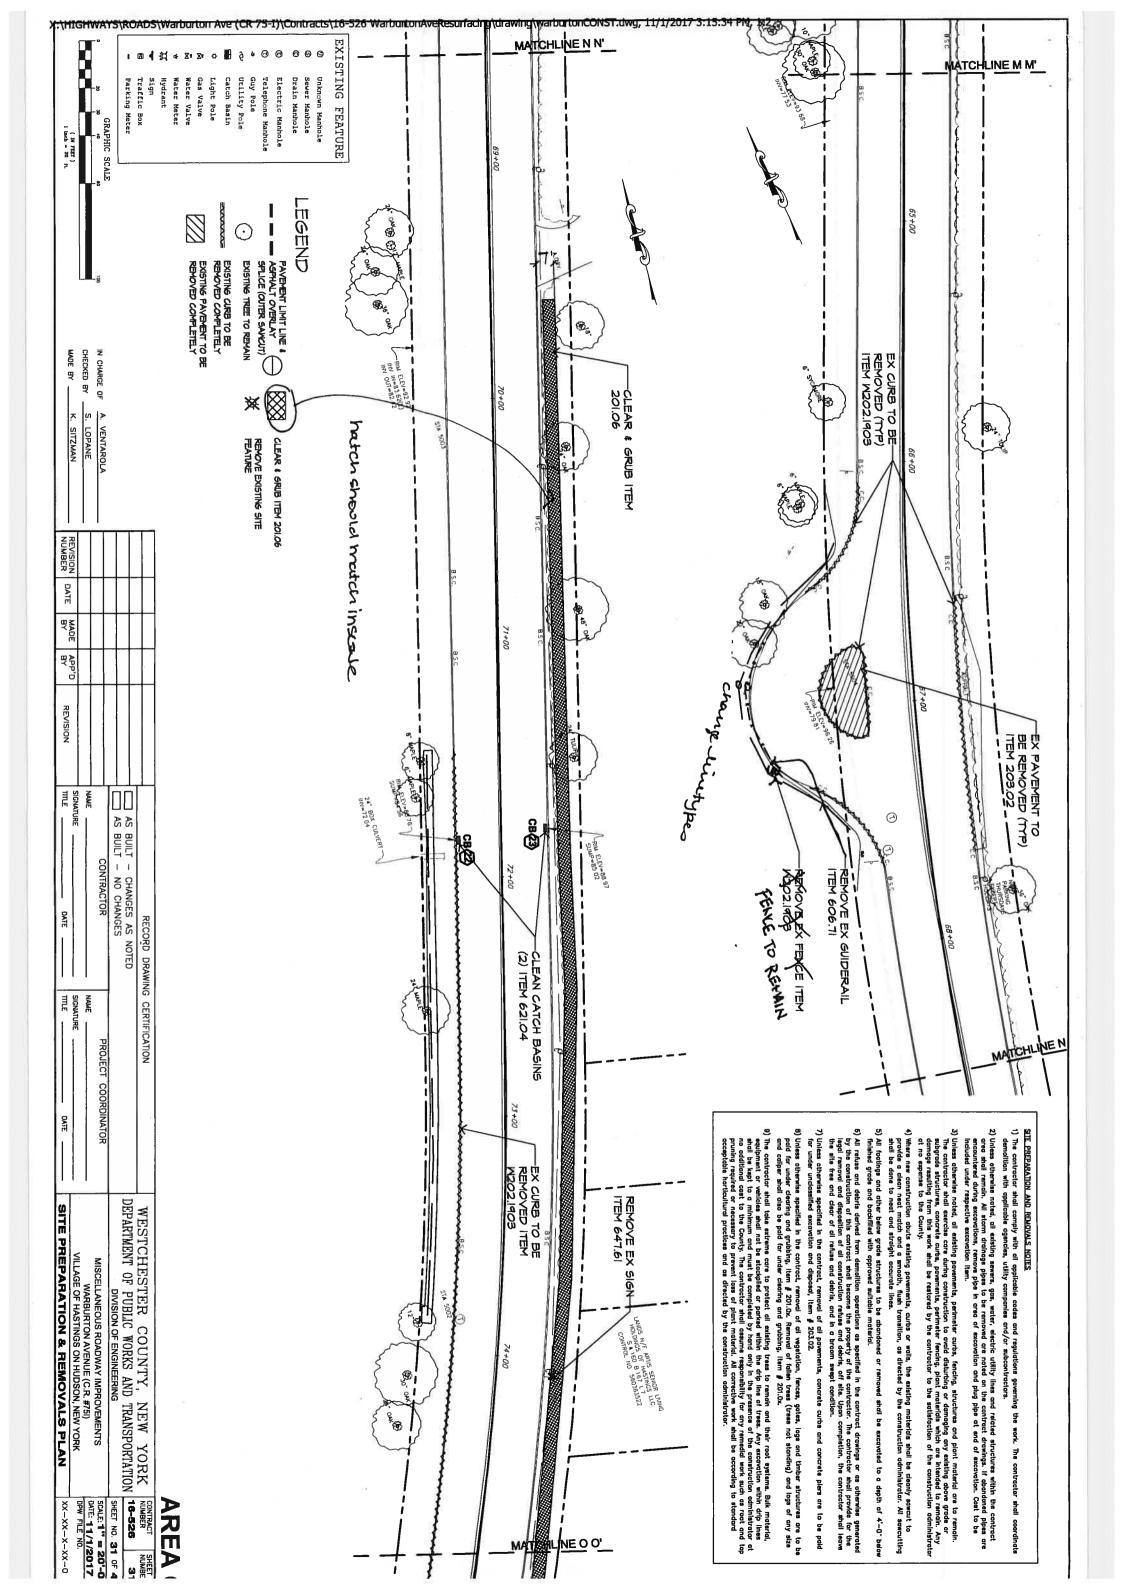


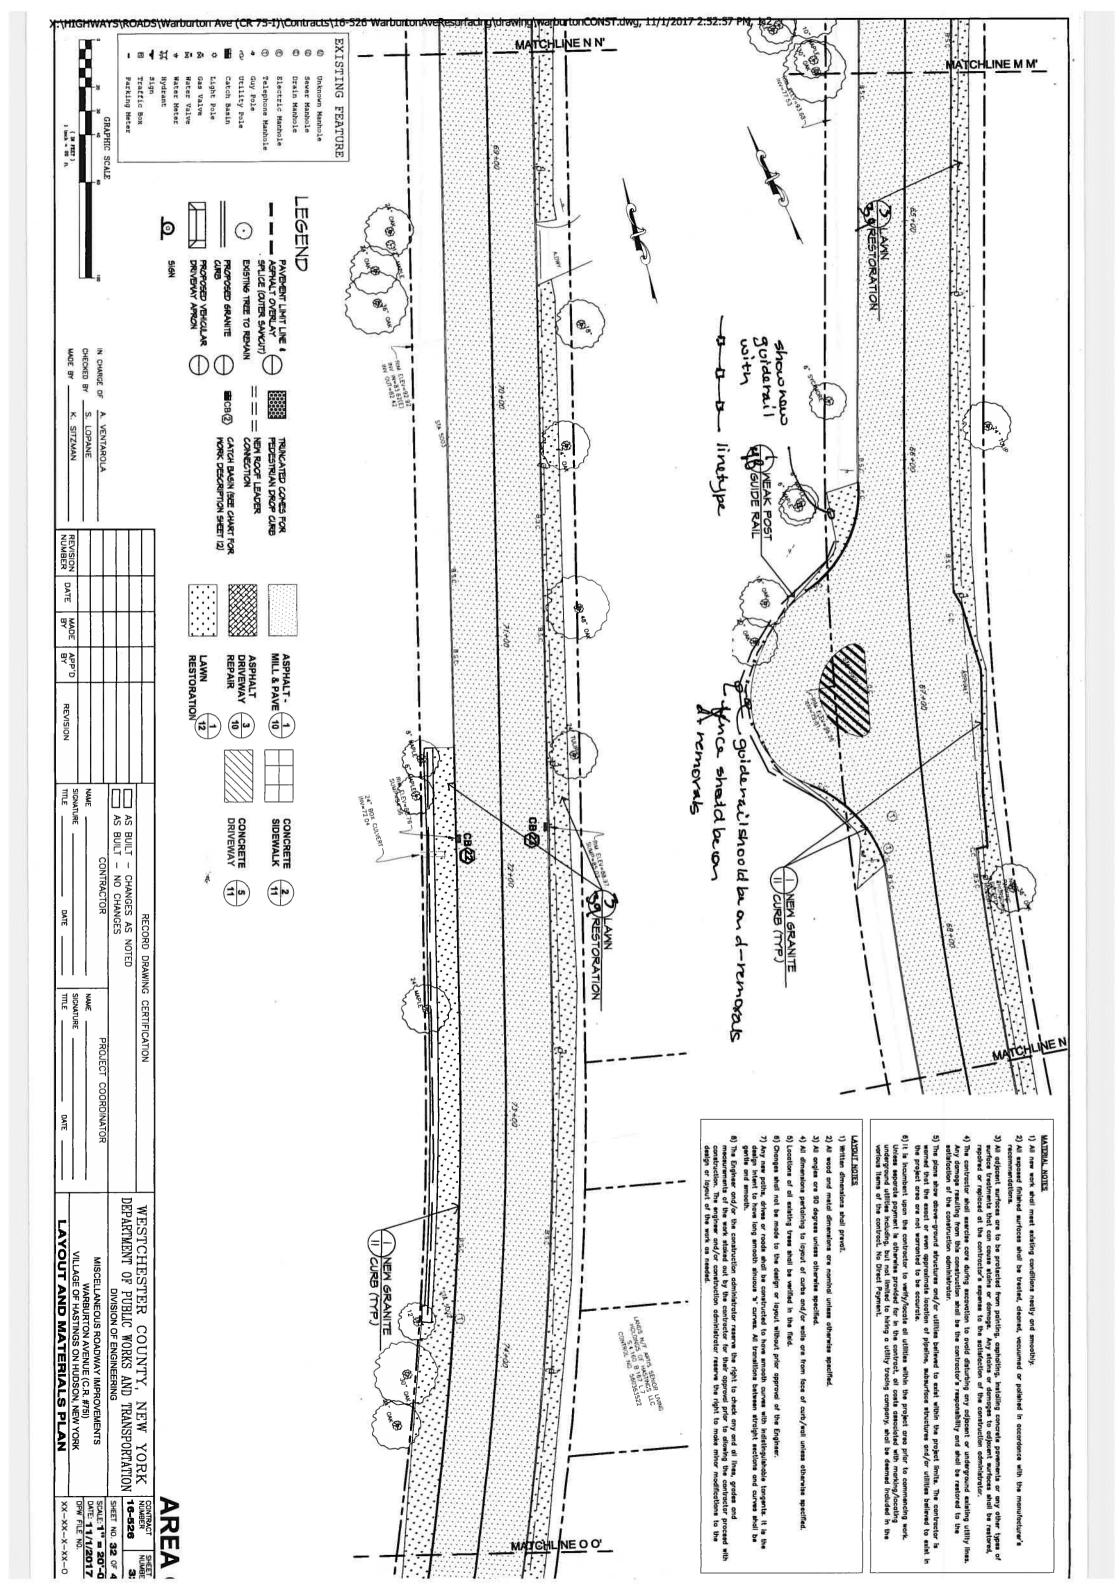


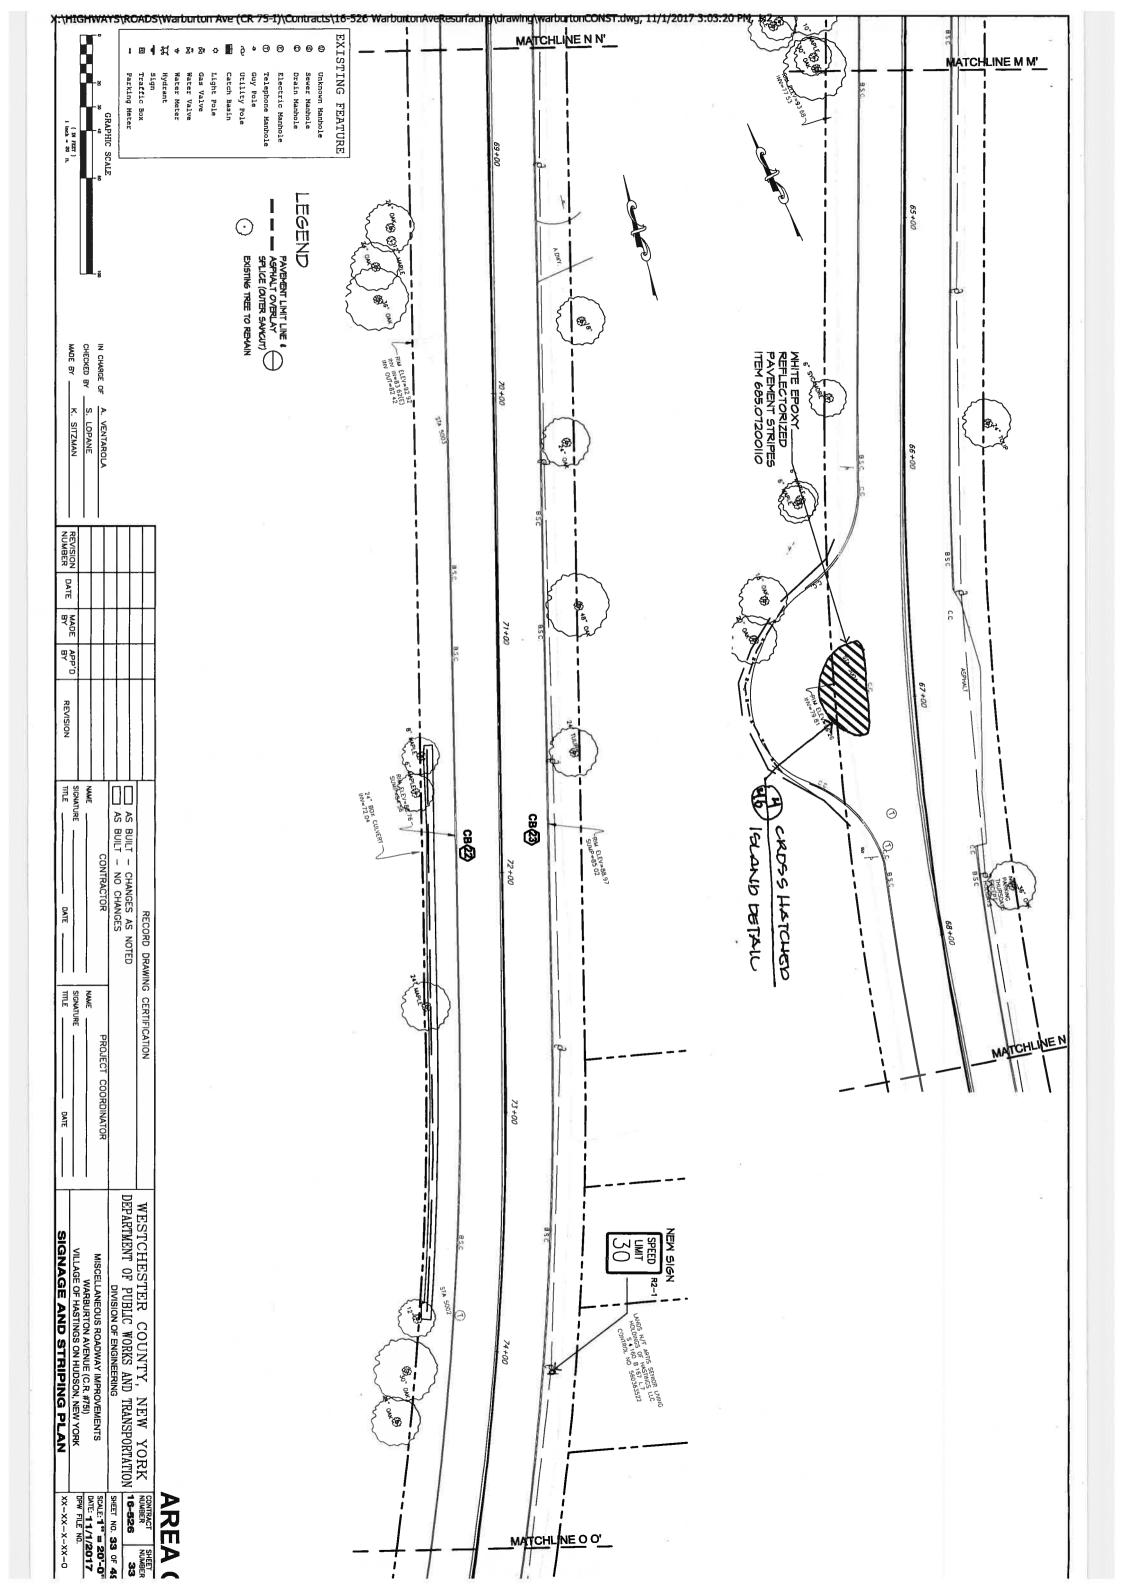


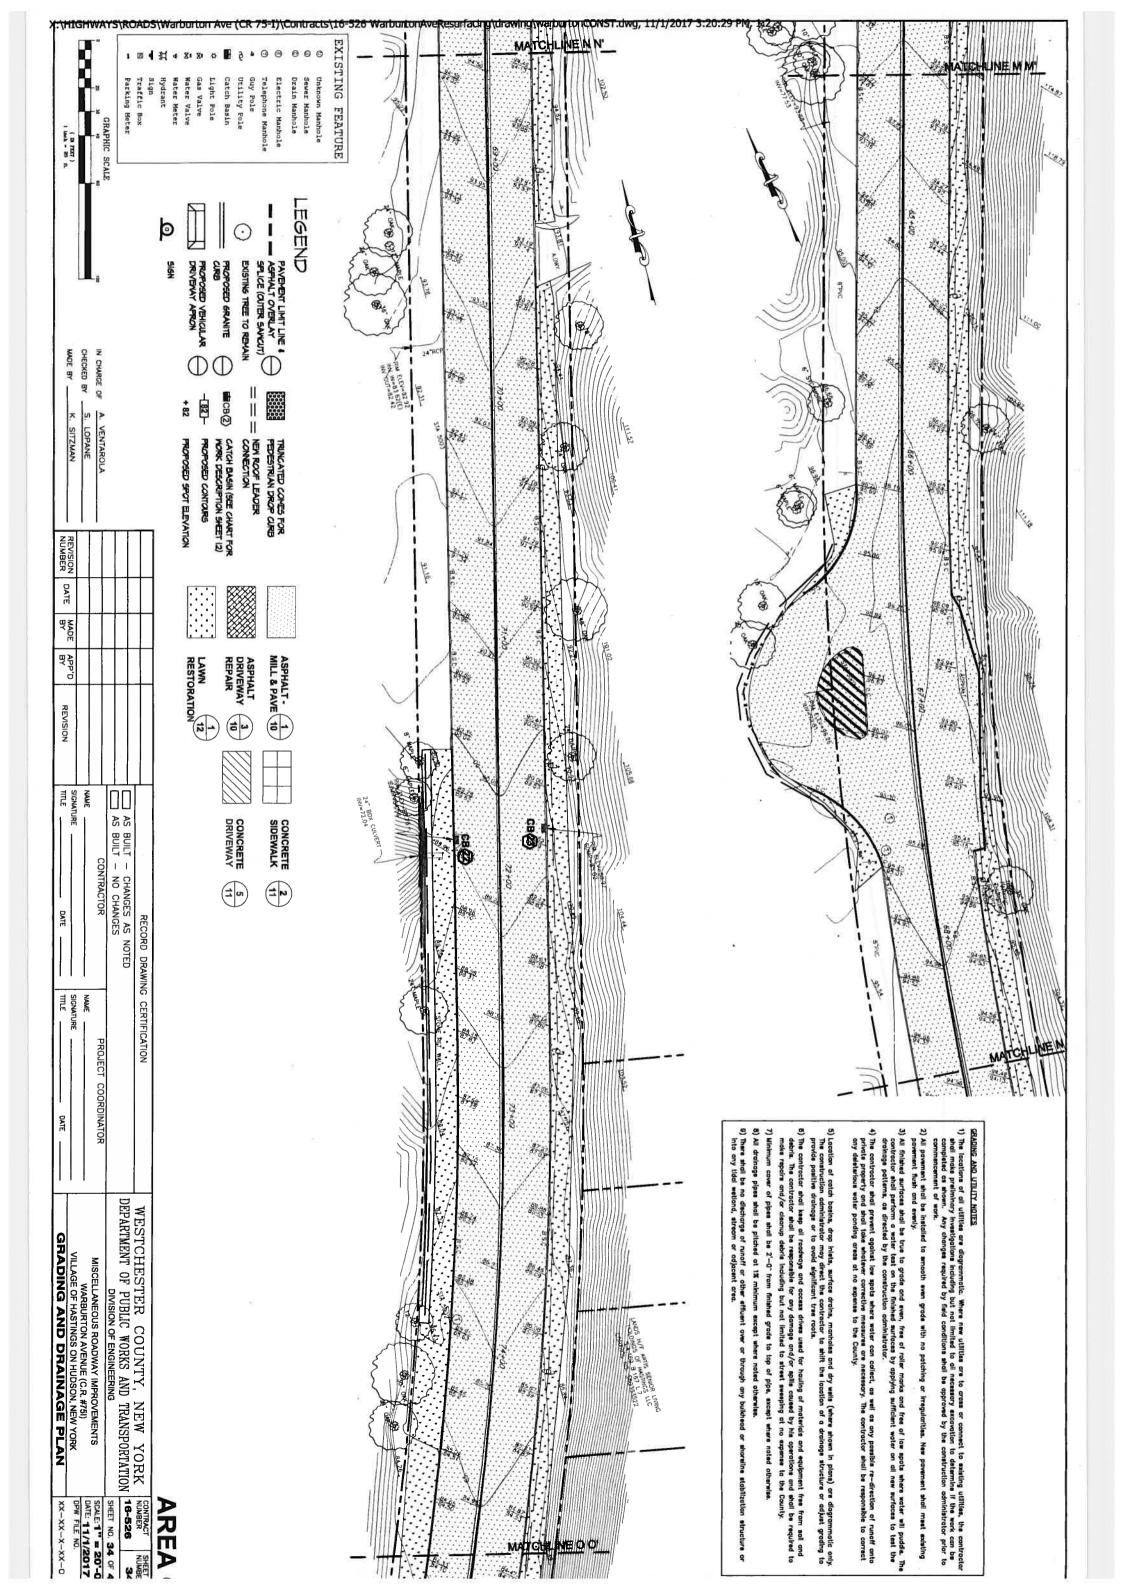


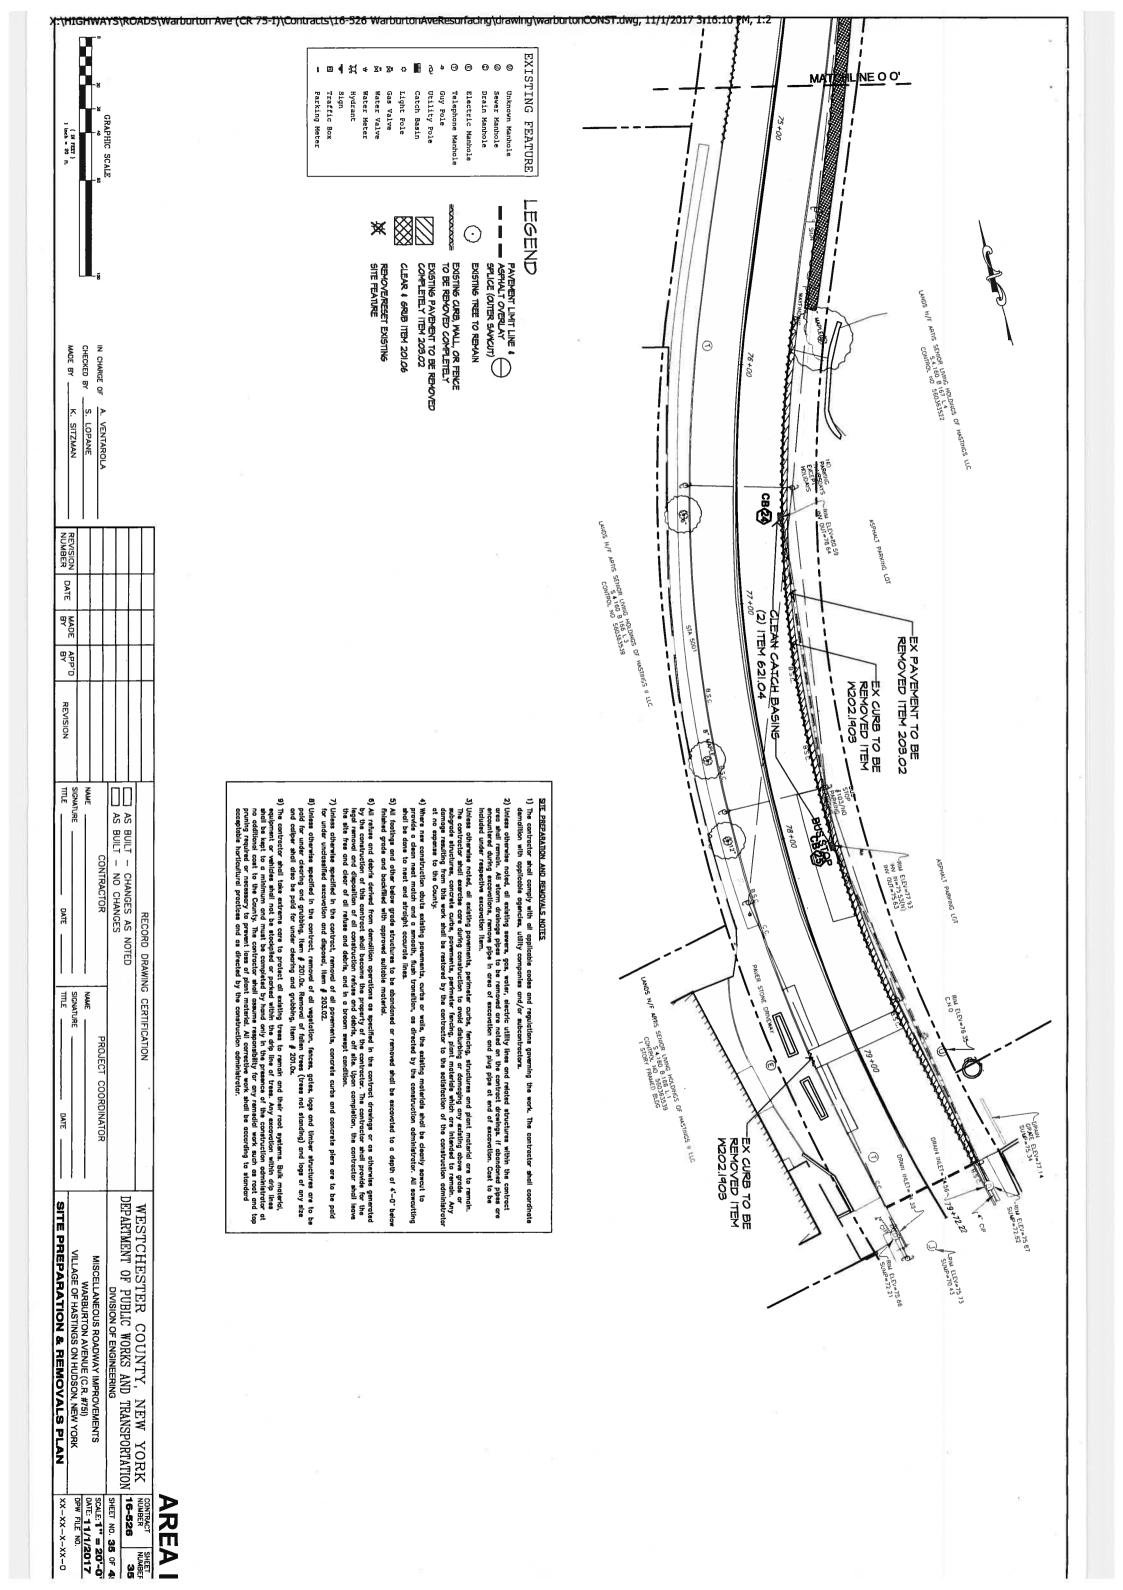


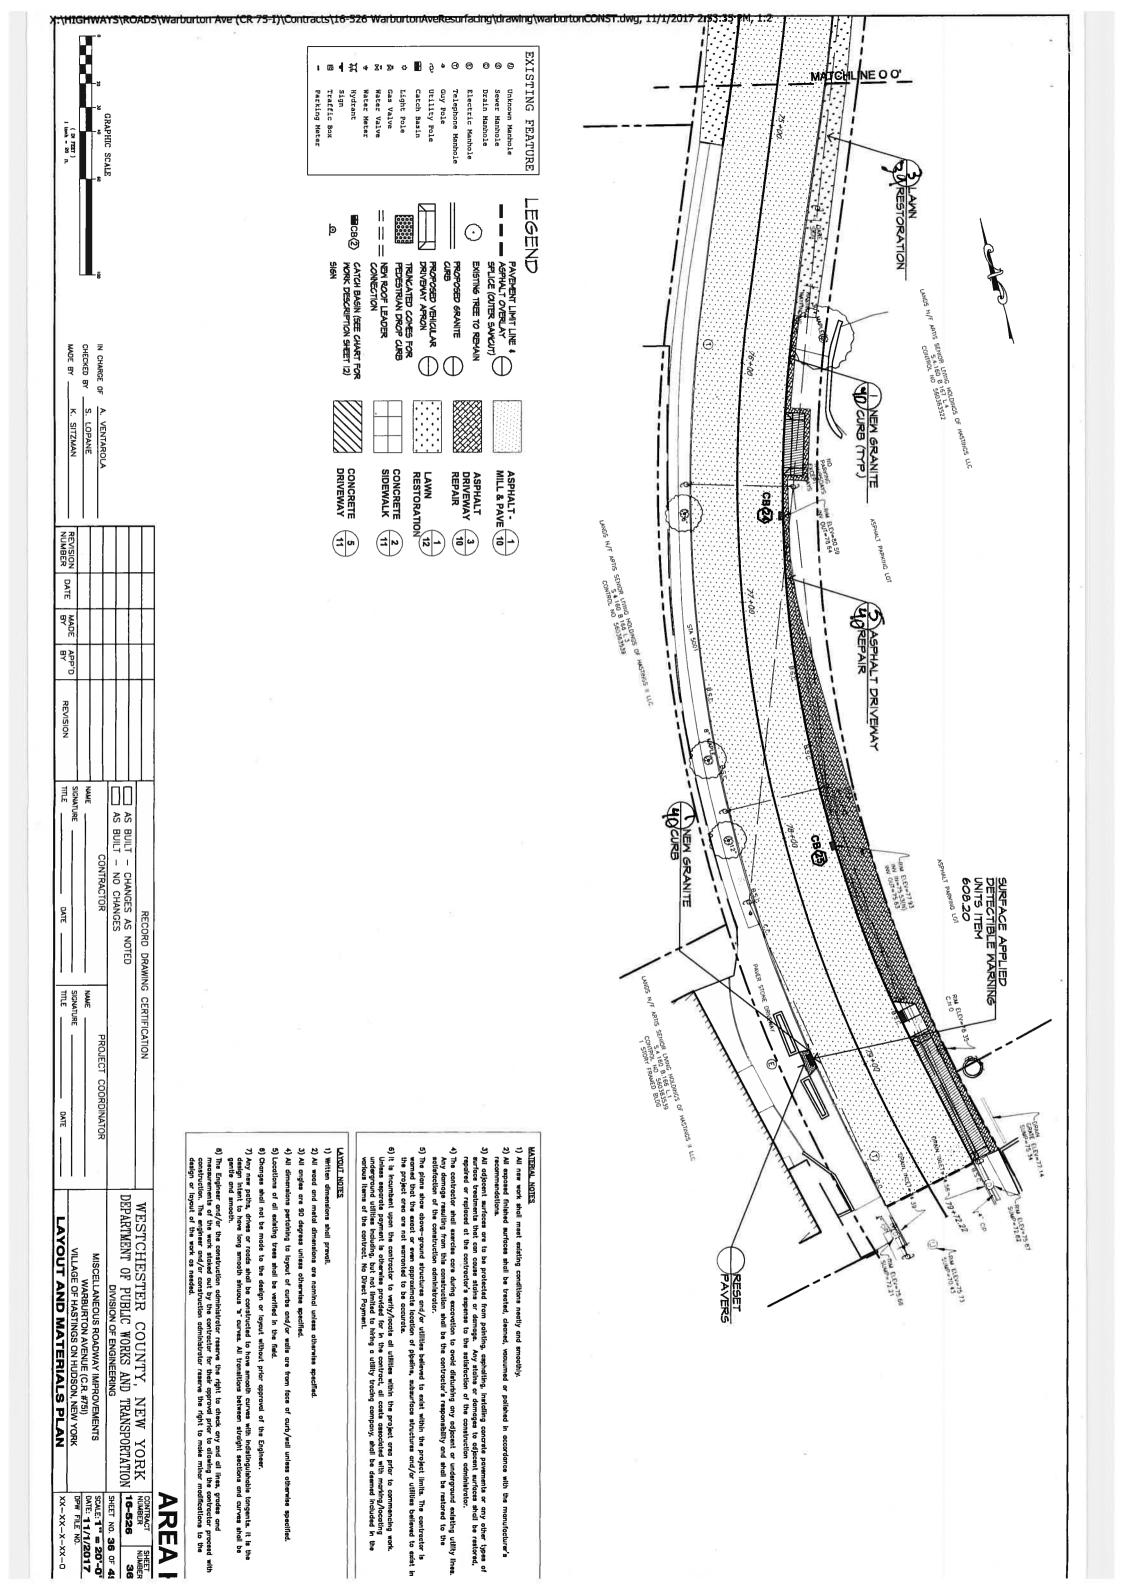


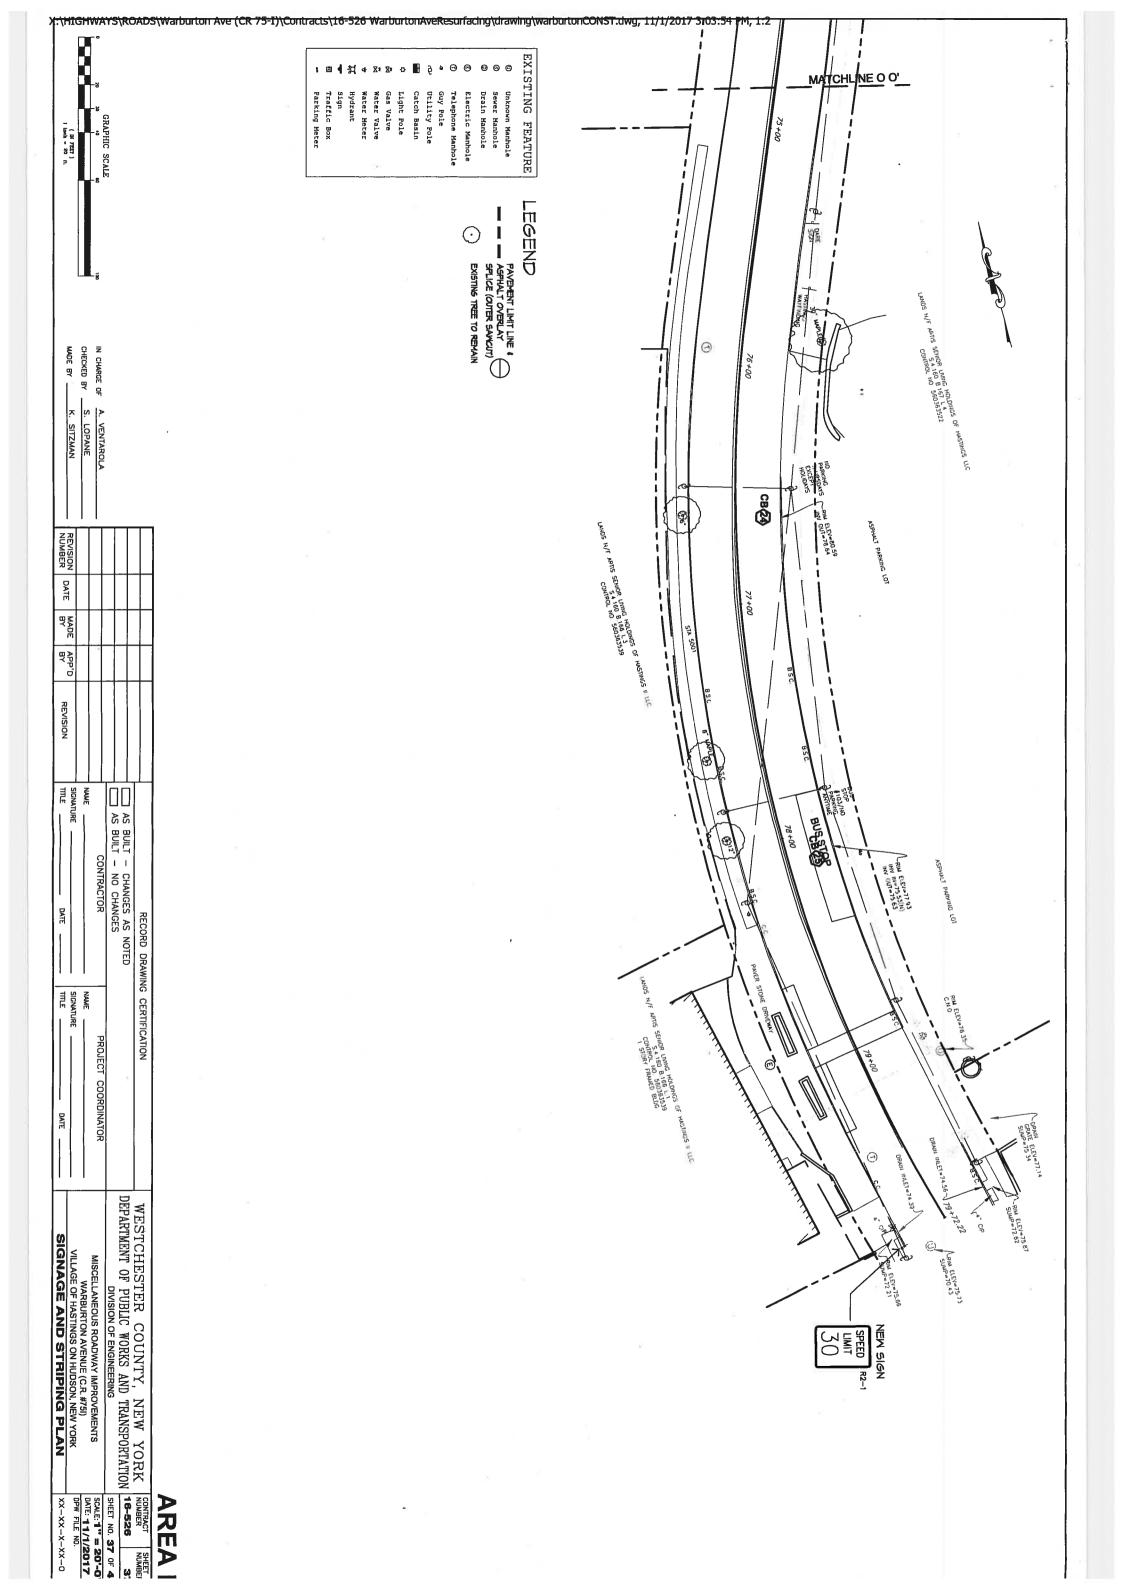

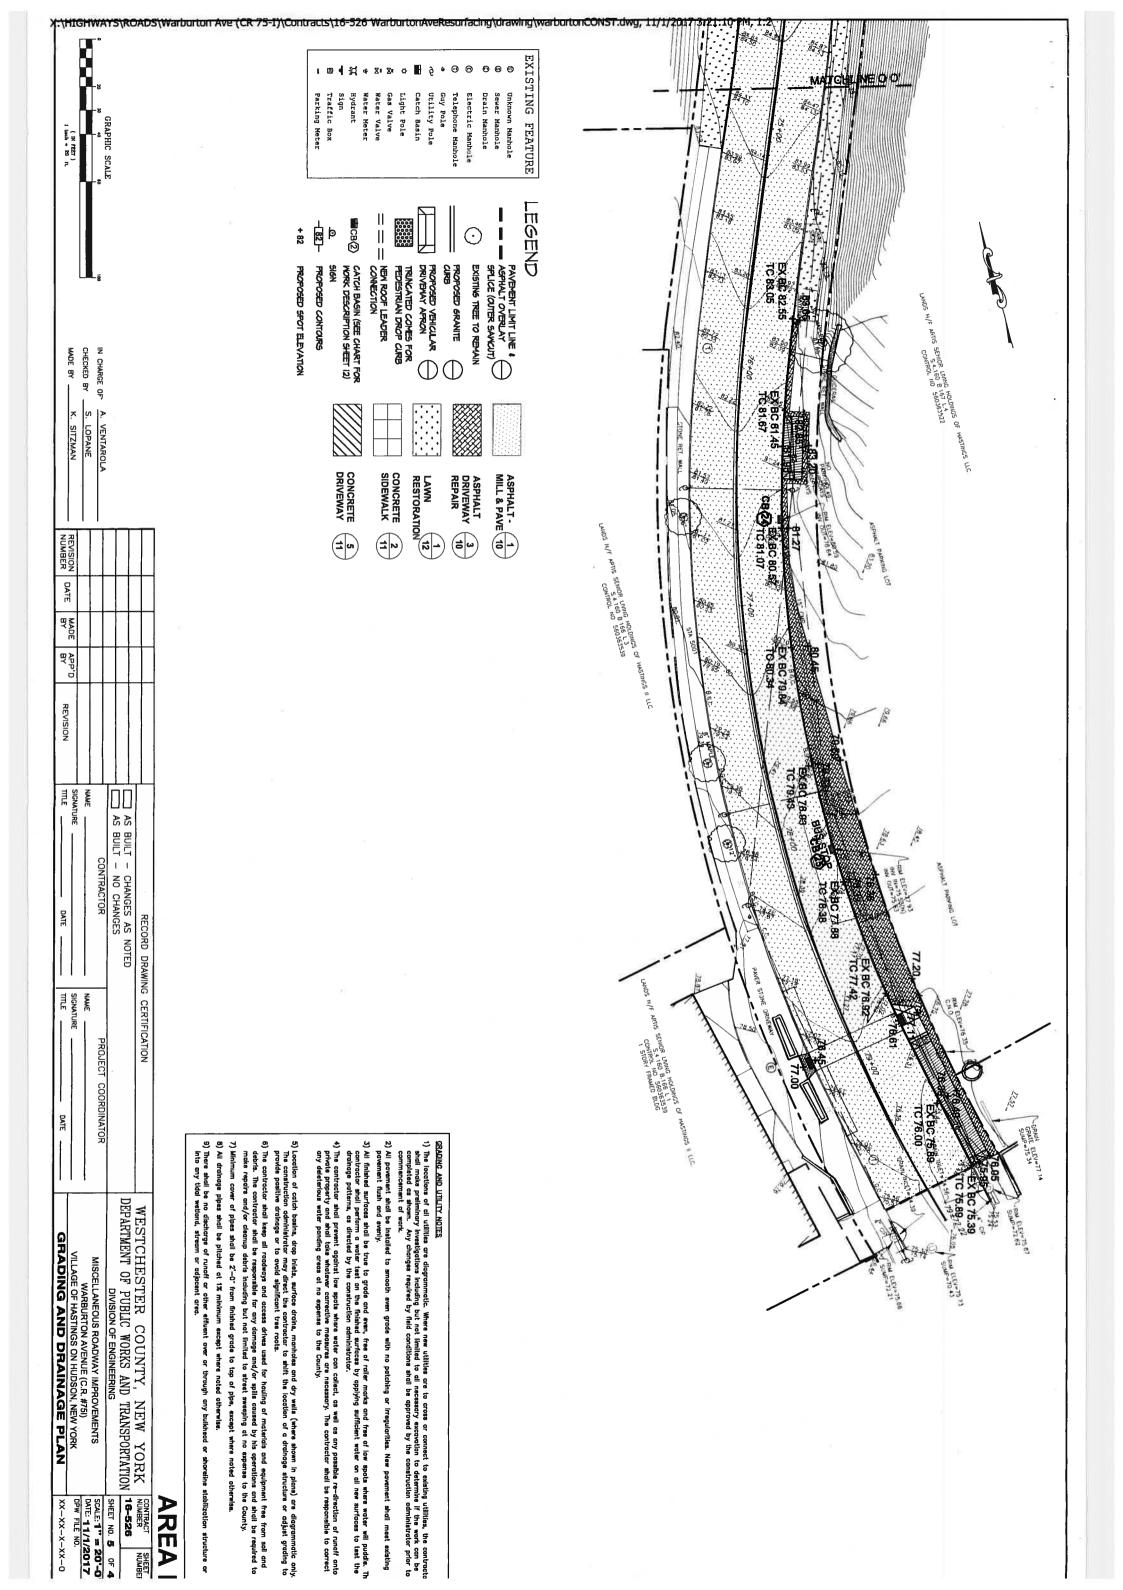

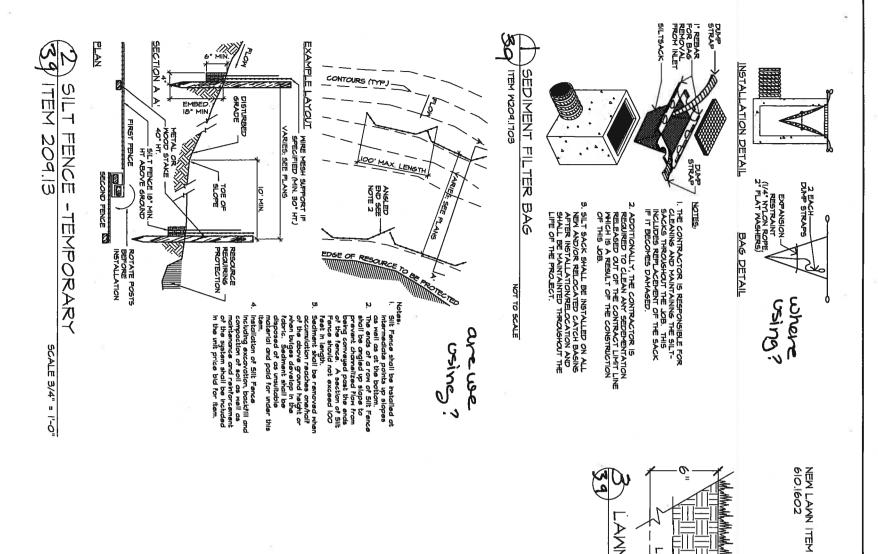

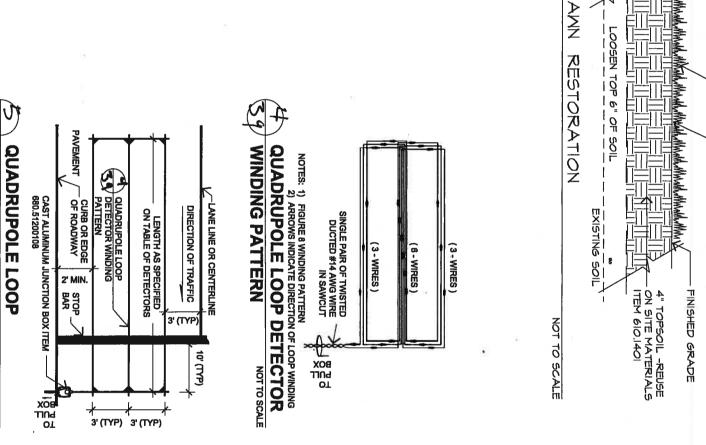

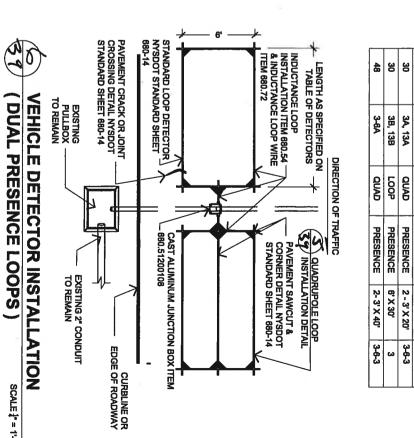

Ŷ-O	XX-XX-X-X	SITE PREPARATION & RESTORATION DETAILS XX-XX-X-XX-0	TITLE DATE	TITLE DATE	REVISION	Вү
	DAM LICE NO.	VILLAGE OF HASTINGS ON HUDSON, NEW YORK	SIGNATURE	SIGNATURE		0,44
2	DON 211 1/1/2017	WARBURTON AVENUE (C.R. #751)	XAME	NAME:		
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INSTALLATION DETAILS

SCALE | = 1'-0"

IN CHARGE OF

MADE BY CHECKED BY

SITZMAN

REVISION NUMBER

DATE

MADE BY

EROSION CONTROL NOTES

MULCH WITH STRAM AT 40
LBS/1000 SF (2 BALES);
HYDROMULCH WITH TACKIFIER
ALLOMED IN LIEU OF HAND
MULCHING; COST INCLUDED IN

All proposed soil erosion and sediment control practices have been designed in accordance with the most recent editions of the New York State Stamwarter Management Design Manual and the New York State Standards and Specifications for Erosion and Sediment Control. The contractor shall comply with all applicable stormwater management, water quality control, erosion, and sediment control laws, rules, regulations and permits.

Sediment and erasion control practices shall be installed prior to any major soil disturbances and maintained until permanent protection is established.

3) The contractor shall be responsible for the timely maintenance of sediment and evasion control practices. All practices shall be maintained in good working order. The sediment level in all sediment traps shall be closely manifored and sediment removed when maximum levels are reached or as ardered by the construction administrator, All sediment control practices shall be inspected on a regular basis, and after rainfall events greater than half an inch to ensure proper aperation as designed.

4) All soils not being used for find grading shall be immediately, protected, stabilized and stackpilled in a location away from starm drains and waterbodies as approved by the construction administrator. All soil stackpilles shall be limed, fertilized, temporarily seeded with annual or perennial ryegrass or oats within 14 days once it is known the soil stackpille will not be used for a period of time greater than 14 days. The cost of such protection and stabilization shall be deemed included in the various items of the contract. No Direct Payment.

5) Any disturbed areas that will be left exposed for more than 21 days and are not subject to construction traffic shall be stabilized with temporary seeding. Erosion control fabric or mulch shall be used on all disturbed areas if the season prevents the establishment of a temporary cover for temporary stabilization. Erosion control fabric shall be used to temporarily stabilize steep slopes (slope gradient of 2:1 or greater). Disturbed areas shall be limed and fertilize prior to temporary seeding.


5) All disturbed areas within 500 feet of an inhabited dwelling shall be wetted as necessary to ensure dust control.


7) Temporary sediment and erosion implemented, where specified, w construction has been properly Design Manual and the New Yor n control practices shall be removed and permonent sediment and erosion control practices then the drainage area, including all roads, driveways, and porking areas used during the course of stabilized by permanent practices in accordance with the New York State Stormwater Management k State Standards and Specifications for Erosion and Sediment Control.


B) The contractor shall phase the time: construction in a manner that there will be no more than five acres of soil disturbance at any one

SIGNAL NO. DETECTOR NO. TYPE TABLE OF DETECTORS MODE 2-3'X20' 6'X30' SIZE 3-6-3 NO OF TURNS

X:\HIGHWAYS\ROADS\Warburton Ave (CR 75-I)\Contracts\16-526 WarburtonAveResurfacing\drawing\DETAILS.dwg, 11/1/2017 3:27:42 PM, 1:2

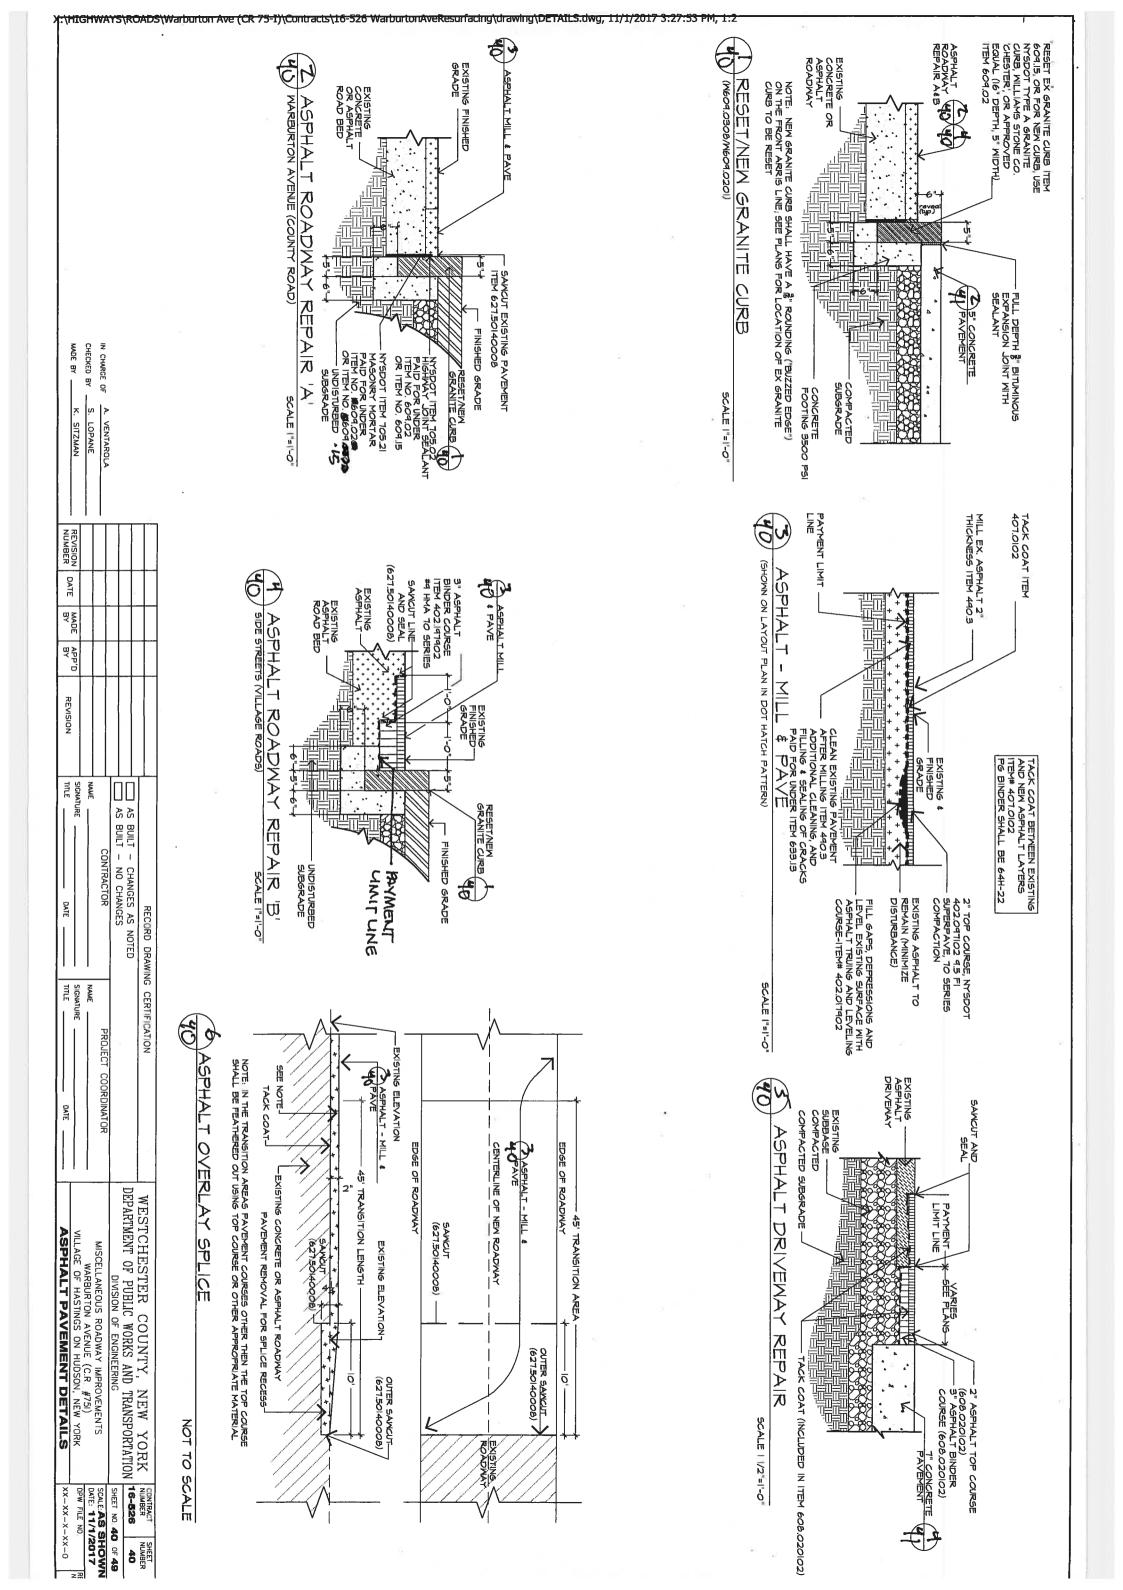


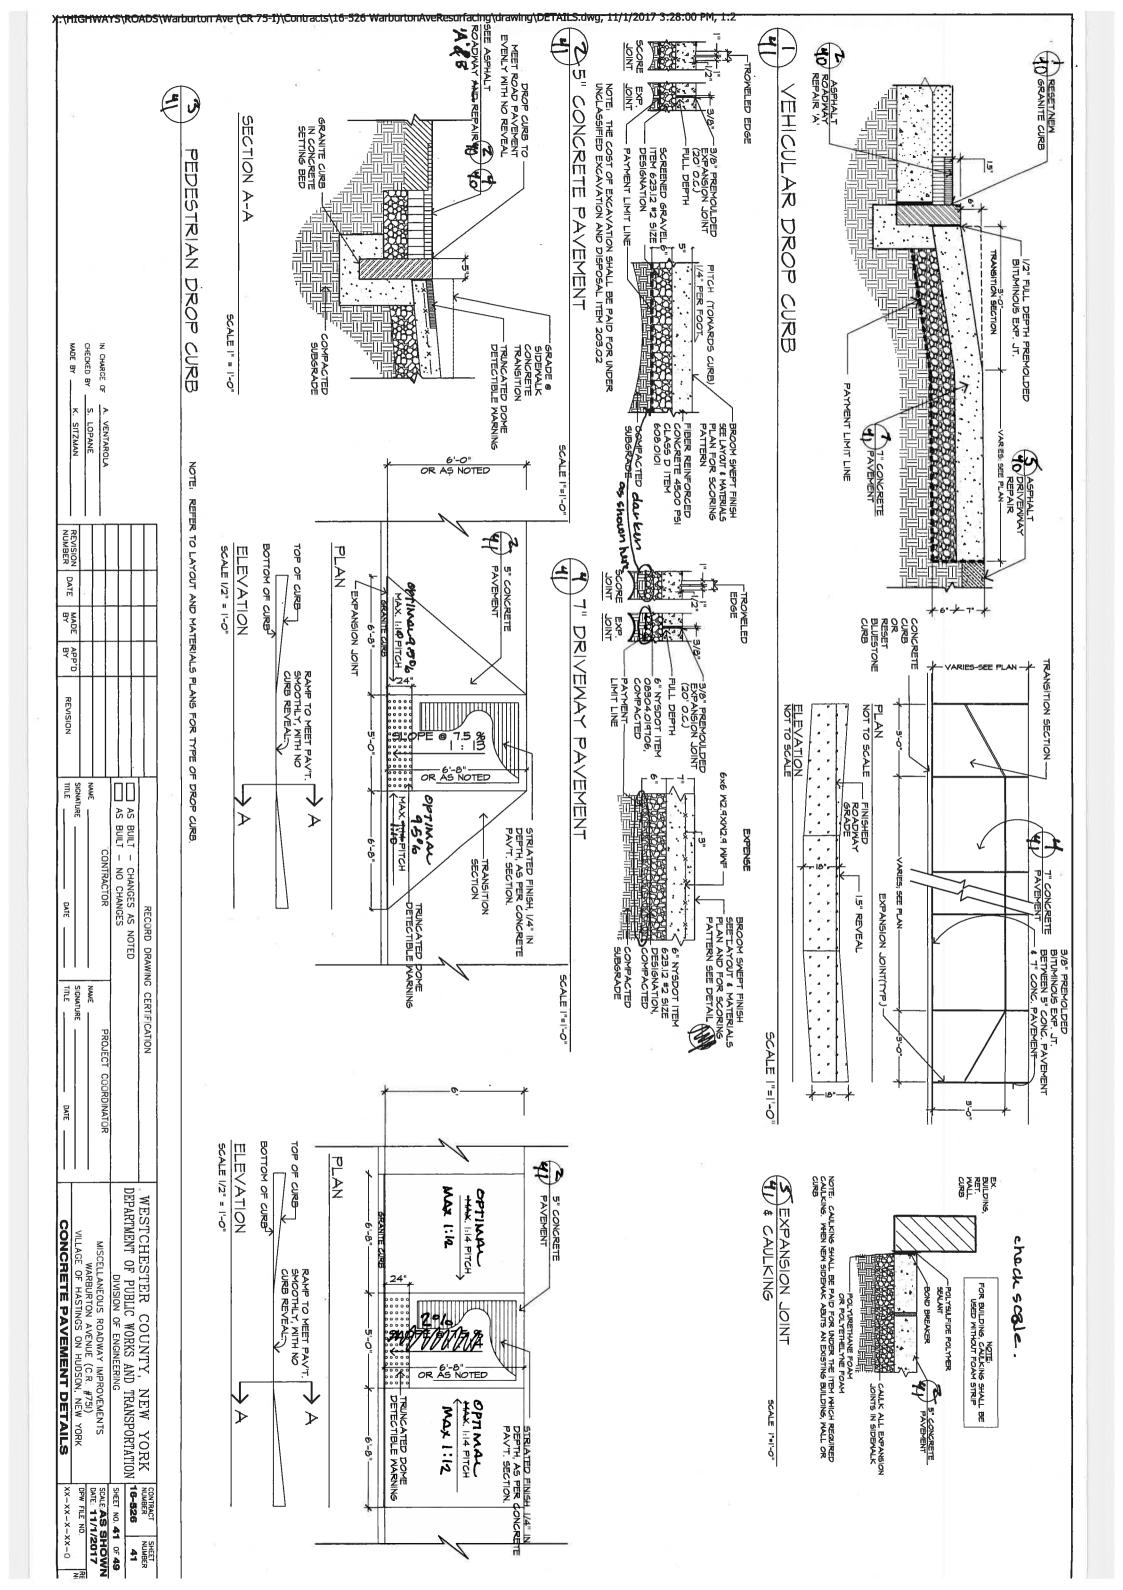


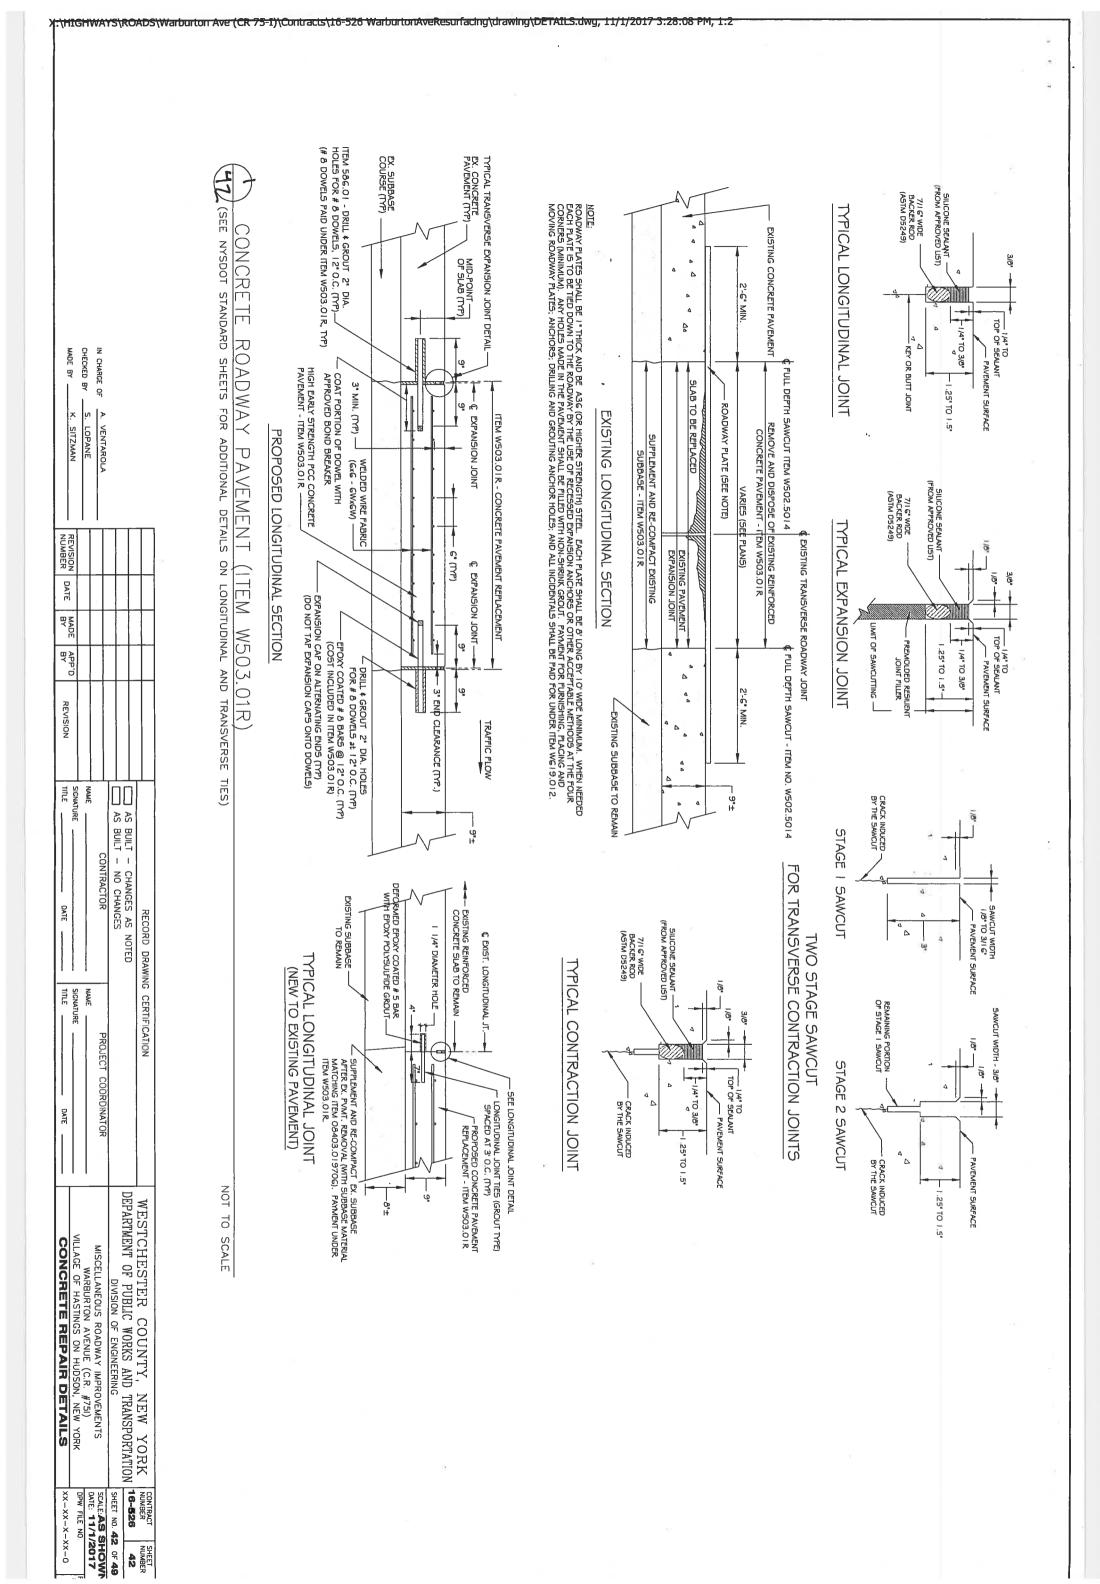



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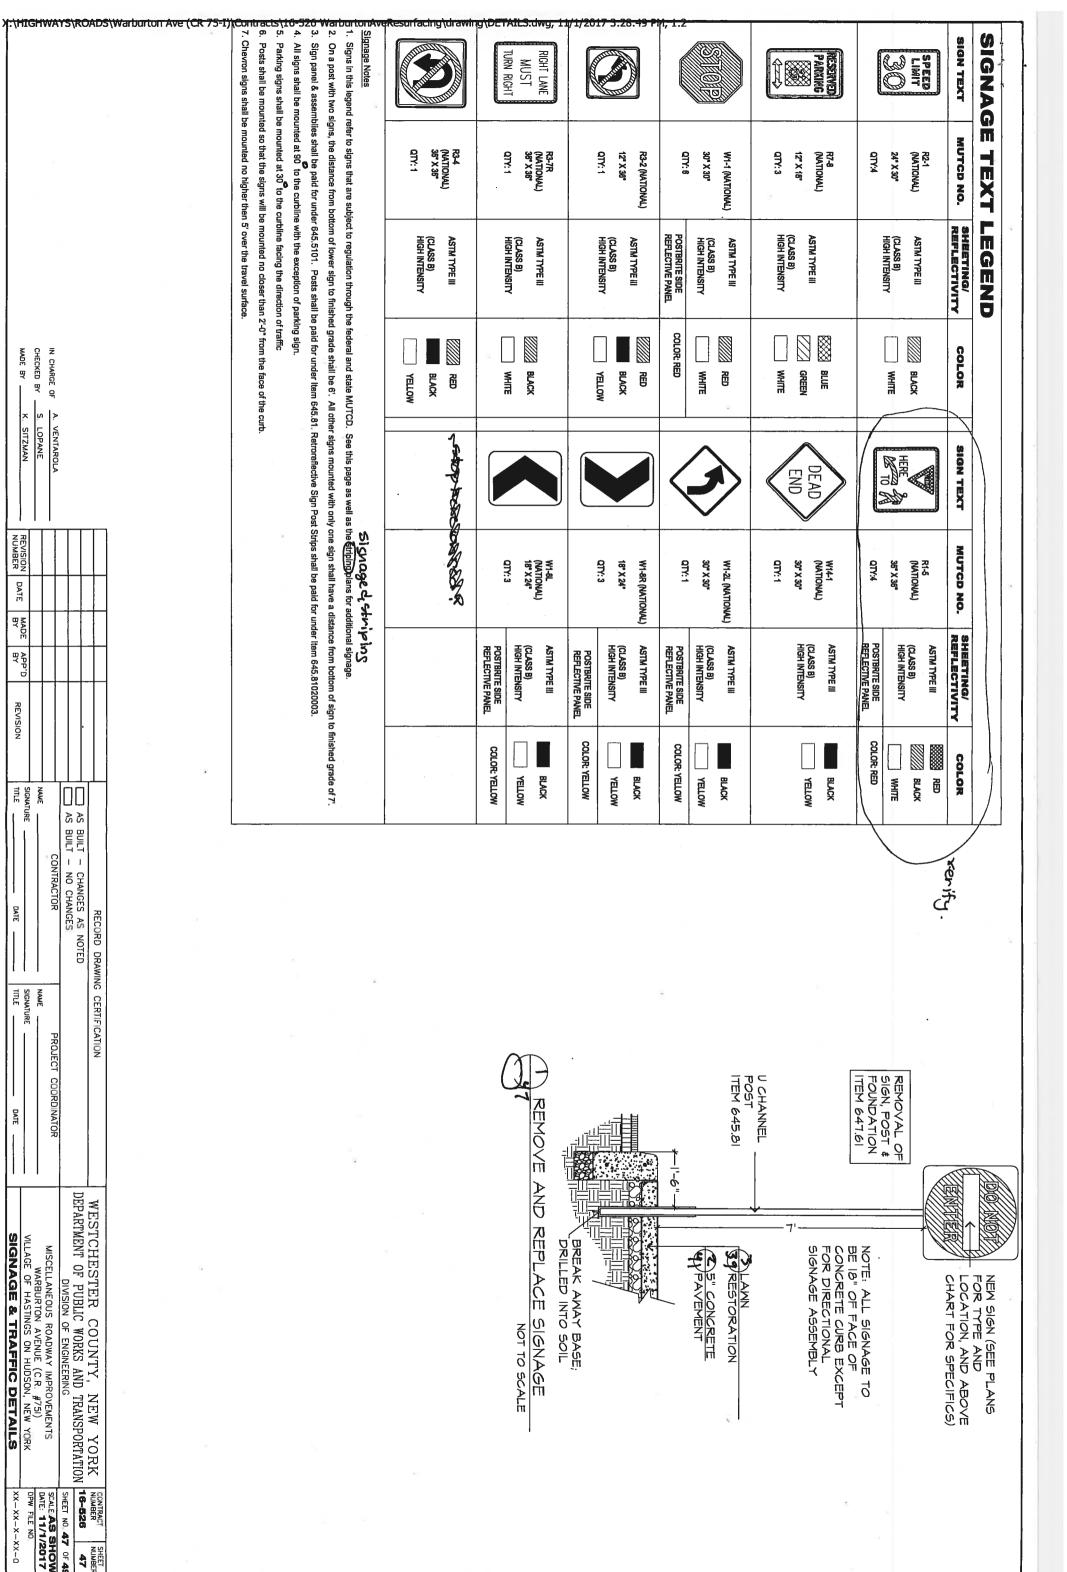
SHEET NUMBER 42



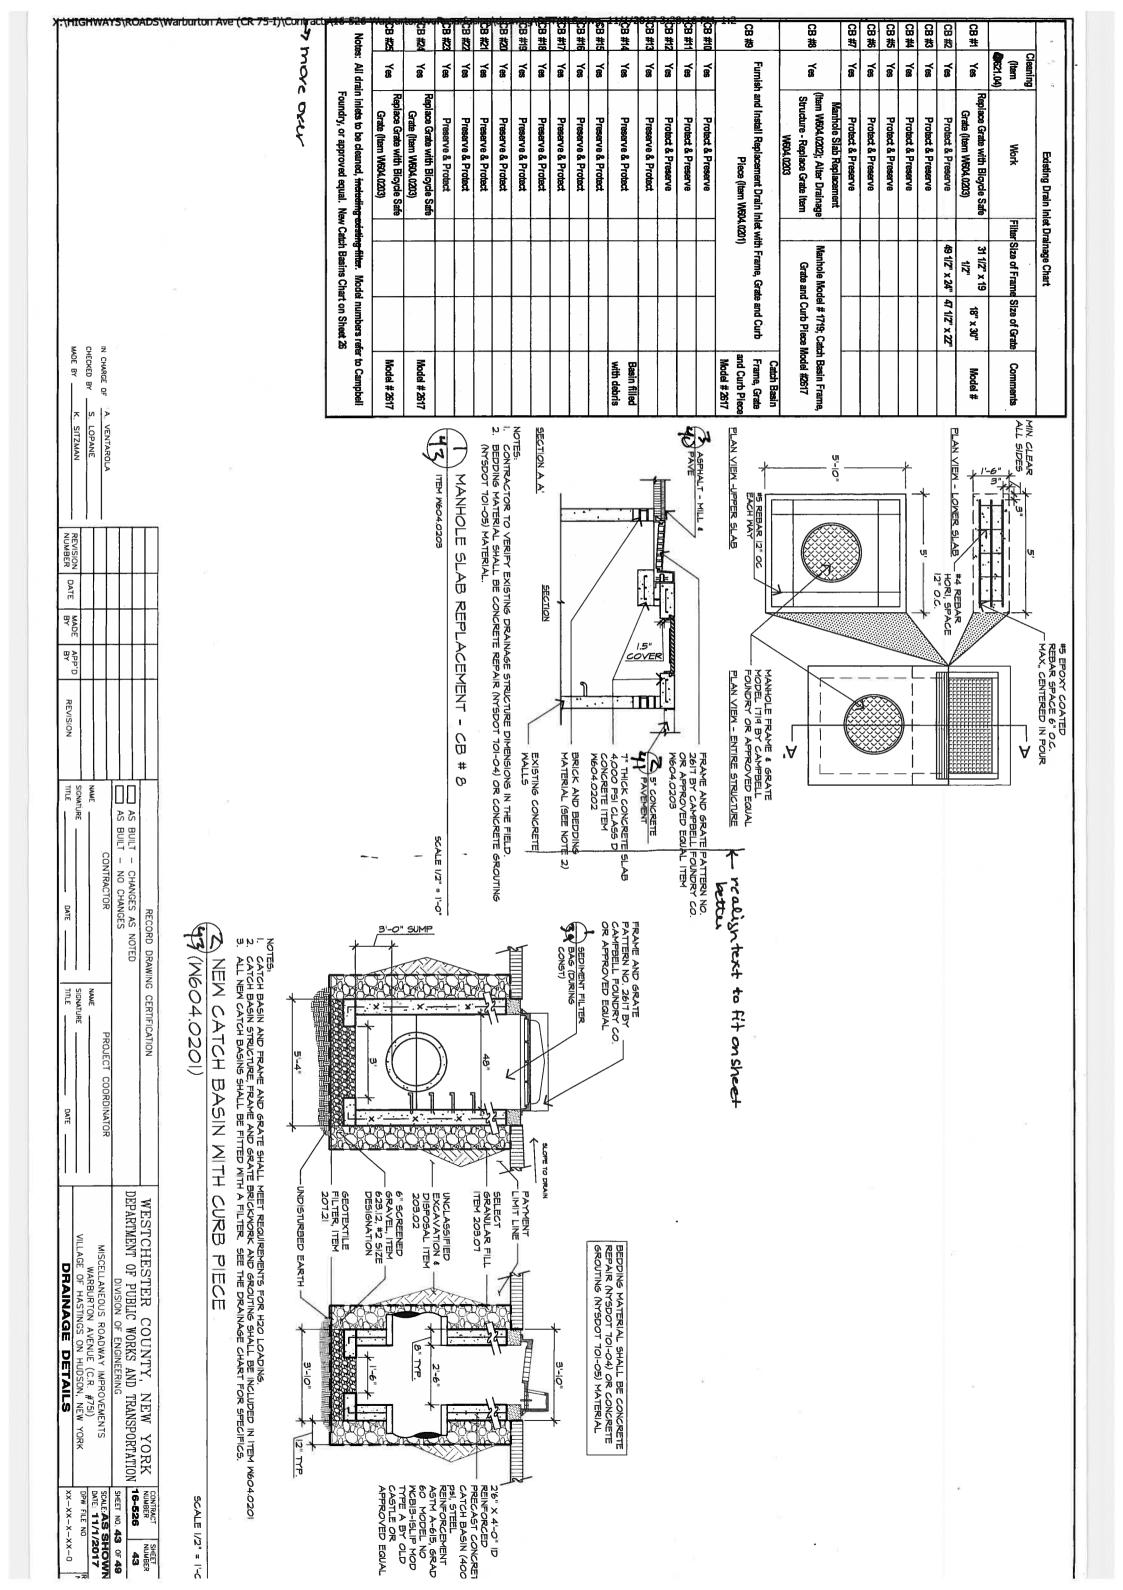

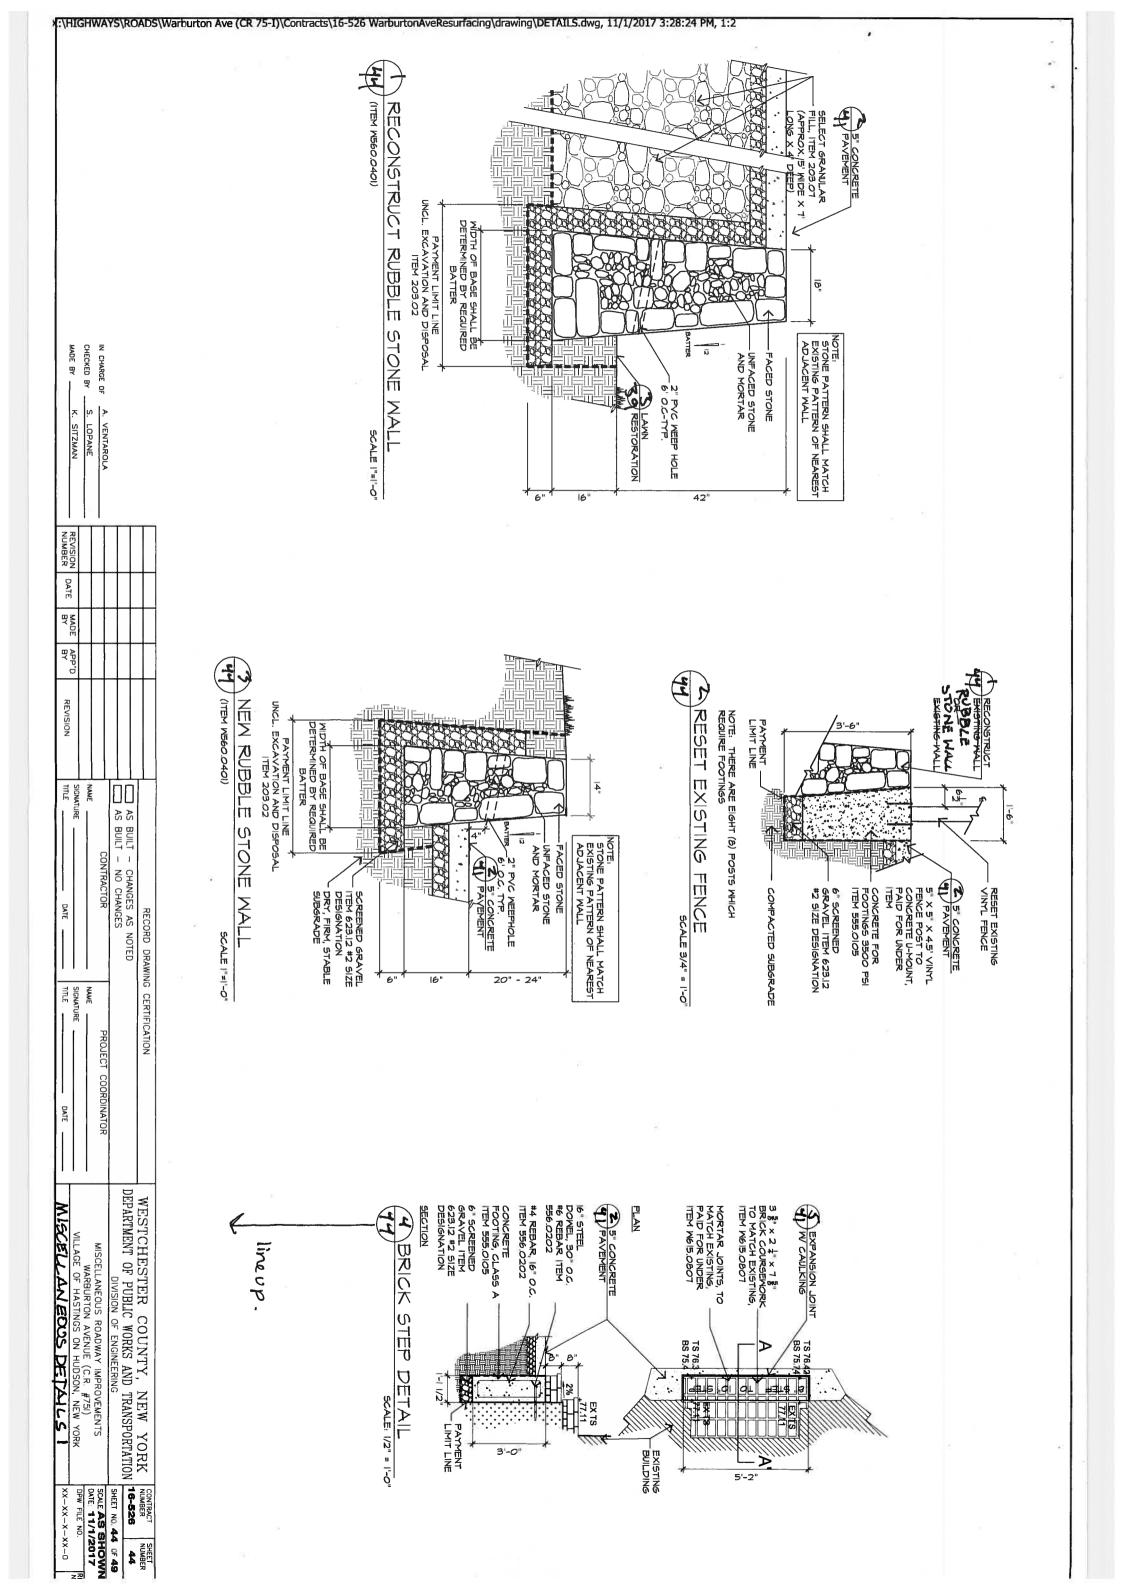

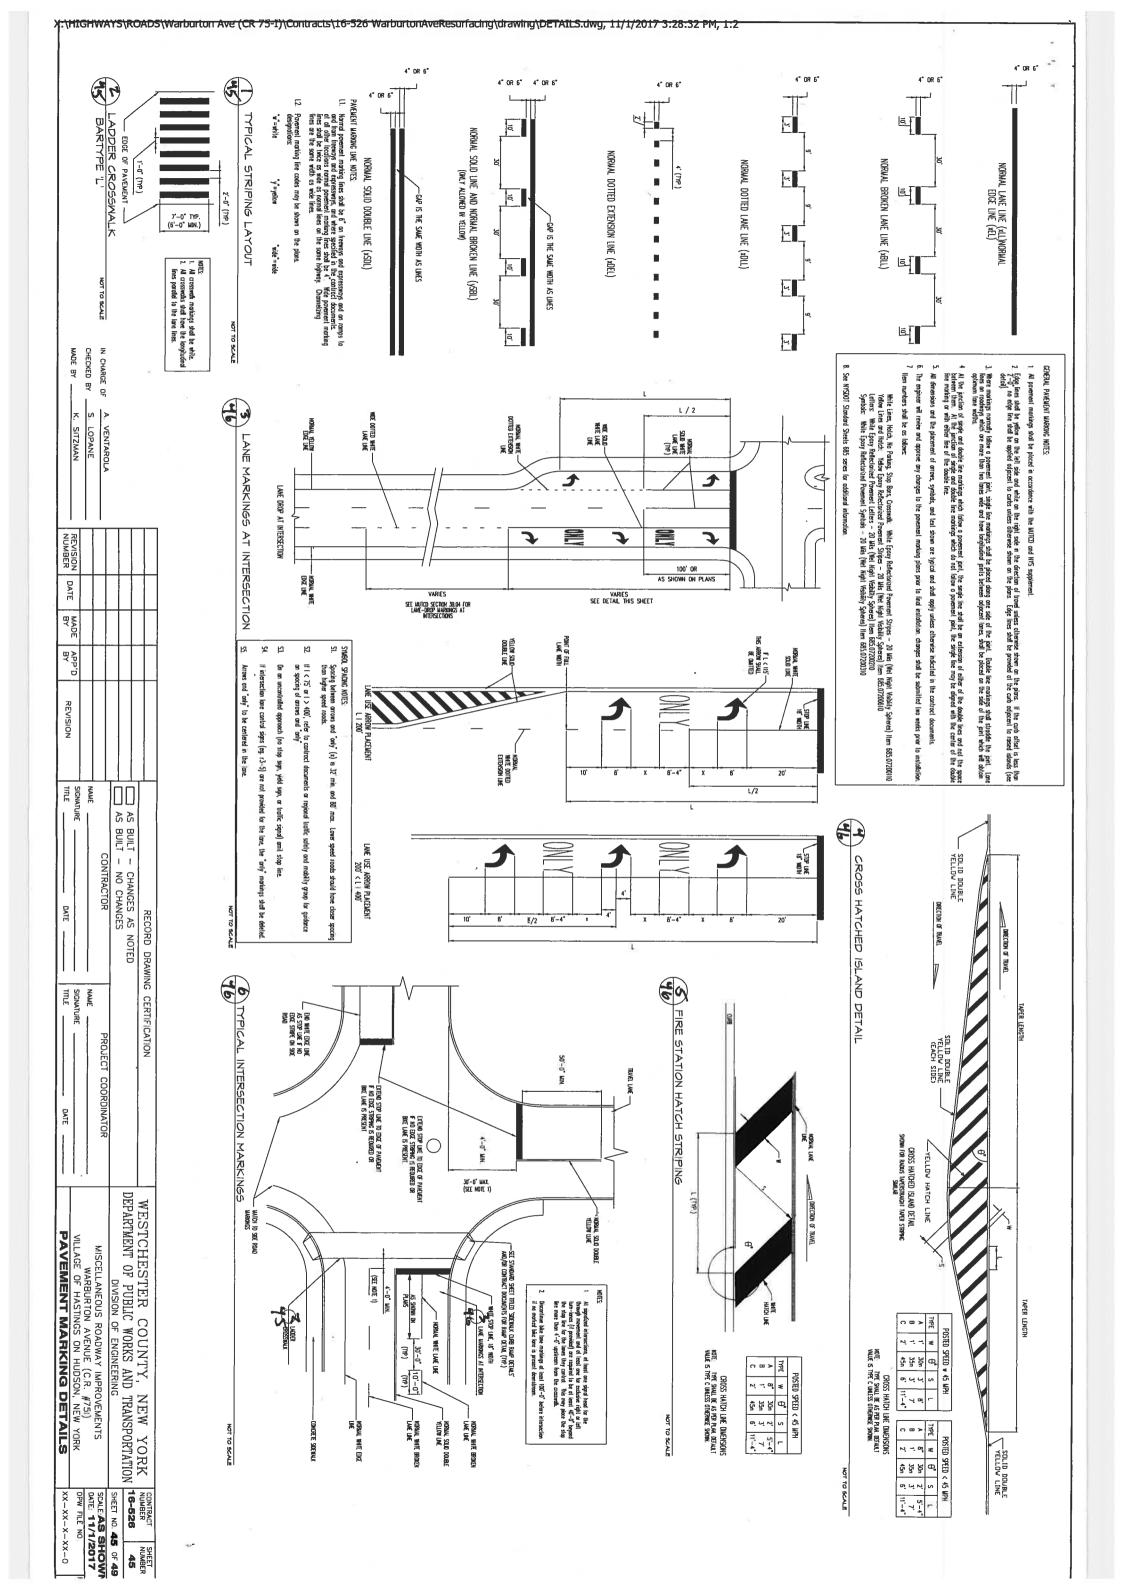

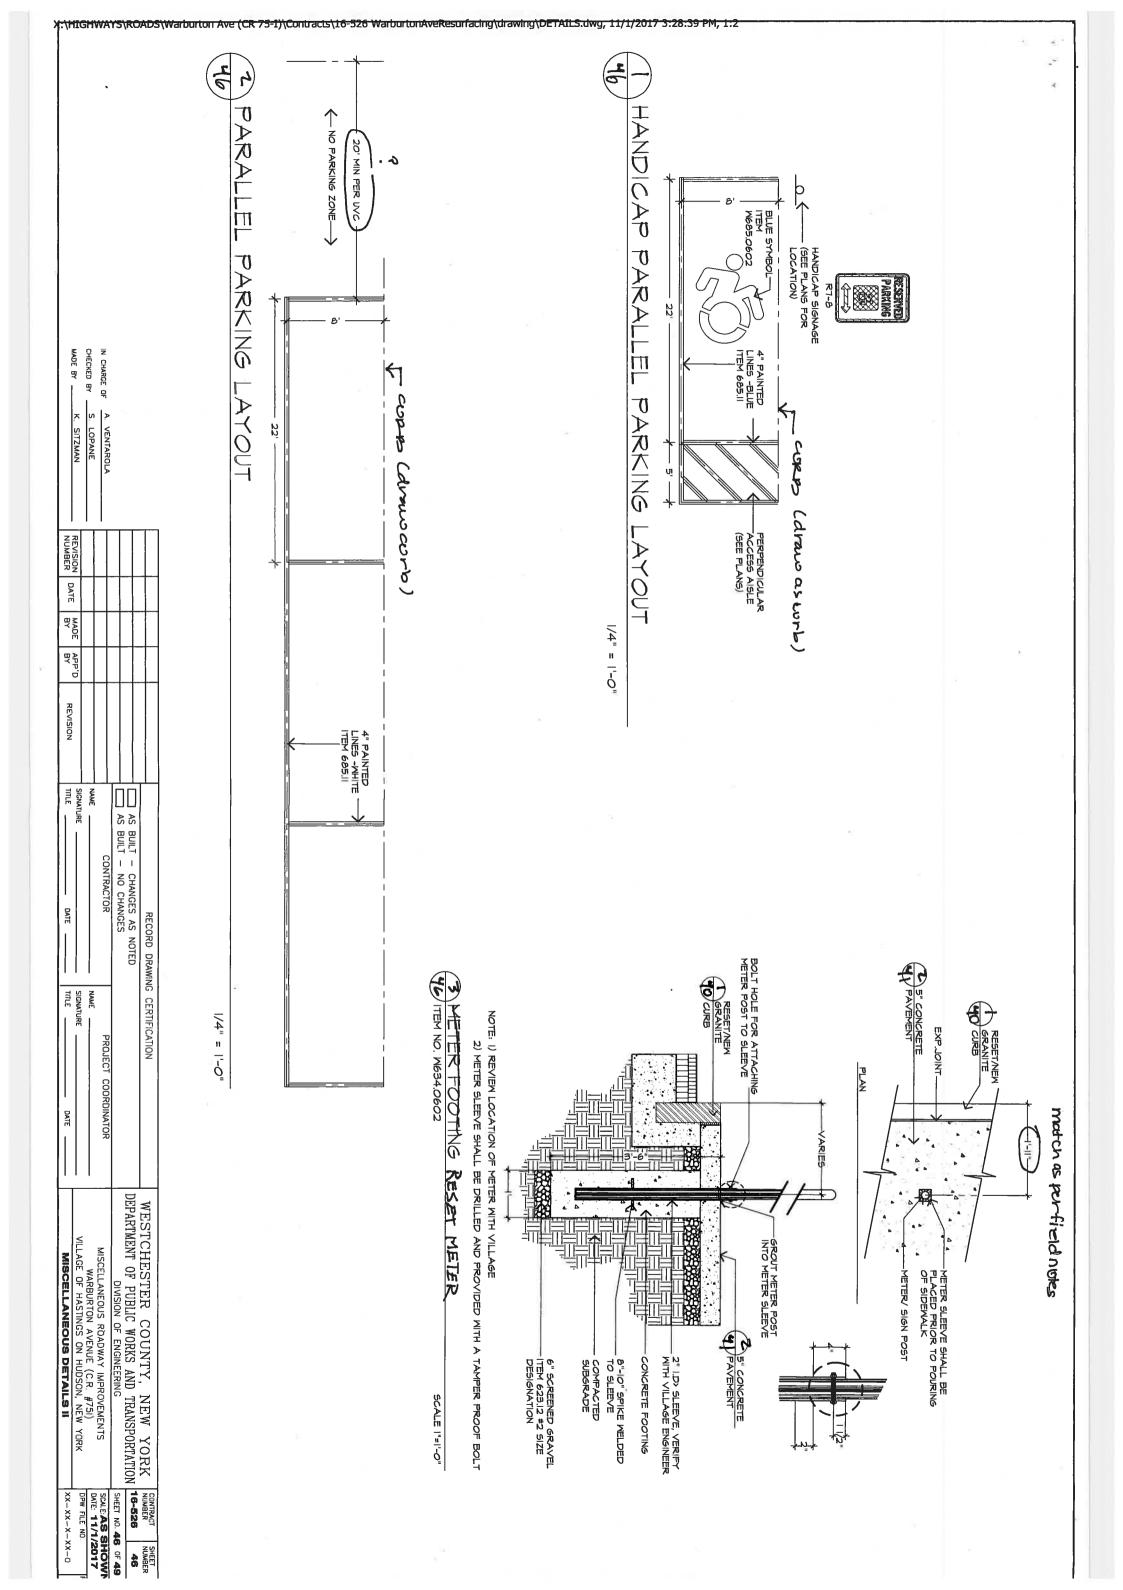

CHECKED BY ___ IN CHARGE OF

S, LOPANE A. VENTAROLA

K SITZMAN

REVISION NUMBER

DATE

MADE BY

APP'D

REVISION

SIGNATURE TITLE

DATE

SIGNATURE

DATE

COORDINATOR

DEPARTMENT OF PUBLIC WORKS AND TRANSPORTATION

DIVISION OF ENGINEERING

NUMBER

OF STATEMENT OF PUBLIC WORKS AND TRANSPORTATION

SHEET NO. 4

MISCELLANEOUS ROADWAY IMPROVEMENTS
WARBURTON AVENUE (C.R. #75I)
VILLAGE OF HASTINGS ON HUDSON, NEW YORK SIGNAGE & TRAFFIC DETAILS

XX-X-X-XX-D

SCALE AS SHOWN DATE: 11/1/2017 SHEET NO. 47 OF 49

SHEET NUMBER 47

NAME

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AS AS

BUILT - CHANGES AS NOTED BUILT - NO CHANGES CONTRACTOR

RECORD DRAWING CERTIFICATION

MADE BY

